

DeKalb County Zoning Board of Appeals

Department of Planning & Sustainability 330 Ponce De Leon Avenue, Suite 300 Decatur, GA 30030



Michael L. Thurmond

Chief Executive Officer

Wednesday, February 10, 2021 at 1:00 PM

Planning Department Staff Analysis

N2 Case No: A-21-1244565 Parcel ID(s): 18-001-09-004

Commission District: 02 Super District 06

Applicant: Michael Streger

1800 Lake Park Drive, Suite 200

Smyrna, GA 30080

Owner: Susan Clare

1339 Chalmette Drive Atlanta, GA 30306

Project Name: 1339 Chalmette Drive

Location: The property is located south of Chalmette Drive, at 1339 Chalmette Drive Atlanta, GA 30306.

REQUEST: Variances from Chapter 27-2.2 Division 2- Residential Zoning Districts: Dimensional Requirements of

the DeKalb County Zoning Ordinance to (1) increase the maximum allowed lot coverage from 35% to

46.32%, and (2) to reduce the western side yard setback from 7.5 feet to 5 feet for a proposed

swimming pool and rear addition, relating to the R-75 zoning district.

Staff Denial.

Recommendation:

STAFF FINDINGS:

Variance Analysis:

The subject property is located within the R-75 (Residential Medium Lot-75) Zoning District. Per Chapter 27-2.2 Division 2-Residential Zoning Districts: Dimensional Requirements of the *DeKalb County Zoning Ordinance*, the minimum lot area for R-75 zoned properties is 10,000 square feet, and the minimum lot width is 75 feet. Based on the submitted site plan, the subject property has a lot size of 13,697 square feet and a lot width of 70 feet, therefore, the subject property is legally, non-conforming.

Based on the submitted materials, the applicant is proposing to install a 336 square foot swimming pool in the rear of the existing two-story home, along with additional patio space, a fireplace, and grilling area. Based on the submitted site plan, the proposed additions will increase the impervious area approximately 11.32% over the maximum allowed lot coverage of 35%. The existing lot coverage on the subject property is 35.75%. The applicant is also requesting a second variance to reduce the western side yard setback from 7.5 to 5 feet.

Based on the submitted site plan, the requested variances may go beyond the minimum necessary to afford relief and may constitute a grant of special privilege inconsistent with the limitations upon other properties in the zoning district in which the subject property is located. Therefore, the requested variances may not be consistent with the criteria of approval, as listed below:

1. By reason of exceptional narrowness, shallowness or shape of a specific lot, or by reason of exceptional topographic conditions, which were not created by the owner or applicant, the strict application of the requirements of this chapter would deprive the property owner of rights and privileges enjoyed by other property owners in the same zoning district:

Based on the submitted materials, the strict application of the requirements of this chapter may not deprive the property owner of rights and privileges enjoyed by other property owners. Although the subject lot is legally, non-conforming based on its width, the buildable area appears to contain reasonable space for the accommodation of the proposed accessory structure and site improvements.

2. The requested variance does not go beyond the minimum necessary to afford relief, and does not constitute a grant of special privilege inconsistent with the limitations upon other properties in the zoning district in which the subject property is located:

It appears that the requested variance may go beyond the minimum necessary to afford relief since the requested variance is 11% greater than the minimum allowed lot coverage. Therefore, granting this variance may constitute a grant of special privilege inconsistent with the limitations upon other properties in the zoning district in which the subject property is located.

3. The grant of the variance will not be materially detrimental to the public welfare or injurious to the property or improvements in the zoning district in which the subject property is located:

Based on the submitted materials, it appears that granting the variance may not be materially detrimental to the public welfare or injurious to the property or improvements in the zoning district since the bulk of the improvements are proposed behind the existing home. The applicant's letter of intent states "not reflected on the plan, but there will be full plantings to help soften/buffer the grill and fireplace located between those components and the property line/fence." Additionally, the applicant explains "the additional impervious square footage mentioned will be mitigated by capturing stormwater from the residence's downspouts into Flo-wells (dry wells). This system allows subsurface containment and slow release.

4. The literal interpretation and strict application of the applicable provisions or requirements of this chapter would cause undue and unnecessary hardship:

Based on the submitted materials, the strict application of the applicable provisions and requirements of this chapter may not cause an undue hardship for the applicant.

5. The requested variance would be consistent with the spirit and purpose of this Chapter and the DeKalb County Comprehensive Plan Text:

Based on the submitted materials, it appears that the requested variance may be inconsistent with the spirit and purpose of this chapter and the DeKalb County Comprehensive Plan text.

FINAL STAFF ANALYSIS:

Considering the lot size and the parameters of existing lot coverage and setback requirements, the proposed improvements may be feasible without the requested relief. Therefore, granting this variance may constitute a grant of special privilege inconsistent with the limitations upon other properties in the zoning district in which the subject property is located. Therefore, the Department of Planning and Sustainability recommends denial of the requested variances.

In the event the Board approves the requests, Staff recommends the following condition:

1. The applicant shall install a dry well system, rain garden, and/or other sustainable means of stormwater mitigation, as approved by the County Land Development Division.

DeKalb County Department of Planning & Sustainability

Hon. Michael Thurmond Chief Executive Officer

Andrew Baker, AICP, Director

ZONING BOARD OF APPEALS APPLICATION FOR PUBLIC HEARING (VARIANCES, SPECIAL EXCEPTIONS, APPEALS OF ADMINISTRATIVE DECISIONS)

				BOA No	
Applicant and/or Authorized Represe	_{ntative} Michael Strege	r			
	800 Lake Park Dr, Su		Smyrna, GA	30080	
City/State/Zip Code	Smyrna, GA 30080			_	
Email: Michael@L	DCon.net				
Telephone Home: _		Busine	ss: 404-597-8	8839 _{Fax No.:_}	
	OWNER O	F RECOR	D OF SUBJEC	T PROPERTY	
Owner: Susan Cl	are			_	
Address (Mailing):	1339 Chalmette Drive)			
City/State/Zip Code	Atlanta, GA 30306				
Email: sclare06@	gmail.com				
Telephone Home: _		Busine	ss:	Fax No	.:
	ADDRESS	S/I OCATIO	N OF SUBJEC	T PROPERTY	
Address: 1339 Ch	nalmette Drive				Zip: 30306
District(s): 18	Land Lot(s): 12		Block: C	Parcel:	18-001-09-004
District(s):	Land Lot(s):		Block:	Parcel:	
District(s):	Land Lot(s):		Block:	Parcel:	
Zoning Classificatio	n: R-75		Commission E	District & Super Dist	trict:
CIRCLE TYPE OF	HEARING REQUESTED				
VARIANCE (From	Development Standards	causing un	due hardship uր	pon owners of prop	erty.)
• SPECIAL EXCEP	TIONS (To reduce or waiv	e off-street	parking or load	ding space requiren	nents.)
• OFFICIALS APPE	ALS OF ADMINISTRATIV	/E DECISION	ONS.		
TO BE COMPLETED BY Date Received:	Y PLANNING AND SUSTAINAE	BILITY DEPAI	RTMENT	Fee Paid:	



2

ZONING BOARD OF APPEALS APPLICATION AUTHORIZATION OF THE PROPERTY OWNER

I hereby authorize the staff and members of the Zoning Board of Appeals

To inspect the premises of the Subject Property

I hereby certify that the information provided in the application is true and correct.

I hereby certify that I am the owner of the property subject to the application.

DATE:	Applicant: Signature Susan M. Clau	•
DATE:	Applicant:Signature	

404.371.2155 (o) 404.371.4556 (f) DeKalbCountyGa.gov Clark Harrison Building 330 W. Ponce de Leon Ave Decatur, GA 30030

DEPARTMENT OF PLANNING & SUSTAINABILITY

ZBOA APPLICATION AUTHORIZATION

Completion of this form is required if the individual making the request is <u>not</u> the owner of the property.

DATE_ 1-4-2021	
CHECK TYPE OF APPLICATION:	
() ADMINISTRATIVE APPEAL	
VARIANCE	
() SPECIAL EXCEPTION	
TO WHOM IT MAY CONCERN:	
(I) / (WE), Susan Clare	
	me of owner(s)] elow or attached hereby delegate authority to
Michael Streger	
	licant or Representative]
to file an application on (num) (our) behalf.	Susan M. Clau
Notary Public PUBLIC ON THE CONTROL OF THE CONTROL	Owner
	Owner
Notary Public	Owner

LETTER OF INTENT FOR VARIANCE (SECTION 27)

January 5, 2021

Dear Zoning Board of Appeals,

We are requesting lot coverage and side-interior building setback variances (27-2.2 Division 2-Residential Zoning Districts: Dimensional Requirements, Section 2.2.1) for the residence located at 1339 Chalmette Drive. This is the home of the Clare family.

The property contains a house, driveway, and necessary sidewalks to the home. These existing components yield an impervious total areas of 35% of the total lot, being the maximum lot coverage allowed in this zoning. The Clare family is proposing to add a pool, some surrounding patio, fireplace, and grilling area. These additions would yield approx. 1,560 sq. feet of impervious surface. This is approx. 11.32% over the maximum lot coverage, therefore we understand variance is necessary.

In attempt to keep the design footprint efficient and small as possible (while still successfully fulfilling the use intent) the grill area and fireplace have been "nudged back" some toward the side property line, causing an encroachment into the side setback. Approx. 2.67 feet. We again understand this required a variance. Not reflected on the plan, but there will be full plantings to help soften / buffer the grill and fireplace located between those components and the property line / fence.

Several variations of the design were considered and worked through, but the current proposed design seemed to be the most efficient use of space with the least overall impact. As part of the proposed design, the additional impervious square footage mentioned will be mitigated by capturing stormwater from the residence's downspouts into Flo-wells (dry wells). This system allows subsurface containment and slow release.

They Clare's immensely enjoy this friendly neighborhood in Dekalb County but have grown more aware of the lack of usable outdoor space they have. A hardship that needed to be considered when conceptualizing this new space was making sure the selected surfaces offered safe passage. Mrs. Clare had an ankle injury a few years ago that has continued to cause significant issues with her with stability and navigating uneven surfaces. In addition to Mrs. Clare's challenge, the Clare's do have elderly parents that regularly visit. The intent to was to use a solid fairly smooth surface that again would be easier to navigate and give safe passage, vs. using an uneven paver or material that would have large gaps. Important to mention, and part of the introduction of this component is the therapeutic benefit of the pool for Mrs. Clare's ankle injury.

Thank you for your consideration,


Michael Streger, PLA

Land Design and Consulting, LLC

CLARE RESIDENCE

HARDSCAPE PLANS


SUSAN AND BEN CLARE

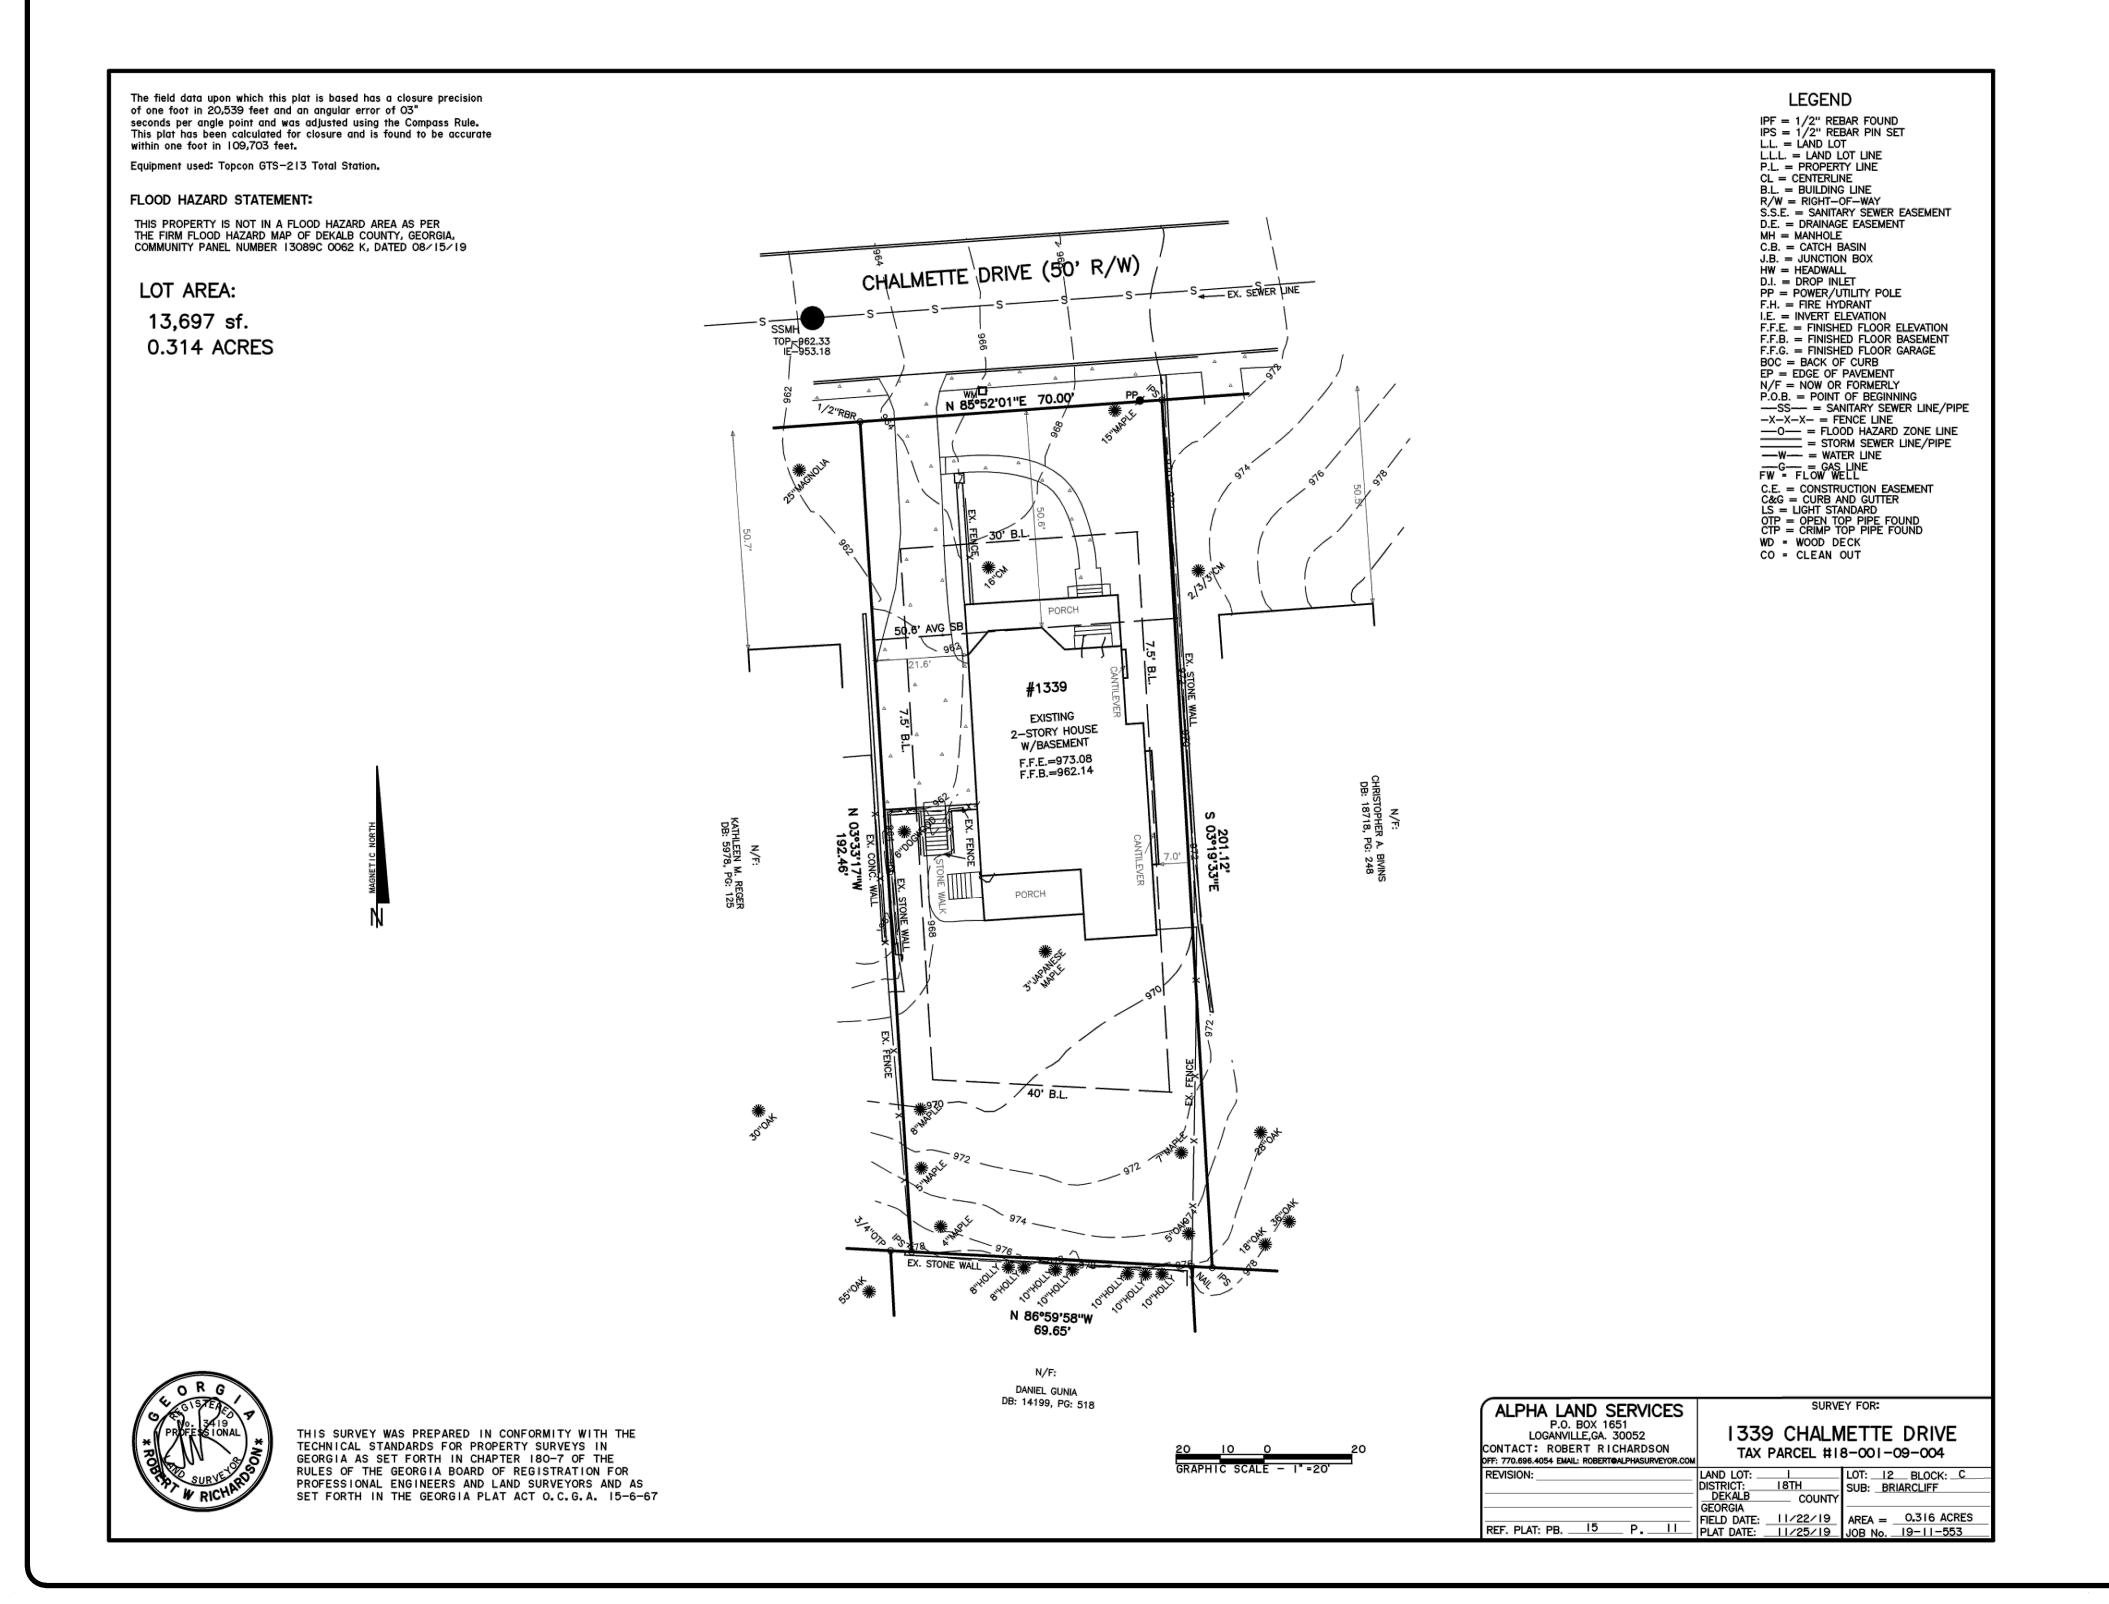


NOTES:

-This project to demonstrate compliance with grade separation and positive drainage requirements of the International Residential Code R401.3, R403.1.7.3 and R404.1.6

OVERALL MAP

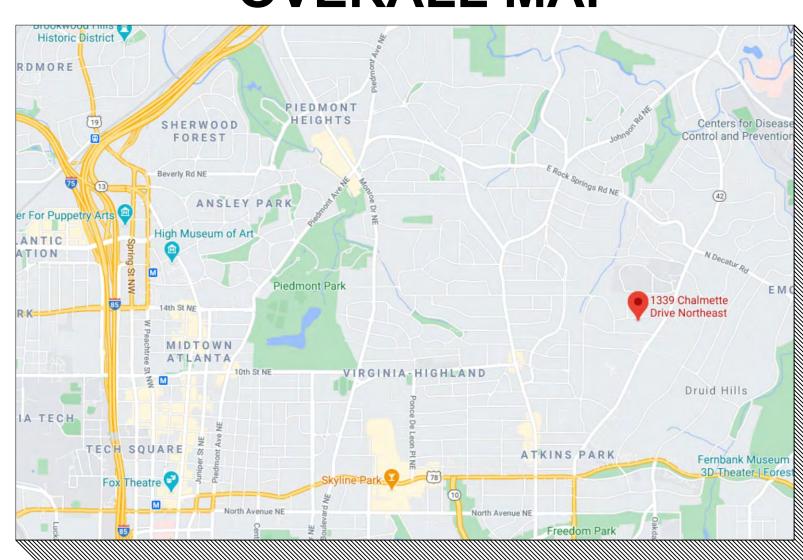


LOCATION MAP

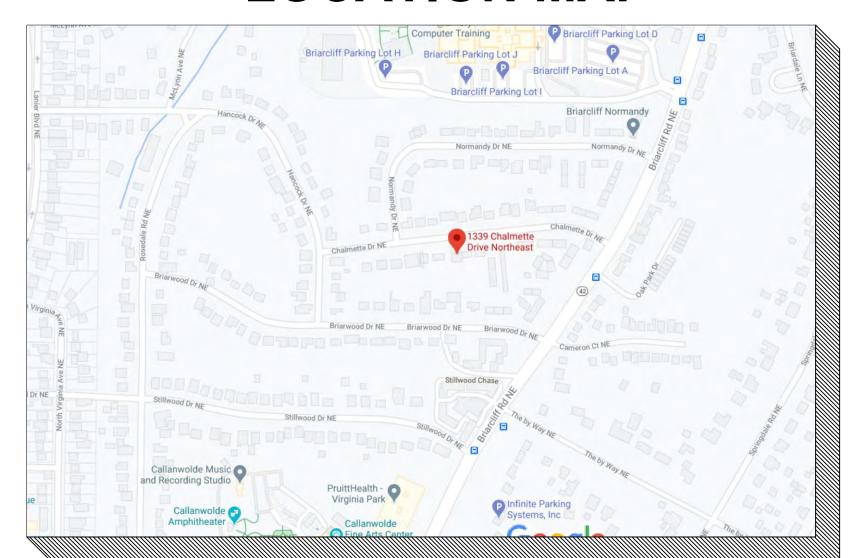

SHEET INDEX:

SHT#	DESCRIPTION	
CP-1.0	COVER PAGE/ EXISTING CONDITIONS	
HS-1.0	HARDSCAPE LABELING PLAN	
HS-2.0	DIMENSIONING PLAN	
HS-3.0	GRADING / DRAINAGE PLAN	
TP-1.0	TREE PROTECTION PLAN	
PL-1.0	POOL PLAN	
PL-2.0	POOL DETAILS	
DT-1.0	DETAILS	
DT-2.0	DETAILS	
DT-2.1	GRILL STATION DETAILS	
DT-3.0	DETAILS	
DR-1.0	DRAINAGE PLAN	
DR-2.0	DRAINAGE PLAN	
DR-3.0	FLO-WELL SPECIFICATIONS	

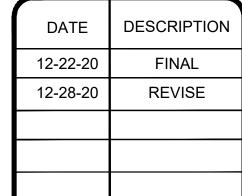



Z COUNTY

HARDSCAPE PLANS
1339 CHALMETTE DRIVE - ATLANTA, GEORGIA 30306 - D

LAND

678.503.0390-0


AND CONSULTING, LLC

COVER PAGE/ EXISTING CONDITIONS

VARIES

SHEET NUMBER

CP-1.0

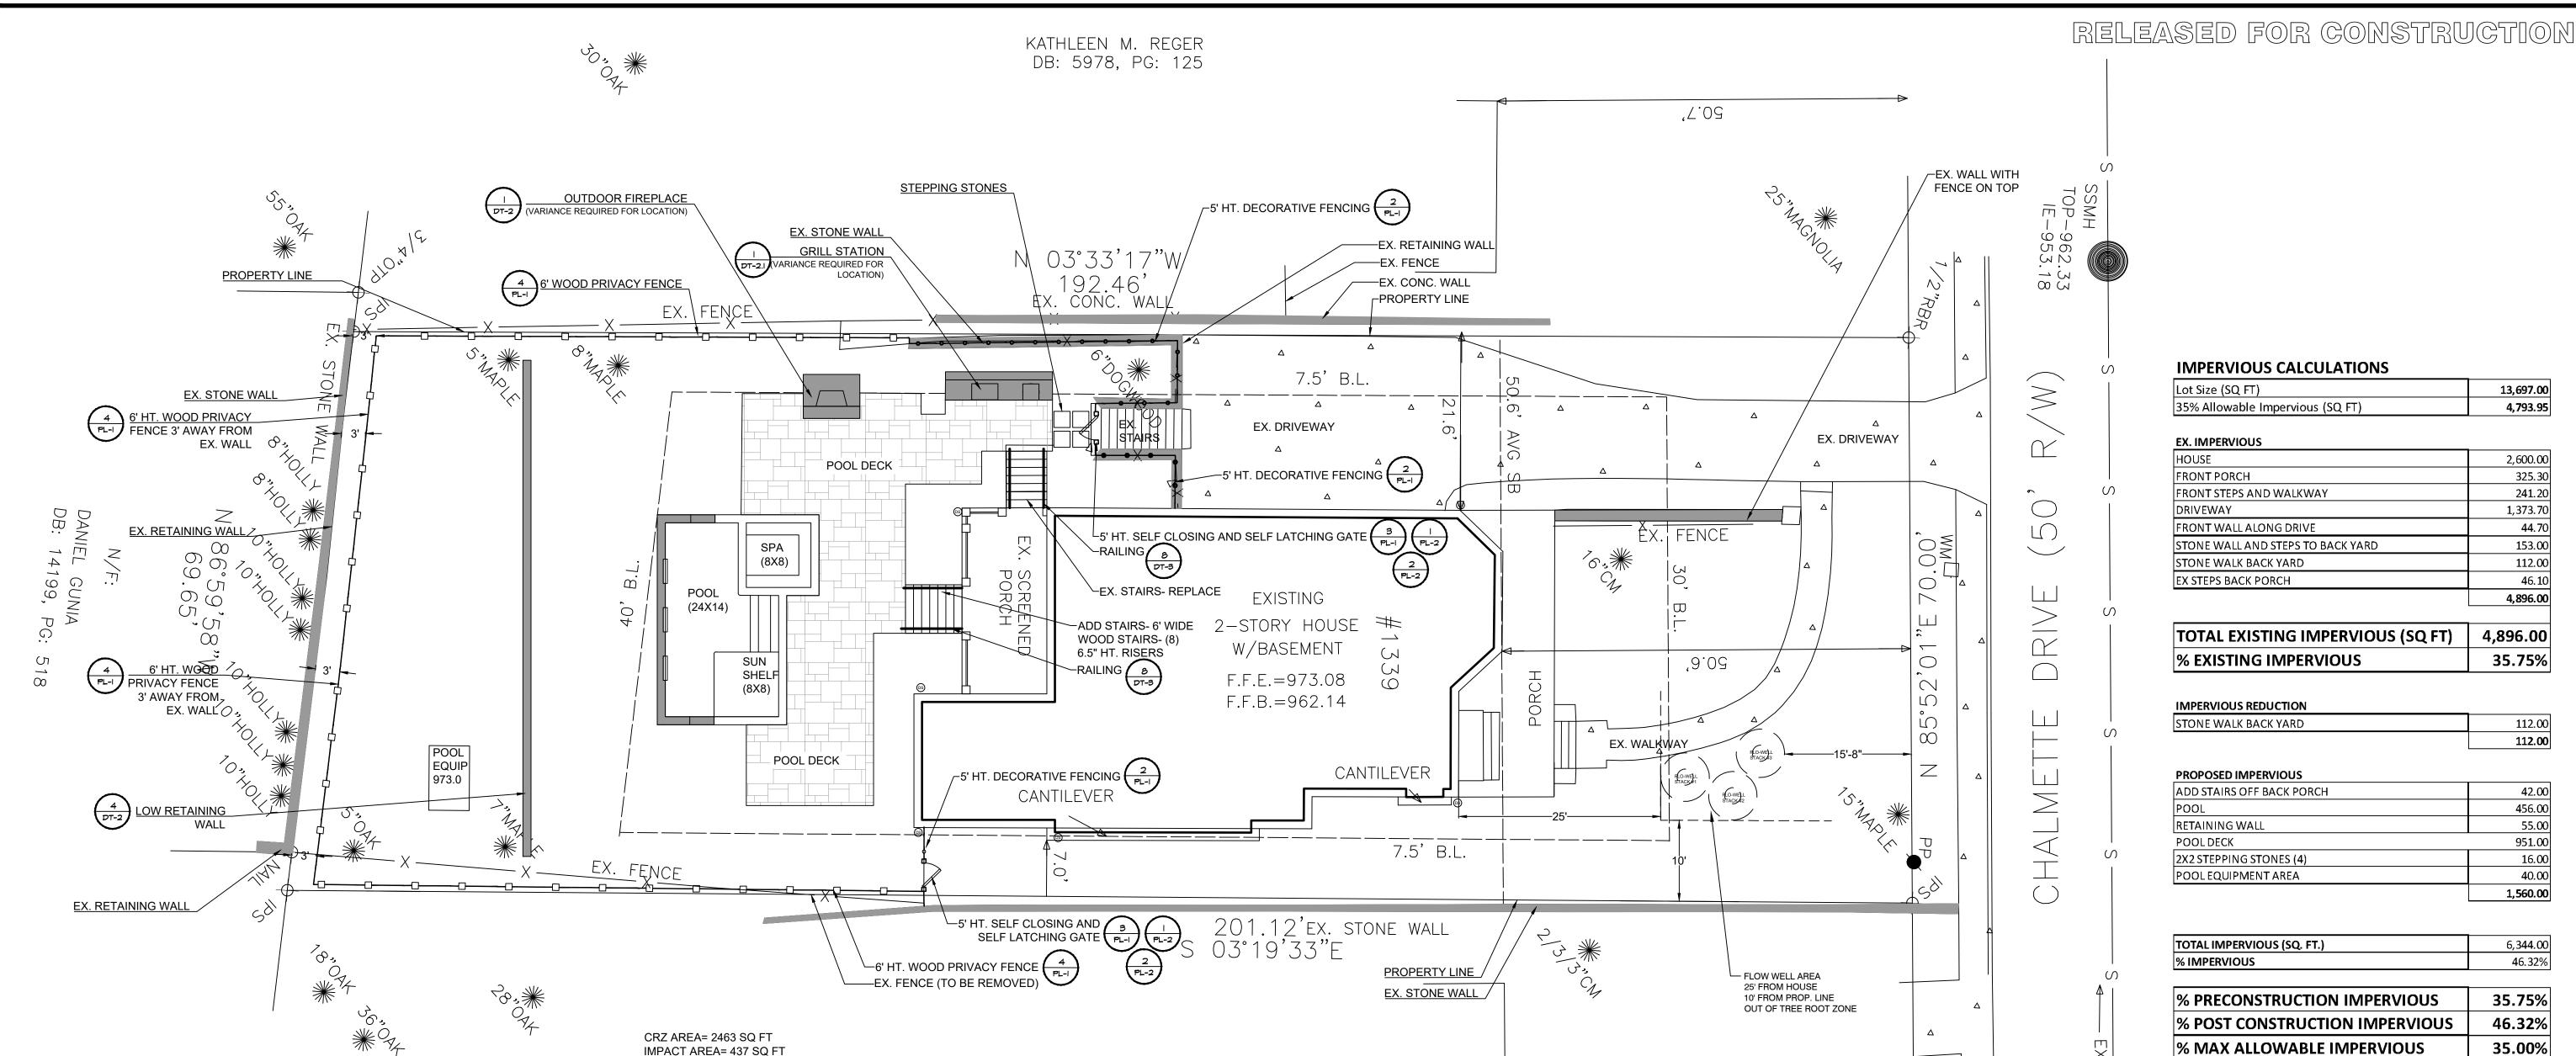

% MAX ALLOWABLE IMPERVIOUS % OVER MAX IMPERVIOUS SQ. FEET OVER MAX IMPERVIOUS **ACREAGE INFORMATION**

TOTAL LOT SIZE (SQ FT): 13,697 TOTAL DISTURBED AREA (SQ FT): 6,000

FEET OF THE PROJECT SITE.

WATERS OF THE STATE NOTE: NO WATERS OF THE STATE EXIST WITHIN 200

IMPERVIOUS CALCULATIONS

35% Allowable Impervious (SQ FT)

FRONT STEPS AND WALKWAY

STONE WALL AND STEPS TO BACK YARD

% EXISTING IMPERVIOUS

TOTAL EXISTING IMPERVIOUS (SQ FT)

FRONT WALL ALONG DRIVE

STONE WALK BACK YARD

IMPERVIOUS REDUCTION

STONE WALK BACK YARD

PROPOSED IMPERVIOUS

2X2 STEPPING STONES (4)

TOTAL IMPERVIOUS (SQ. FT.)

% PRECONSTRUCTION IMPERVIOUS

% POST CONSTRUCTION IMPERVIOUS

POOL EQUIPMENT AREA

RETAINING WAL POOL DECK

% IMPERVIOUS

ADD STAIRS OFF BACK PORCH

EX STEPS BACK PORCH

Lot Size (SQ FT)

EX. IMPERVIOUS

FRONT PORCH

DRIVEWAY

DIRT STATEMENT:

- **Cut: 18 Cubic Yards**
- Fill: 9 Cubic Yards
- **Total Removed From Site: 9 Cubic Yards**

SITE DATA: Tax Parcel ID: 18-001-09-004 12 Land Lot: 18

District: Zoning: Acreage:

0.314 ACRES 1339 Chalmette Drive Address: ATLANTA 30306

DEKALB COUNTY SUSAN AND BEN CLARE Owner:

R-75

24 Hour contact: Adam Ardoin 404-556-8691 LAND

AND CONSULTING, LLC

678.503.0390-0

LABELING PLAN

SCALE

1"=10'

SHEET NUMBER

HS-1.0

DESCRIPTION

FOR REVIEW

FINAL

REVISE

12-21-20

12-22-20

12-28-20

13,697.00

4,793.95

2,600.00

325.30

241.20 1,373.70

44.70

153.00

112.00

46.10

4,896.00

4,896.00

35.75%

112.00

112.00

42.00

456.00 55.00

951.00

16.00

40.00 1,560.00

6,344.00

35.75%

46.32%

35.00%

11.32%

1550.05

46.32%

- Lots and buildings shall be developed in a manner to ensure that stormwater exiting individual parcels or lots under post developed conditions does not adversely impact the adjacent parcels or lots as a result of concentrated flows,
- flooding, erosion, or deposits of silt or sediment. - The stormwater discharge from a downspout, cistern, or any water collection device shall be located a distance of no less than ten feet from common property line and oriented so direction of concentrated flow is not toward the adjacent property line.
- Discharge from any downspout described above must be dissipated, infiltrated, or diverted such that flows will not be concentrated.
- No person shall erect, construct, or otherwise permit and obstruction that prevents the natural or contained flow of water to any component of the stormwater system of the City of Atlanta, unless such obstruction is allowed on part of an approved permit.

NOTE:

- LIMIT OF DISTURBANCE GRAPHIC LINES ARE TRUE

% IMPACTED= 17.7%

- -TREE SAVE FENCE AND SILT FENCE ARE GRAPHICALLY NOTED TO BE CLEARLY REPRESENTED ON DRAWING.
- -TREE SAVE FENCE AND SILT FENCE SHOULD BE WITHIN 12" OF MARKED LIMIT OF DISTURBANCE.

NOTES:

- Before starting land disturbing activities, the contractor is required to schedule a preconstruction meeting with Erosion and Sediment Control.
- Failure to Schedule may result in STOP WORK ORDER or PERMIT **REVOCATION.**

SILT FENCE

- The escape of sediment from the site shall be prevented by the installation of erosion and sediment control measures and practices prior to, or concurrent with, land disturbing activities.
- Erosion control measures will be maintained at all times. If full implementation of the approved plan does not provide for effective erosion control, additional erosion and sediment control measures shall be implemented to control or treat the sediment source.

MAINTENANCE STATEMENT

- Any disturbed area left idle for a period greater than 14 days shall be stabilized with temporary seeding; disturbed areas idle 30 days shall be stabilized with permanent vegetation.
- Erosion and sediment control measures shall be inspected at least weekly, after each rain, and repaired as necessary.

STATEMENT

 Additional erosion and sediment control measures shall be installed if determined necessary by on-site inspection.

DIRT STATEMENT

- No graded slope shall exceed 2h:1v
- Permanent vegetation shall be established after construction is complete.



- As-built water quality certification or lot as-built survey (including water quality devices) is required prior to certificate of occupancy."

SCALE: 1"=10'

0 5

SCALE: 1"=10'

NORTH

- -Water quality devices to be installed at the time of final landscaping.
- -All collected water shall be directed to the water quality devices.

Specific Requirements for below ground infiltration measures:

- All stone / gravel washed (having no fines). Maximum allowable void ratio is 40%,
- Simple equation for determining total gravel volume WQv (cuft) x 0.093 = Gravel Volume (cubic yards).
- Distribute runoff within a linear gravel deice using a slotted / perforated flex pipe. For downspout connections to the device, use solid walled PVC (schedule 20 minimum)
- Provide a cleanout and an emergency bypass for excess flows installed on the piping system prior to piping reaching the infiltration device.
- Infiltration devices placed on a 0% grade.
- A non-woven filter fabric placed between the soil and the device or gravel.

192.46' . conc. wall -PROPERTY LINE 7.5' B.L. EX. DRIVEWAY EX. DRIVEWAY POOL DECK FENCE 90 EXISTING (24X14) 2-STORY HOUSE # W/BASEMENT ,9.05 F.F.E.=973.08 F.F.B.=962.14 . 82 EX. WALKWAY POOL DECK **EQUIP** CANTILEVER 973.0 CANTILEVER 7.5' B.L. EX. RETAINING WALL 201.12'ex. stone wall S 03°19'33"E PROPERTY LINE —EX. FENCE (TO BE REMOVED) EX. STONE WALL CRZ AREA= 2463 SQ FT IMPACT AREA= 437 SQ FT % IMPACTED= 17.7%

NOTE:

- Lots and buildings shall be developed in a manner to ensure that stormwater exiting individual parcels or lots under post developed conditions does not adversely impact the adjacent parcels or lots as a result of concentrated flows, flooding, erosion, or deposits of silt or sediment.
- The stormwater discharge from a downspout, cistern, or any water collection device shall be located a distance of no less than ten feet from common property line and oriented so direction of concentrated flow is not toward the adjacent property line.
- Discharge from any downspout described above must be dissipated, infiltrated, or diverted such that flows will not be concentrated.
- No person shall erect, construct, or otherwise permit and obstruction that prevents the natural or contained flow of water to any component of the stormwater system of the City of Atlanta, unless such obstruction is allowed on part of an approved permit.

NOTE:

- LIMIT OF DISTURBANCE GRAPHIC LINES ARE TRUE.
- -TREE SAVE FENCE AND SILT FENCE ARE GRAPHICALLY NOTED TO BE CLEARLY REPRESENTED ON DRAWING.
- -TREE SAVE FENCE AND SILT FENCE SHOULD BE WITHIN 12" OF MARKED LIMIT OF DISTURBANCE.

NOTES:

- Before starting land disturbing activities, the contractor is required to schedule a preconstruction meeting with Erosion and Sediment Control.
- Failure to Schedule may result in <u>STOP WORK ORDER</u> or <u>PERMIT REVOCATION</u>.

SILT FENCE

- The escape of sediment from the site shall be prevented by the installation of erosion and sediment control measures and practices prior to, or concurrent with, land disturbing activities.
- Erosion control measures will be maintained at all times. If full implementation of the approved plan does not provide for effective erosion control, additional erosion and sediment control measures shall be implemented to control or treat the sediment source.

MAINTENANCE STATEMENT


- Any disturbed area left idle for a period greater than 14 days shall be stabilized with temporary seeding; disturbed areas idle 30 days shall be stabilized with permanent vegetation.
- Erosion and sediment control measures shall be inspected at least weekly, after each rain, and repaired as necessary.

Additional erosion and sediment control measures shall be installed if determined necessary by on-site inspection.

DIRT STATEMENT

STATEMENT

- No graded slope shall exceed 2h:1v
- Permanent vegetation shall be established after construction is complete.

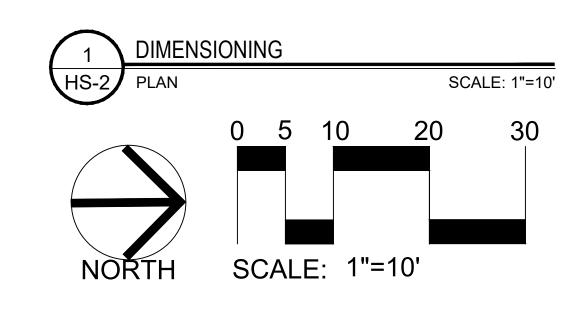

IMPERVIOUS CALCULATIONS

35% Allowable Impervious (SQ FT)

Lot Size (SQ FT)

 \geq

HOUSE	2,600.00
FRONT PORCH	325.30
FRONT STEPS AND WALKWAY	241.20
DRIVEWAY	1,373.70
FRONT WALL ALONG DRIVE	44.70
STONE WALL AND STEPS TO BACK YARD	153.00
STONE WALK BACK YARD	112.00
EX STEPS BACK PORCH	46.10
	4,896.00

13,697.00

4,793.95

TOTAL EXISTING IMPERVIOUS (SQ FT)	4,896.00
% EXISTING IMPERVIOUS	35.75%

IMPERVIOUS REDUCTION	
STONE WALK BACK YARD	112.00
	112.00
PROPOSED IMPERVIOUS	

ADD STAIRS OFF BACK PORCH	4
POOL	45
RETAINING WALL	5
POOL DECK	95
2X2 STEPPING STONES (4)	1
POOL EQUIPMENT AREA	4
	1,56

TOTAL IMPERVIOUS (SQ. FT.)	6,344.0
% IMPERVIOUS	46.329
% PRECONSTRUCTION IMPERVIOUS	35.75%
% POST CONSTRUCTION IMPERVIOUS	46.32%
% MAX ALLOWABLE IMPERVIOUS	35.00%
	<u> </u>

% OVER MAX IMPERVIOUS	11.32%
SQ. FEET OVER MAX IMPERVIOUS	1550.05

ACREAGE INFORMATION

- TOTAL LOT SIZE (SQ FT): 13,697
- TOTAL DISTURBED AREA (SQ FT): 6,000

WATERS OF THE STATE NOTE:

• NO WATERS OF THE STATE EXIST WITHIN 200 FEET OF THE PROJECT SITE.

DIRT STATEMENT:

- Cut: 18 Cubic Yards
- Fill: 9 Cubic Yards
- Total Removed From Site: 9 Cubic Yards

 SITE DATA:

 Tax Parcel ID:
 18-001-09-004

 Land Lot:
 12

 District:
 18

 Zoning:
 R-75

 Acreage:
 0.314 ACRES

 Address:
 1339 Chalmette Drive

 ATLANTA 30306
 DEKALB COUNTY

Owner: SUSAN AND BEN CLARE


24 Hour contact: Adam Ardoin

404-556-8691

DATE DESCRIPTION

12-22-20 FINAL

12-28-20 REVISE

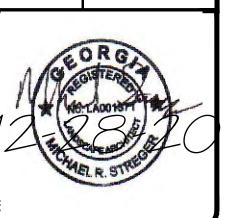

LAKE RESCAPE PLANS

LAND


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AND CONSULTING, LLC

DIMENSIONING PLAN

> SCALE 1"=10'

SHEET NUMBER
HS-2.0

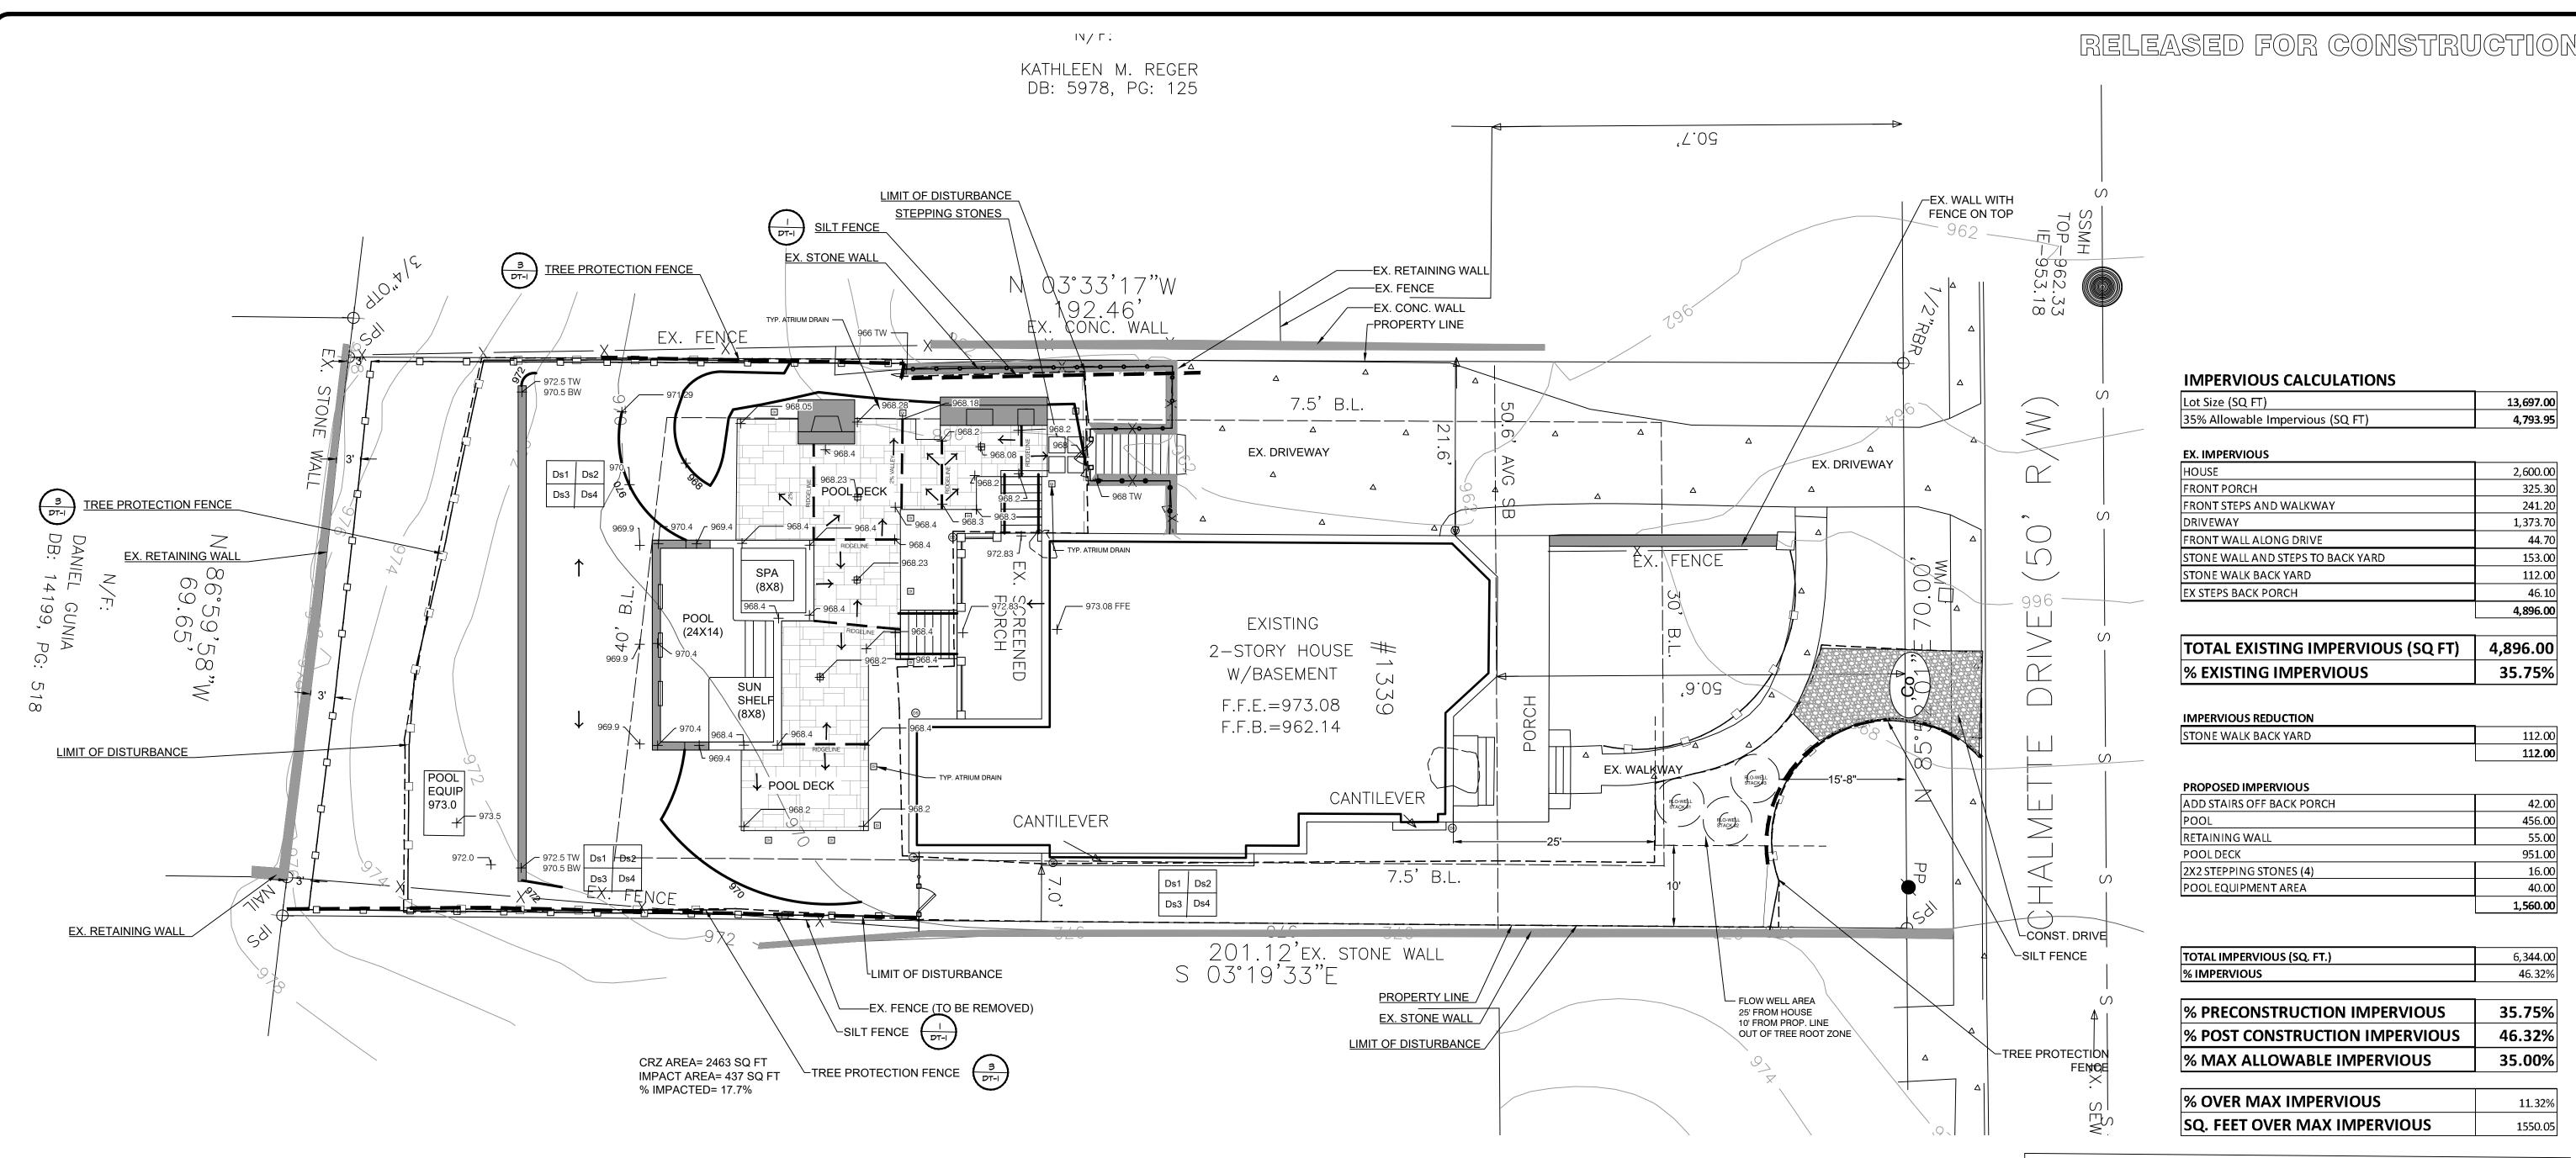

NOTE:

- Lots and buildings shall be developed in a manner to ensure that stormwater exiting individual parcels or lots under post developed conditions does not adversely impact the adjacent parcels or lots as a result of concentrated flows, flooding, erosion, or deposits of silt or sediment.
- The stormwater discharge from a downspout, cistern, or any water collection device shall be located a distance of no less than ten feet from common property line and oriented so direction of concentrated flow is not toward the adjacent property line.
- Discharge from any downspout described above must be dissipated, infiltrated, or diverted such that flows will not be concentrated.
- No person shall erect, construct, or otherwise permit and obstruction that prevents the natural or contained flow of water to any component of the stormwater system of the City of Atlanta, unless such obstruction is allowed on part of an approved permit.

NOTE:

- LIMIT OF DISTURBANCE GRAPHIC LINES ARE TRUE.
- -TREE SAVE FENCE AND SILT FENCE ARE GRAPHICALLY NOTED TO BE CLEARLY REPRESENTED ON DRAWING.
- -TREE SAVE FENCE AND SILT FENCE SHOULD BE WITHIN 12" OF MARKED LIMIT OF DISTURBANCE.

NOTES:

- Before starting land disturbing activities, the contractor is required to schedule a preconstruction meeting with Erosion and Sediment Control.
- Failure to Schedule may result in <u>STOP WORK ORDER</u> or <u>PERMIT</u> REVOCATION.

SILT FENCE

- The escape of sediment from the site shall be prevented by the installation of erosion and sediment control measures and practices prior to, or concurrent with, land disturbing activities.
- Erosion control measures will be maintained at all times. If full implementation
 of the approved plan does not provide for effective erosion control, additional
 erosion and sediment control measures shall be implemented to control or
 treat the sediment source.

MAINTENANCE STATEMENT


- Any disturbed area left idle for a period greater than 14 days shall be stabilized with temporary seeding; disturbed areas idle 30 days shall be stabilized with permanent vegetation.
- Erosion and sediment control measures shall be inspected at least weekly, after each rain, and repaired as necessary.

STATEMENT

 Additional erosion and sediment control measures shall be installed if determined necessary by on-site inspection.

DIRT STATEMENT

- No graded slope shall exceed 2h:1v
- Permanent vegetation shall be established after construction is complete.

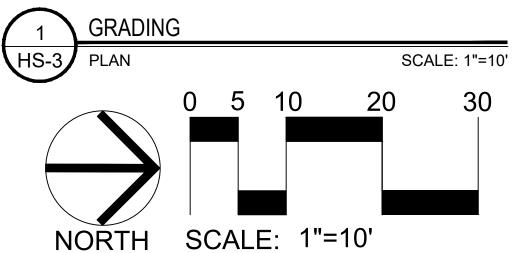

ACREAGE INFORMATION

- TOTAL LOT SIZE (SQ FT): 13,697
- TOTAL DISTURBED AREA (SQ FT): 6,000

WATERS OF THE STATE NOTE:

NO WATERS OF THE STATE EXIST WITHIN 200 FEET OF THE PROJECT SITE.

DIRT STATEMENT:

- Cut: 18 Cubic Yards
- Fill: 9 Cubic Yards
- Total Removed From Site: 9 Cubic Yards

NOTE:

- REFER TO DT-1 FOR EROSION CONTROL DETAILS

 SITE DATA:

 Tax Parcel ID:
 18-001-09-004

 Land Lot:
 12

 District:
 18

 Zoning:
 R-75

 Acreage:
 0.314 ACRES

 Address:
 1339 Chalmette Drive

 ATLANTA 30306

Owner: SUSAN A

24 Hour contact: Adam Ar

DEKALB COUNTY SUSAN AND BEN CLARE Adam Ardoin 404-556-8691 DATE DESCRIPTION

12-22-20 FINAL

12-28-20 REVISE



TAL ARSIDE PLANS

LAND


678.503.0390-0

AND CONSULTING, LLC

GRADING AND EROSION CONTROL PLAN

> SCALE 1"=10'

SHEET NUMBER
HS-3.0

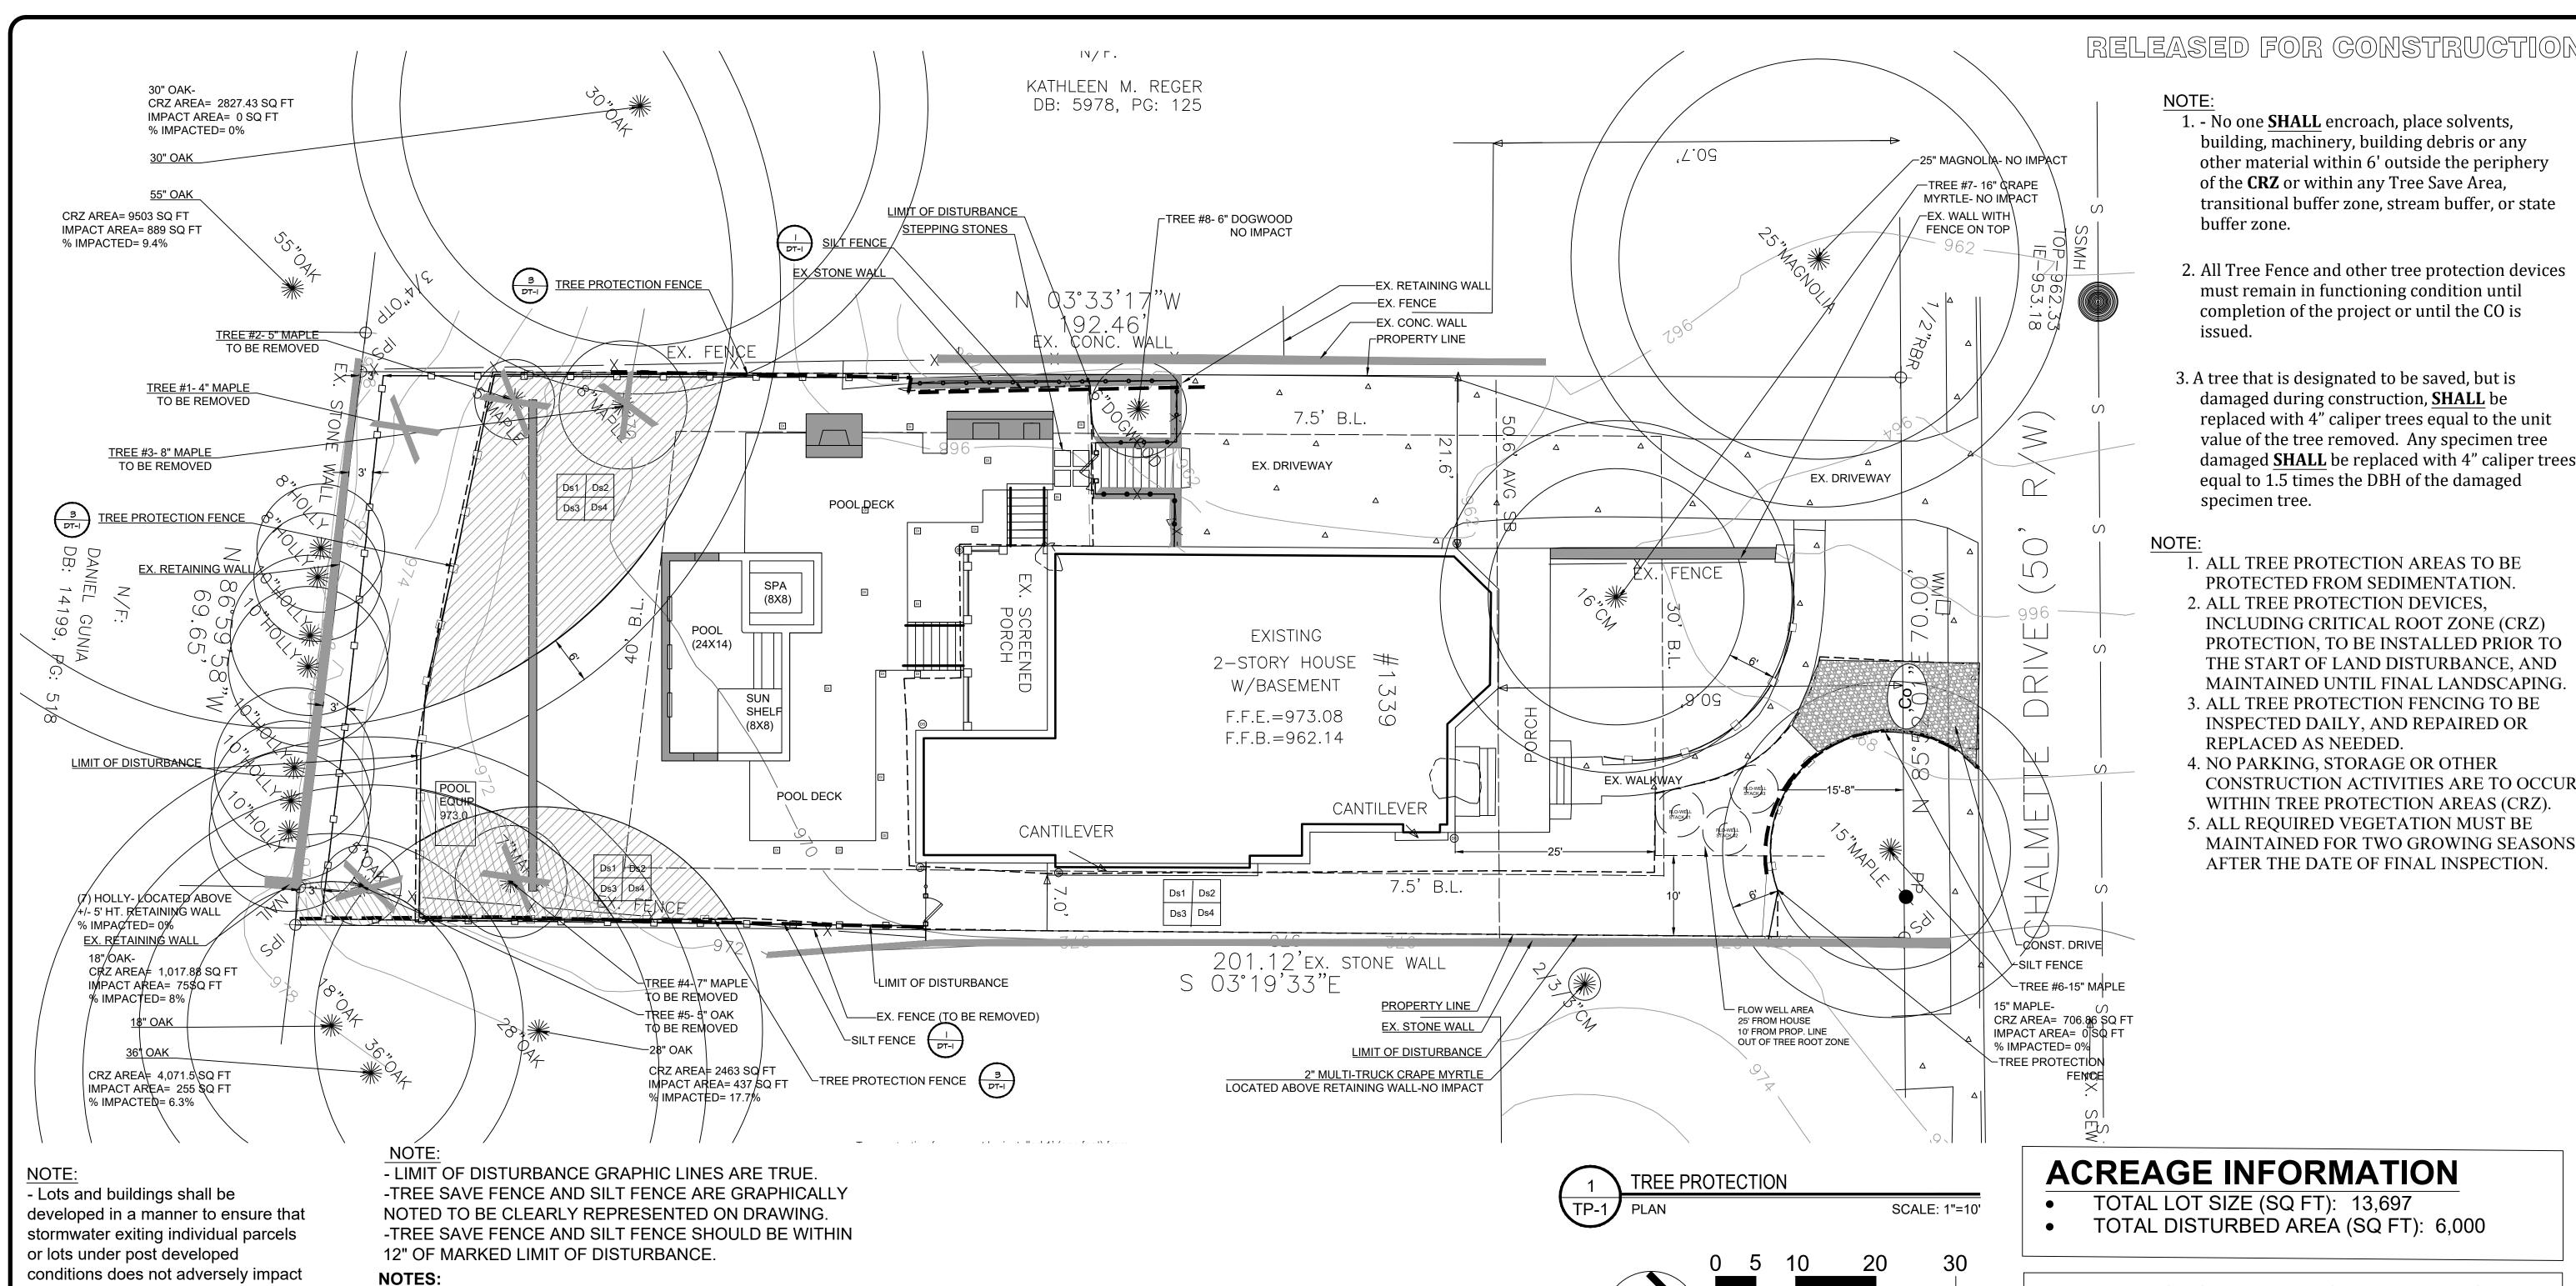

NOTE:

- 1. No one **SHALL** encroach, place solvents, building, machinery, building debris or any other material within 6' outside the periphery of the **CRZ** or within any Tree Save Area, transitional buffer zone, stream buffer, or state buffer zone.
- 2. All Tree Fence and other tree protection devices must remain in functioning condition until completion of the project or until the CO is issued.
- 3. A tree that is designated to be saved, but is damaged during construction, SHALL be replaced with 4" caliper trees equal to the unit value of the tree removed. Any specimen tree damaged **SHALL** be replaced with 4" caliper trees equal to 1.5 times the DBH of the damaged specimen tree.

- 1. ALL TREE PROTECTION AREAS TO BE PROTECTED FROM SEDIMENTATION.
- 2. ALL TREE PROTECTION DEVICES. INCLUDING CRITICAL ROOT ZONE (CRZ) PROTECTION, TO BE INSTALLED PRIOR TO THE START OF LAND DISTURBANCE, AND MAINTAINED UNTIL FINAL LANDSCAPING.
- 3. ALL TREE PROTECTION FENCING TO BE INSPECTED DAILY, AND REPAIRED OR REPLACED AS NEEDED.
- 4. NO PARKING, STORAGE OR OTHER CONSTRUCTION ACTIVITIES ARE TO OCCUR WITHIN TREE PROTECTION AREAS (CRZ).
- 5. ALL REQUIRED VEGETATION MUST BE MAINTAINED FOR TWO GROWING SEASONS AFTER THE DATE OF FINAL INSPECTION.

ACREAGE INFORMATION

- TOTAL LOT SIZE (SQ FT): 13,697
- TOTAL DISTURBED AREA (SQ FT): 6,000

WATERS OF THE STATE NOTE:

NO WATERS OF THE STATE EXIST WITHIN 200 FEET OF THE PROJECT SITE.

DIRT STATEMENT:

- 2 TREES PRESERVED IN FRONT YARD -THIS PROJECT IS EXEMPT FROM THE TREE ORDINANCE DUE TO NOT REMOVING MORE THAN 5 TREES BETWEEN THE SIZE OF 8"

SITE DATA: Tax Parcel ID: Land Lot: District:

Owner:

Zoning: Acreage: Address:

0.314 ACRES 1339 Chalmette Drive ATLANTA 30306

R-75

DEKALB COUNTY SUSAN AND BEN CLARE 24 Hour contact: Adam Ardoin 404-556-8691

18-001-09-004

SHEET NUMBER

NOTE:

NORTH SCALE: 1"=10"

AND 29" DBH.

Fill: 9 Cubic Yards

Cut: 18 Cubic Yards

- **Total Removed From Site: 9 Cubic Yards**

AND CONSULTING, LLC

678.503.0390-0

DESCRIPTION

FINAL


DATE

12-28-20

TREE **PROTECTION** PLAN

> SCALE 1"=10'

TP-1.0

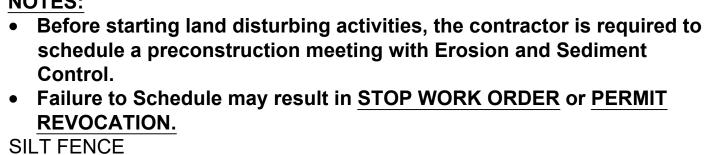

- The escape of sediment from the site shall be prevented by the installation of erosion and sediment control measures and practices prior to, or concurrent with, land disturbing activities.
- Erosion control measures will be maintained at all times. If full implementation of the approved plan does not provide for effective erosion control, additional erosion and sediment control measures shall be implemented to control or treat the sediment source.
- MAINTENANCE STATEMENT • Any disturbed area left idle for a period greater than 14 days shall be stabilized with temporary seeding; disturbed areas idle 30 days shall be stabilized with permanent vegetation.
- Erosion and sediment control measures shall be inspected at least weekly, after each rain, and repaired as necessary. STATEMENT
- Additional erosion and sediment control measures shall be installed if determined necessary by on-site inspection.

DIRT STATEMENT

the adjacent parcels or lots as a result

of concentrated flows, flooding,

- The stormwater discharge from a

collection device shall be located a

direction of concentrated flow is not

described above must be dissipated,

infiltrated, or diverted such that flows

- No person shall erect, construct, or

otherwise permit and obstruction that

prevents the natural or contained flow

allowed on part of an approved permit.

of water to any component of the

stormwater system of the City of

Atlanta, unless such obstruction is

toward the adjacent property line.

- Discharge from any downspout

will not be concentrated.

distance of no less than ten feet from


common property line and oriented so


downspout, cistern, or any water

erosion, or deposits of silt or

sediment.

- No graded slope shall exceed 2h:1v
- Permanent vegetation shall be established after construction is complete.

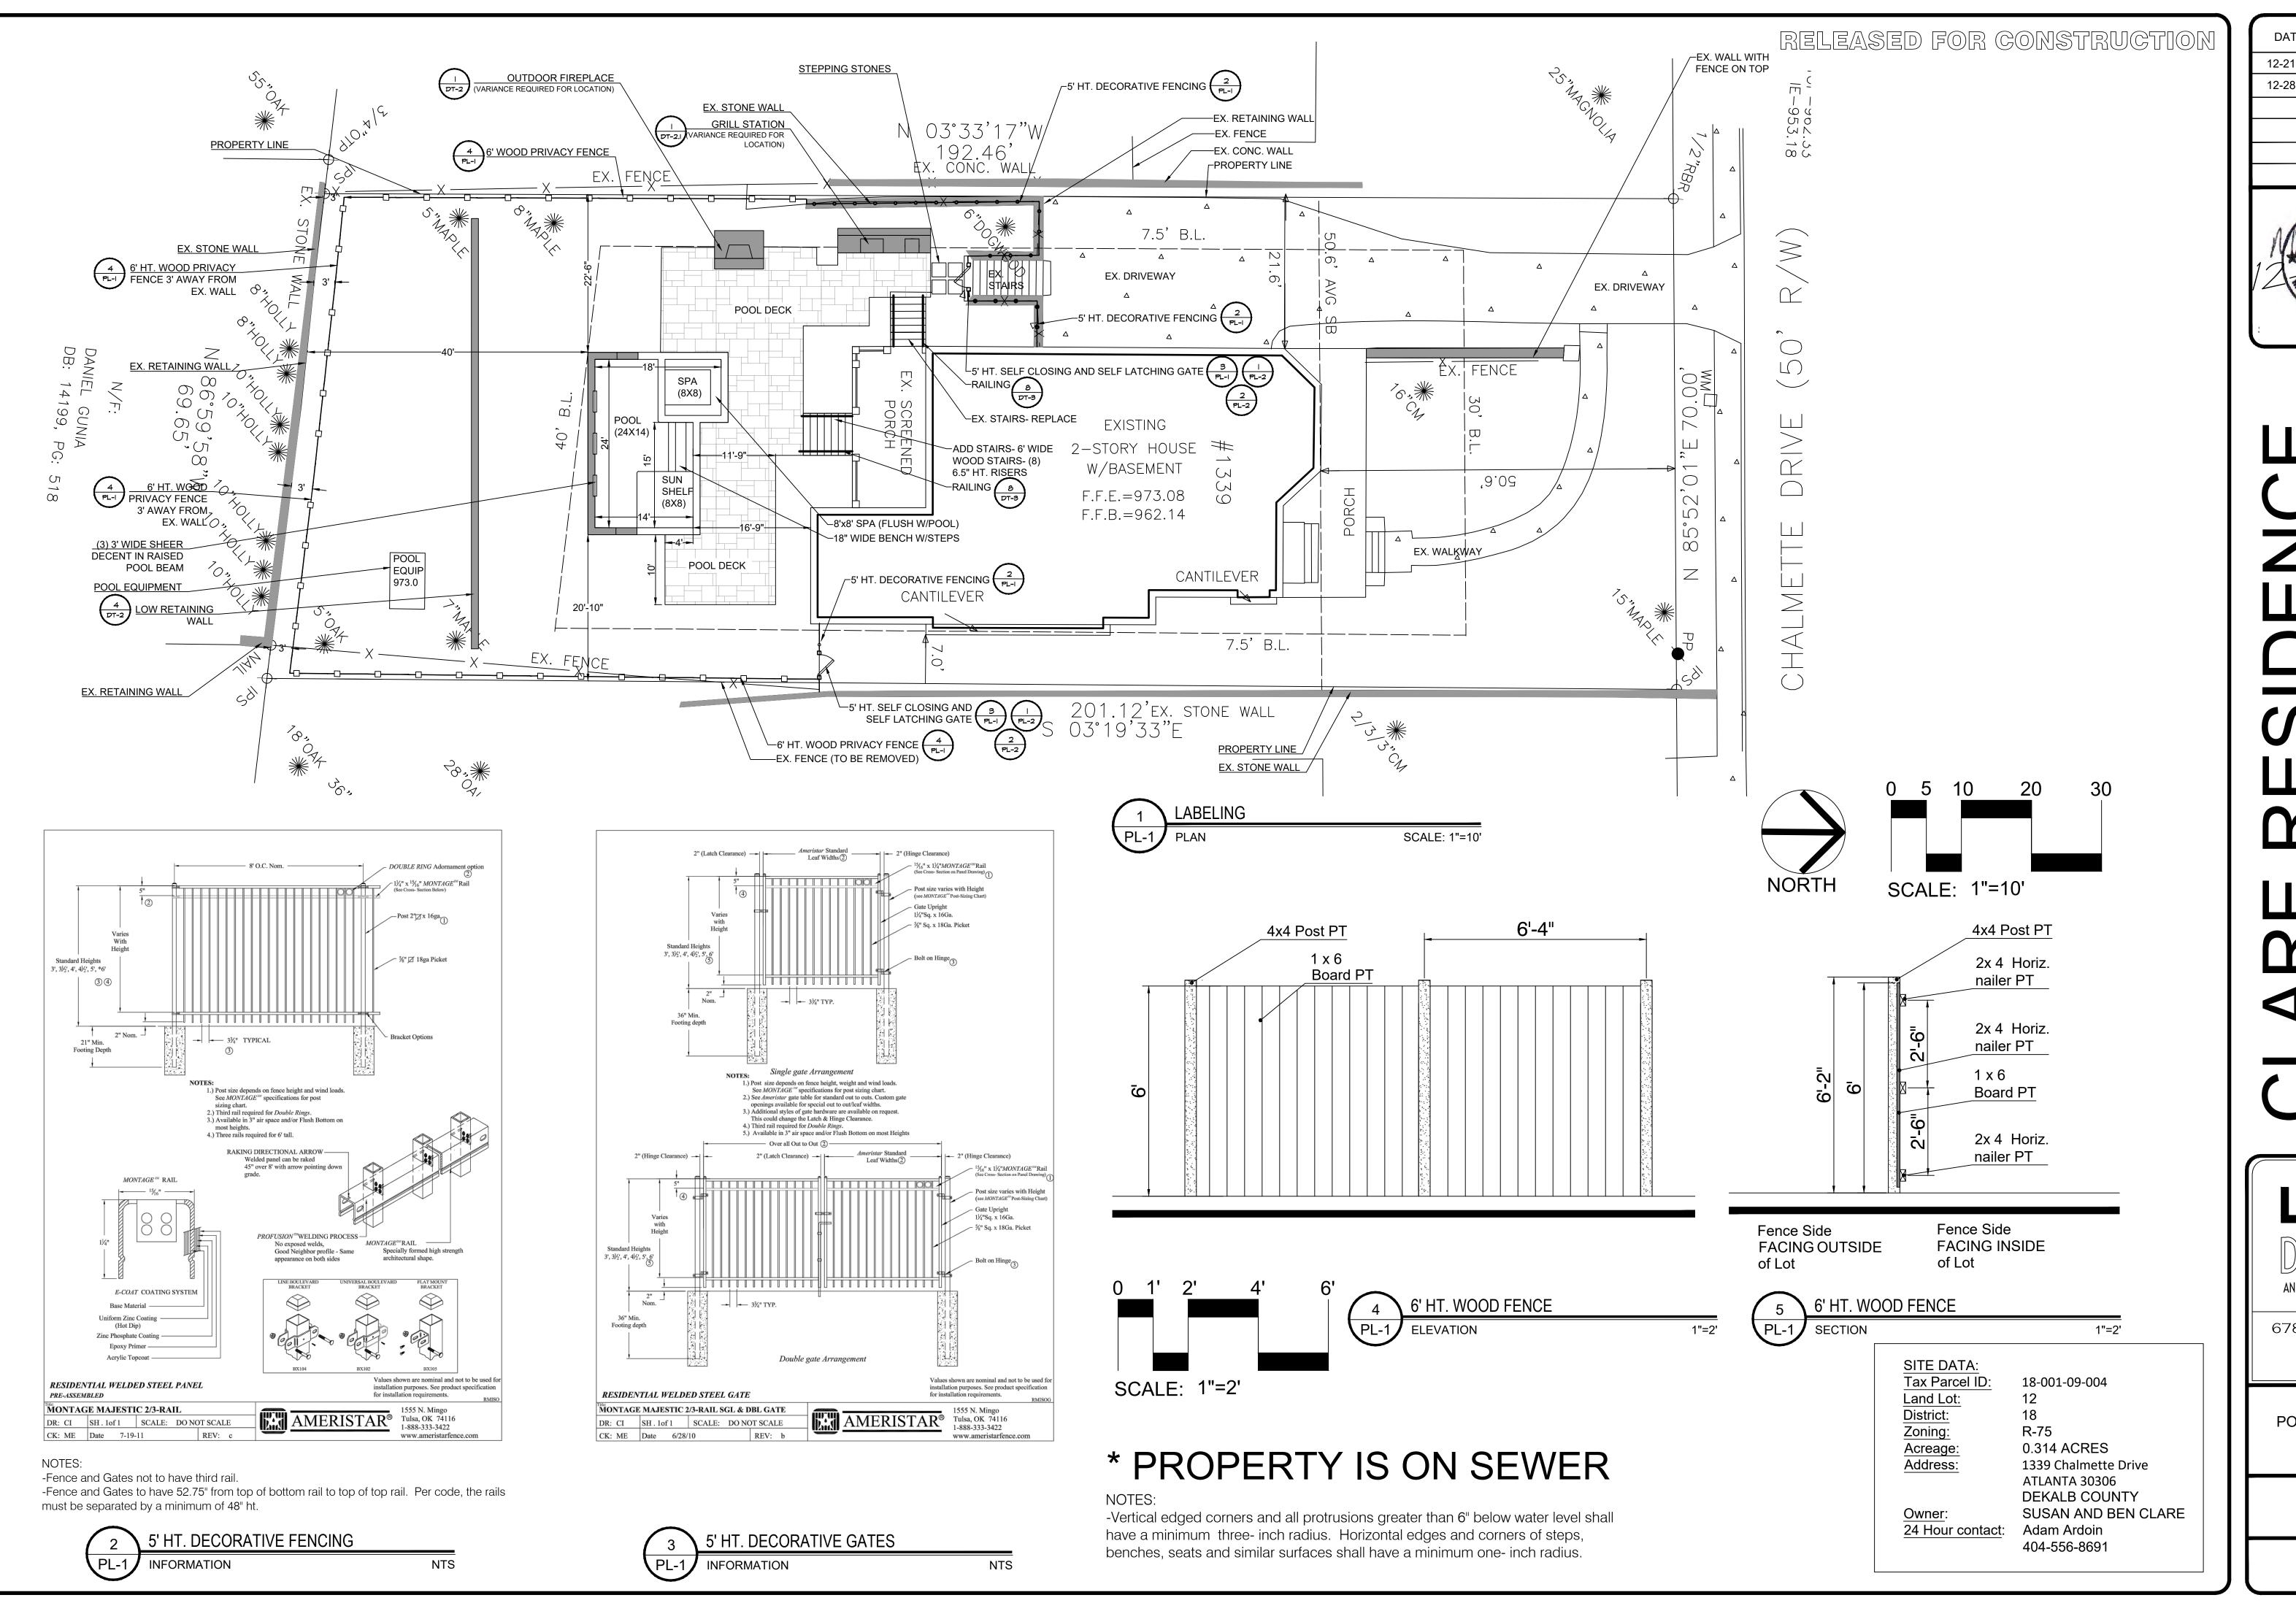

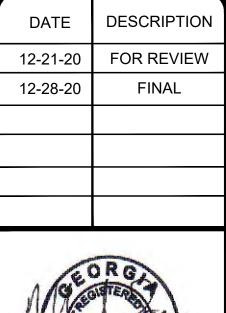



CLARB RESIDENCE HARDSCAPE PLANS 1339 CHALMETTE DRIVE - ATLANTA, GEORGIA 30306 - DEKALB COUNTY



AND CONSULTING, LLC

678.503.0390-0

POOL PLAN AND DETAILS

VARIES

SHEET NUMBER
PL-1.0

SITE DATA: Tax Parcel ID:

Land Lot:

District:

Zoning:

Acreage:

Address:

Owner:

24 Hour contact:

18-001-09-004

0.314 ACRES


ATLANTA 30306 **DEKALB COUNTY**

Adam Ardoin

404-556-8691

1339 Chalmette Drive

SUSAN AND BEN CLARE

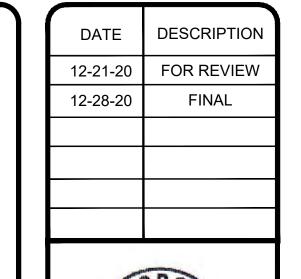



AND CONSULTING, LLC

678.503.0390-O

POOL DETAILS

VARIES

SHEET NUMBER PL-2.0

LOCKEY

TB100 GATE CLOSER



Gently closes both small and large gates up to 125lbs. Pushes gate closed

Adjustable closing speed Can be installed on top, bottom or middle of gate Recommended for pool, garden and barrier gates Can be used on lightweight (non fire-rated) doors Works best on gates with in-line/flush hinges

DIMENSIONS & SPECIFICATIONS

Dimensions: Length: 7 1/2"

Width: 13" Depth: 2 1/2"

Mounting Bracket Dimensions: 3 1/4" x 1 3/4" Max. Gate Weight: 125 lbs. Max. Gate Width: 54"

Max. Opening Angle: 90 degrees
Min. Operating Temperature: 10 degrees
Max. Operating Temperature: 110 degrees
Type of Gate Material: Vinyl, Wood, Steel, Chain Link

Closing/Latching Method: Hydraulic Material: Steel Finish: Powder-Coated


Color: Black Hinge Arrangements: In-line/flush hinges Opening Pressure: Variable, depending on gate size

The LockeyUSA Turtle Back TB100 Hydraulic Gate closer must mount on the hinge side/pull side of the gate in order to push the gate closed. The TB100 works best if the gate has in-line/ flush hinges flush with the gate post with 1″ or less gap.

ORDERING INFORMATION

Order #: TB100

www.LockeyUSA.com/TB100

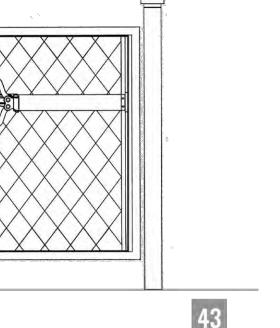

SELF CLOSING GATE LATCH

-To be mounted a minimum of 45" above the ground surface directly below gate. POSITIVE- LATCHING MECHANISM NTS

NEW MagnaLatch® Vertical Pull

in a smaller, more compact model.

MagnaLatch Series 3 - For metal, wood, and vinyl gates

MTSTDKS3KA* Top Pull Kit* - 6-Pin Lock - Keyed Alike

MLSPACER MLSPACER 2" Gap Spacer - Works with ML2 & ML3

*Kit includes (1) ML3TPKA + (1)pr TCAIS3BT + (1) TCACAPS3 safety cap NOTE: For white models or round post adapter kit, use MagnaLatch Series

Vertical Pull model

Product Code: ML3VPKA

Perfect for pet security gates and general gates

around the home. MagnaLatch Vertical Pull offers the same innovative design as MagnaLatch Top Pull, only

NEW MagnaLatch® Top Pull

world's most trusted safety gate latch.

Top Pull model

Product Code: ML3TPKA

NOTES:

-Use ML3TPKA

With its release knob out of reach of children, the

MagnaLatch Top Pull sets the standard for safety

gates around swimming pools, childcare centers or wherever safety is critical. No wonder it's the

PL-2 INFO

NTS







* VIEW FROM DRIVEWAY TO BACKYARD



* VIEW TO SOUTH

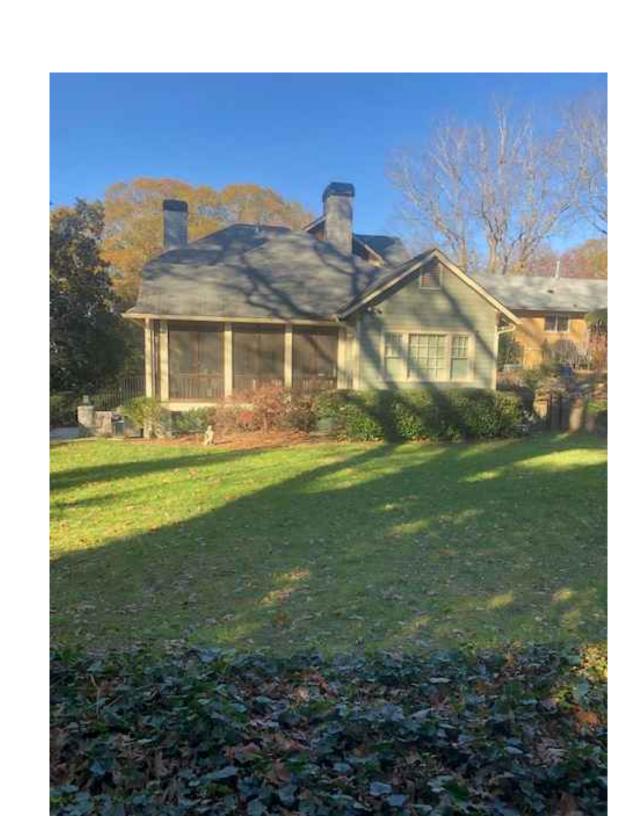

*BACK OF HOUSE

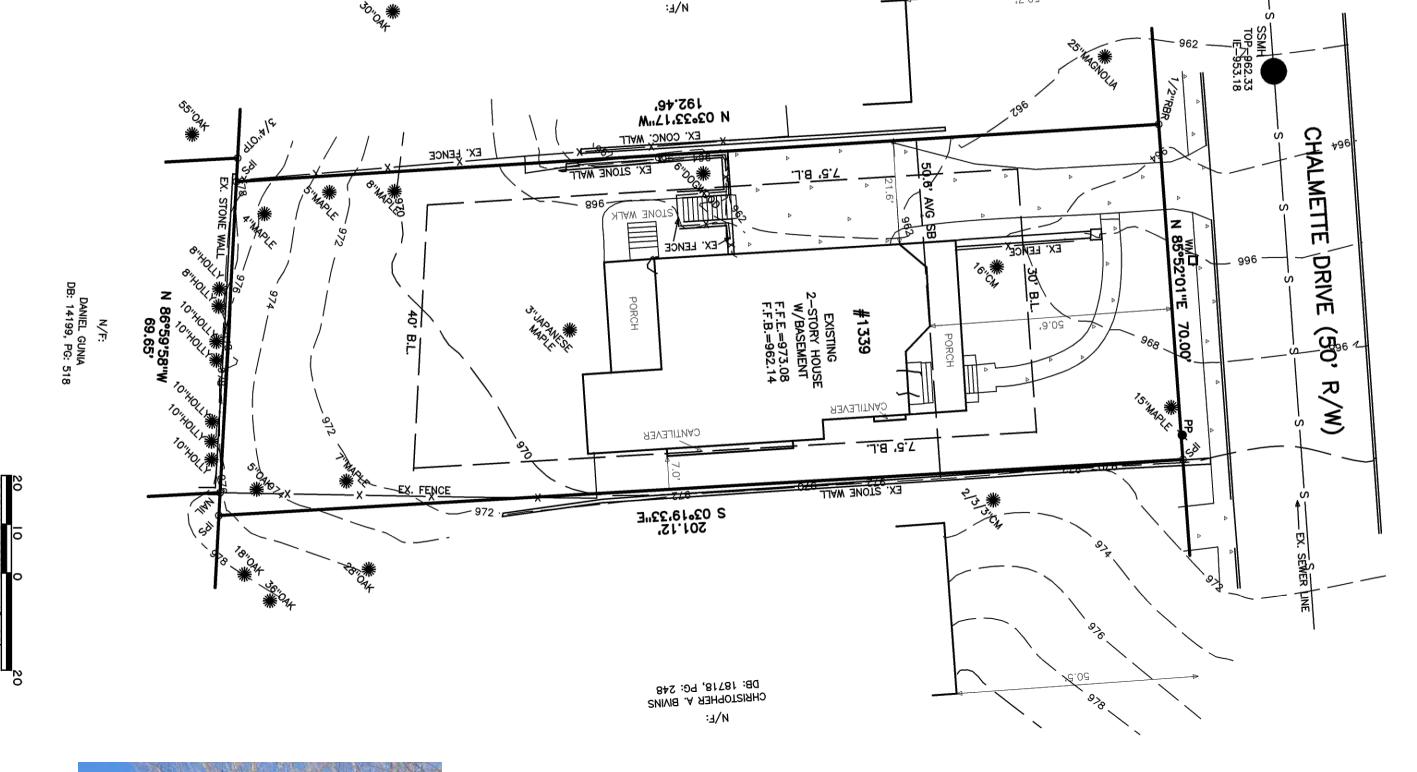

* VIEW TO WEST



*VIEW TO EAST NEIGHBOR

SITE DATA:
Tax Parcel ID: 18-001-09-004 Land Lot:

District:

Zoning: Acreage: Address: 0.314 ACRES

1339 Chalmette Drive ATLANTA 30306 DEKALB COUNTY SUSAN AND BEN CLARE Owner: SUSAN AND 22.

24 Hour contact: Adam Ardoin
404-556-8691

DATE

12-28-20

DESCRIPTION

FINAL



AND CONSULTING, LLC


678.503.0390-0

SITE PHOTOS


VARIES

SHEET NUMBER SP-1.0

SILT FENCE - TYPE B

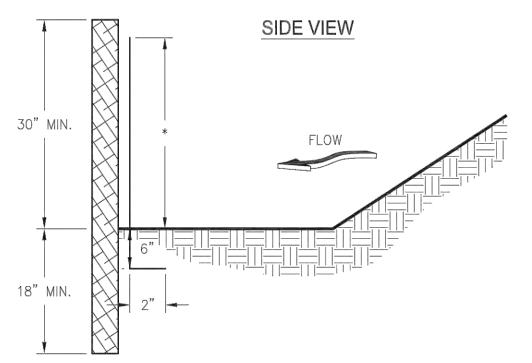

FRONT VIEW

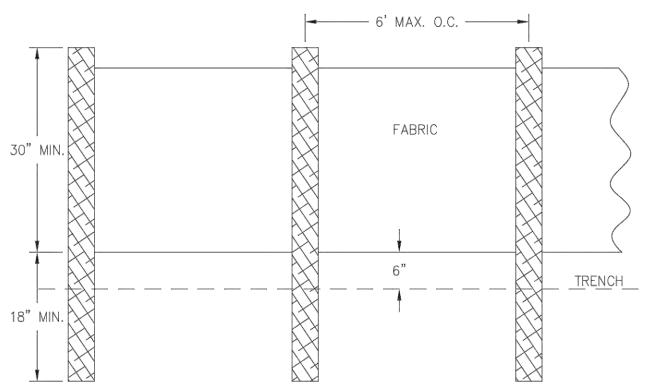

1. USE STEEL OR WOOD POSTS OR AS SPECIFIED BY THE EROSION, SEDIMENTATION, AND POLLUTION CONTROL PLAN. 2. HEIGHT (*) IS TO BE SHOWN ON THE EROSION, SEDIMENTATION, AND POLLUTION

Figure 6-27.1

TYPE B SILT FENCE SECTION/ELEVATION


Non-sensitive Areas * (Sd1-NS

GSWCC 2016 Edition

Sediment barriers being used as Type NS shall have a support spacing of no greater than 6 feet on center, with each being driven into the ground a minimum of 18 inches.

Type B Silt Fence

Though only 22-inches wide, this filter fabric allows the same flow rate as Type A silt fence. Type B silt fence shall be limited to use on minor projects, such as residential home sites or small commercial developments where permanent stabilization will be achieved in less than six months. Type B is classified as non-sensitive application.

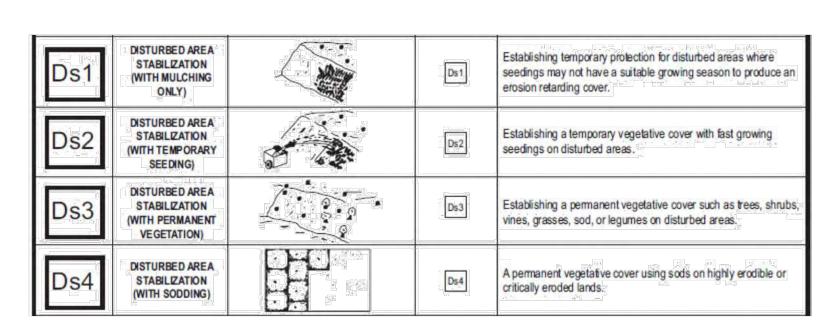


Ds1 - Disturbed Area Stabilization (With Mulching Only) Mulching can be used as a singular erosion control method on areas at rough grade. Mulch can be an option for up to six months provided that the mulch is applied at the appropriate depth (depending on type of mulch used), anchored, and has a continuous 90% cover or greater of the soil surface. Maintenance shall be required to maintain appropriate depth, anchorage, and 90% cover. If an area will remain undisturbed for greater than six months, permanent (perennial) vegetation shall be used.

Ds2 - Disturbed Area Stabilization (With Temporary Seeding) Temporary vegetation may be employed instead of mulch if the area will remain undisturbed for less than six months.

Ds3 - Disturbed Area Stabilization (With Permanent Vegetation) Permanent (perennial) vegetation or sod shall be used immediately on areas at final grade. Permanent (perennial) vegetation shall be used on rough graded areas that will be undisturbed for more than six months.

Ds4 - Disturbed Area Stabilization (With Sodding) may be used in place of Ds3.

"Stabilization" of an area is accomplished when 70 percent of the surface area is covered in a uniform, vegetative cover (permanent or temporary) or anchored mulch of the appropriate thickness with 90% coverage. "Final stabilization" means that all soil disturbing activities at the site have been completed, and that for unpaved areas and areas not covered by permanent structures, at least 70% of the soil surface is uniformly covered in permanent vegetation or equivalent permanent stabilization measures (such as the use of rip rap, gabions, permanent mulches or geotextiles) have been

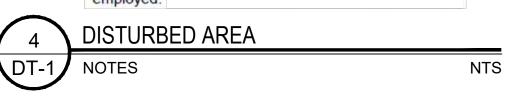

NOTE:

- LIMIT OF DISTURBANCE GRAPHIC LINES ARE TRUE.
- -TREE SAVE FENCE AND SILT FENCE ARE GRAPHICALLY NOTED TO BE CLEARLY REPRESENTED ON DRAWING.
- -TREE SAVE FENCE AND SILT FENCE SHOULD BE WITHIN 12" OF MARKED LIMIT OF DISTURBANCE.

NOTES:

- Before starting land disturbing activities, the contractor is required to schedule a preconstruction meeting with Erosion and Sediment Control.
- Failure to Schedule may result in STOP WORK ORDER or PERMIT REVOCATION.

SILT FENCE

- The escape of sediment from the site shall be prevented by the installation of erosion and sediment control measures and practices prior to, or concurrent with, land disturbing activities.
- Erosion control measures will be maintained at all times. If full implementation of the approved plan does not provide for effective erosion control, additional erosion and sediment control measures shall be implemented to control or treat the sediment source.

MAINTENANCE STATEMENT

- Any disturbed area left idle for a period greater than 14 days shall be stabilized with temporary seeding; disturbed areas idle 30 days shall be stabilized with permanent vegetation.
- Erosion and sediment control measures shall be inspected at least weekly, after each rain, and repaired as necessary.

STATEMENT


Additional erosion and sediment control measures shall be installed if determined necessary by on-site inspection.

DIRT STATEMENT

- No graded slope shall exceed 2h:1v
- Permanent vegetation shall be established after construction is complete.

NOTE:


- Lots and buildings shall be developed in a manner to ensure that stormwater exiting individual parcels or lots under post developed conditions does not adversely impact the adjacent parcels or lots as a result of concentrated flows, flooding, erosion, or deposits of silt or sediment.
- The stormwater discharge from a downspout, cistern, or any water collection device shall be located a distance of no less than ten feet from common property line and oriented so direction of concentrated flow is not toward the adjacent property line.
- Discharge from any downspout described above must be dissipated, infiltrated, or diverted such that flows will not be concentrated.
- No person shall erect, construct, or otherwise permit and obstruction that prevents the natural or contained flow of water to any component of the stormwater system of the City of Atlanta, unless such obstruction is allowed on part of an approved permit

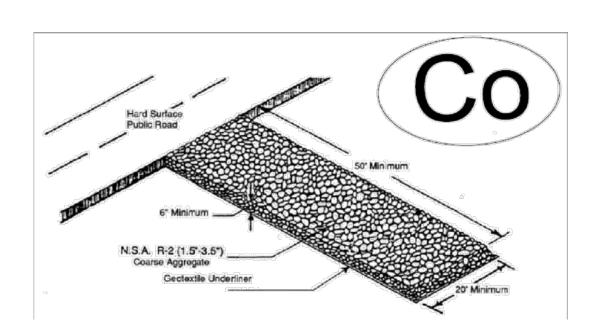

Construction Exit Maintenance

The exit shall be maintained in a condition which will prevent tracking or flow of mud onto public rights-of-way. This may require periodic top dressing with 1.5-3.5 inch stone, as conditions demand, and repair and/or cleanout of any structures to trap sediment. All materials spilled, dropped, washed, or tracked from vehicles or site onto roadways or into storm drains must be removed immediately.



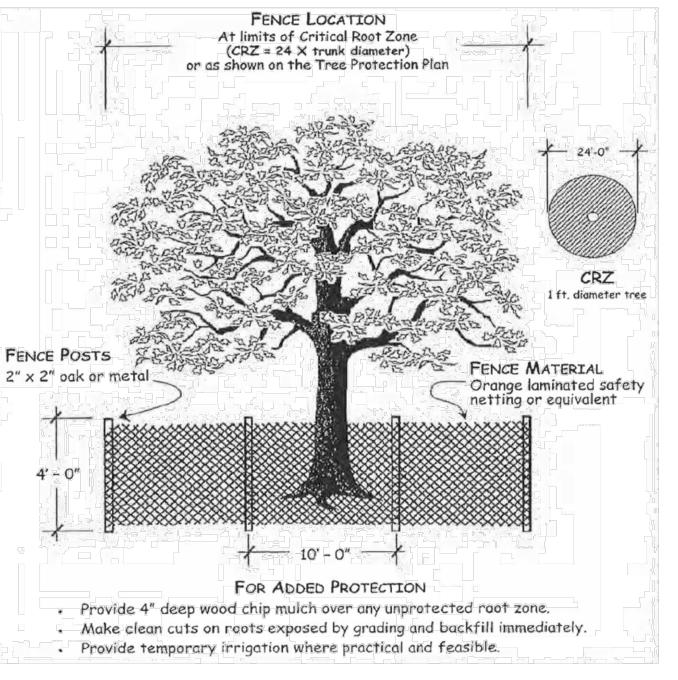



ACREAGE INFORMATION

- TOTAL LOT SIZE (SQ FT): 13,697
- TOTAL DISTURBED AREA (SQ FT): 6,000

WATERS OF THE STATE NOTE:

NO WATERS OF THE STATE EXIST WITHIN 200 FEET OF THE PROJECT SITE.

DIRT STATEMENT:

- **Cut: 18 Cubic Yards**
- Fill: 9 Cubic Yards
- **Total Removed From Site: 9 Cubic Yards**

SITE DATA: 18-001-09-004 Tax Parcel ID: Land Lot: District: Zoning: 0.314 ACRES Acreage: Address: 1339 Chalmette Drive **ATLANTA 30306 DEKALB COUNTY** SUSAN AND BEN CLARE 24 Hour contact: Adam Ardoin

404-556-8691

DESCRIPTION 12-30-20 FINAL



AND CONSULTING, LLC


678.503.0390-0


EROSION CONTROL TREE PROTECTION

DETAILS

SCALE **VARIES**

SHEET NUMBER DT-1.0

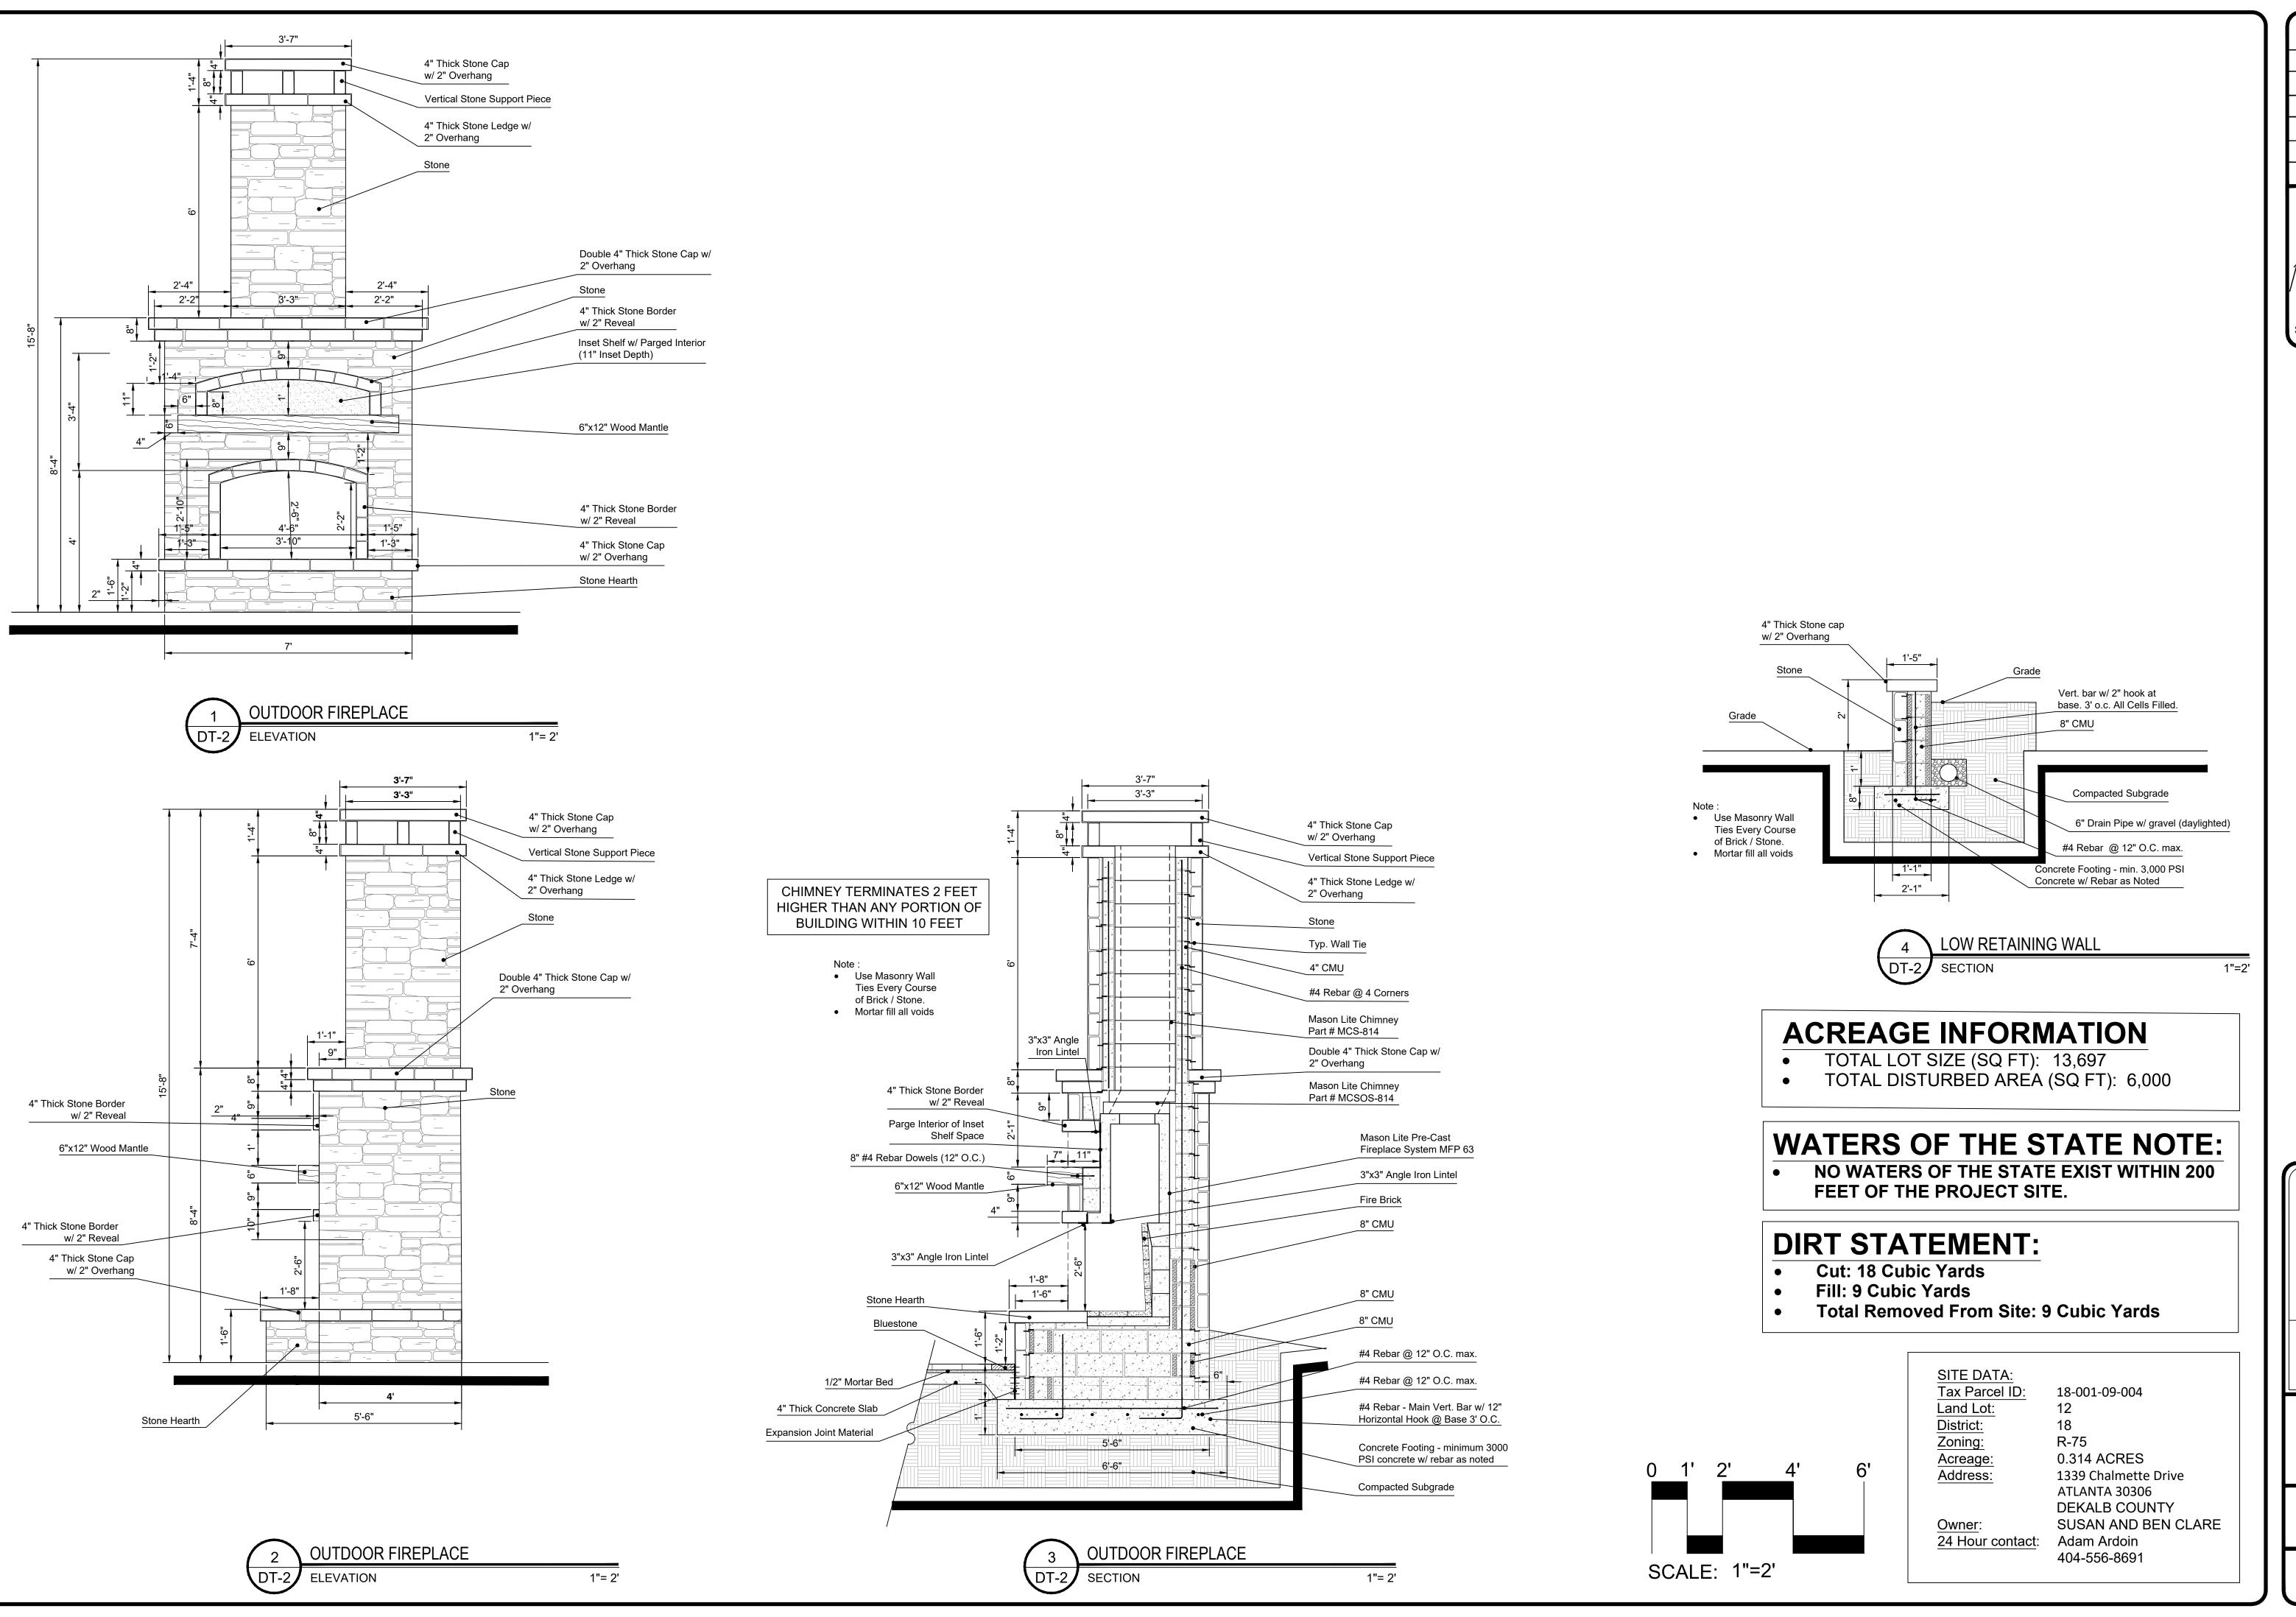

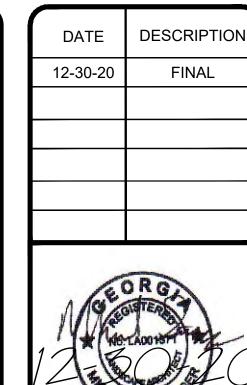


AND CONSULTING, LLC


678.503.0390-0


MISC DETAILS

VARIES


SHEET NUMBER DT-2.0

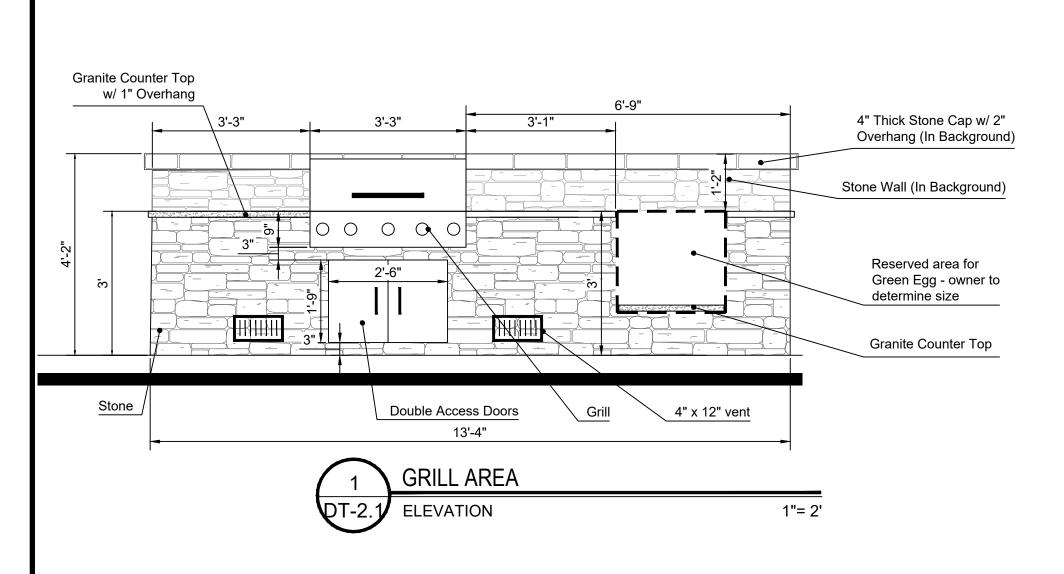


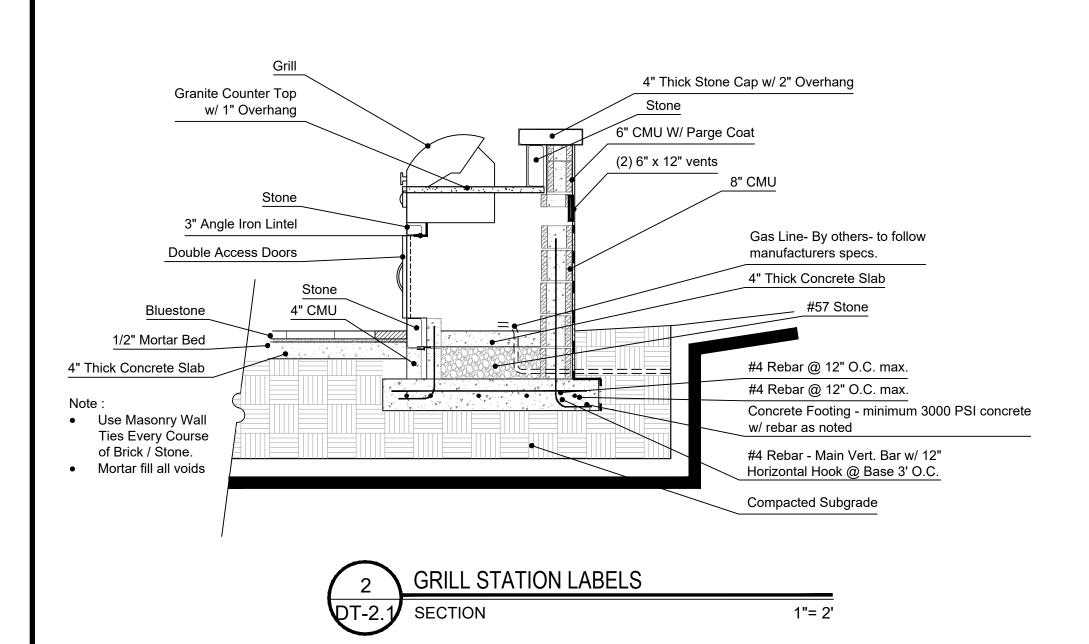


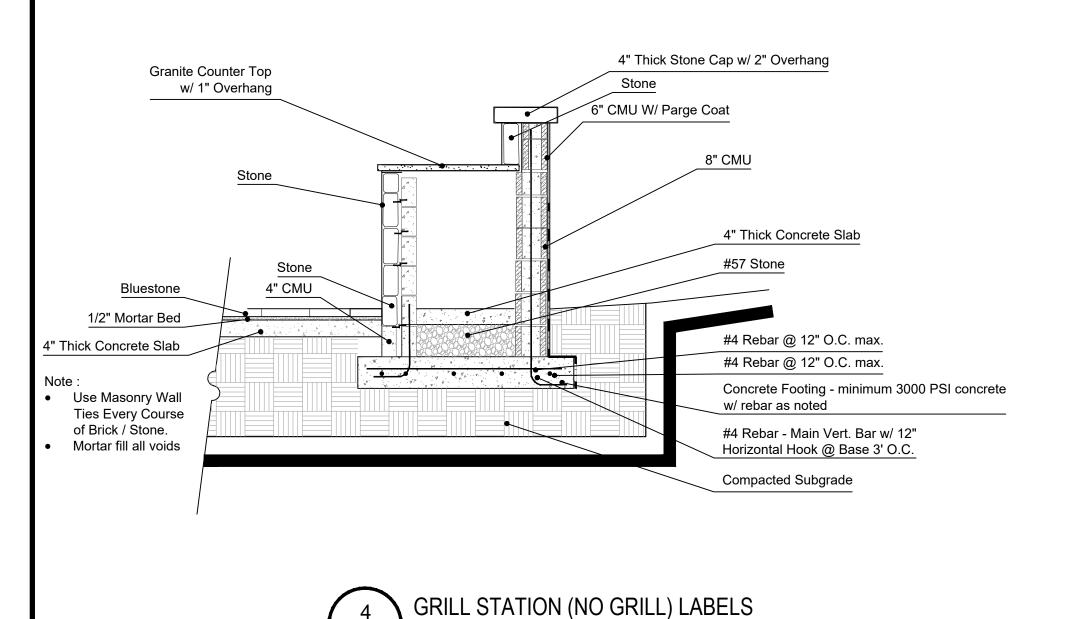

1"= 2'

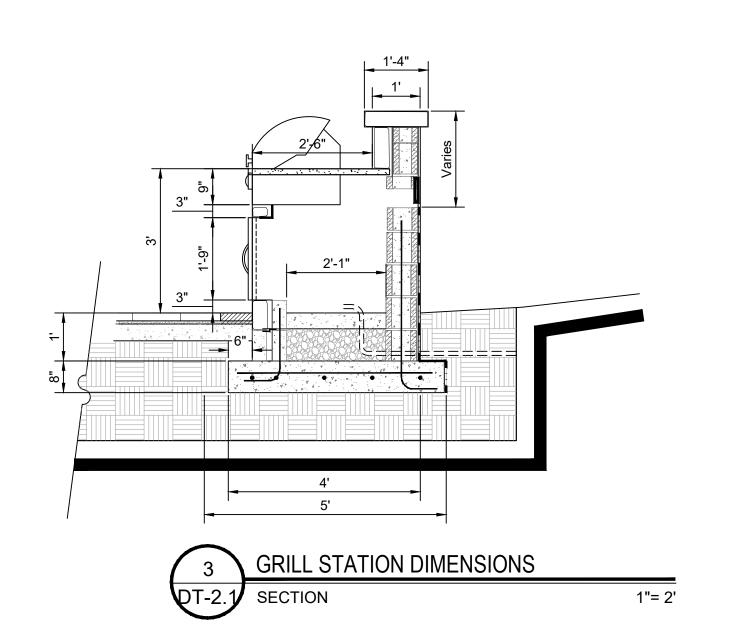

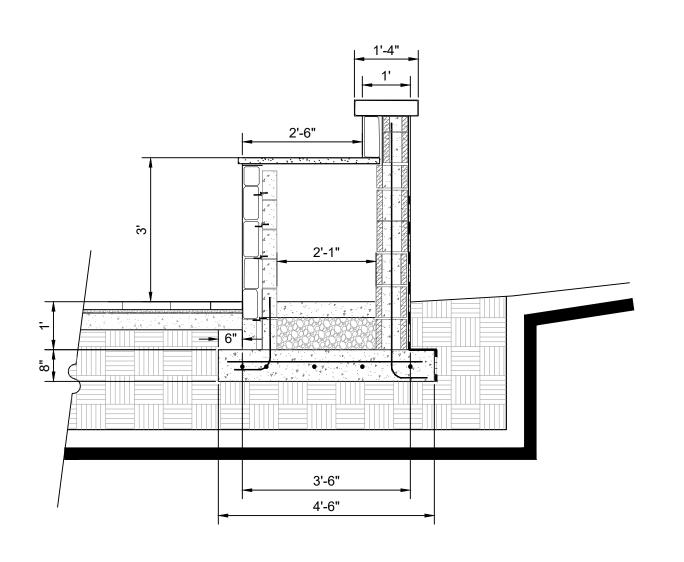

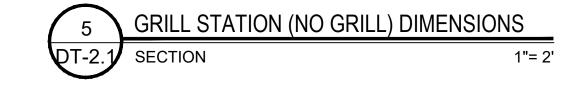

ACREAGE INFORMATION


- TOTAL LOT SIZE (SQ FT): 13,697 TOTAL DISTURBED AREA (SQ FT): 6,000

WATERS OF THE STATE NOTE:

NO WATERS OF THE STATE EXIST WITHIN 200 FEET OF THE PROJECT SITE.

DIRT STATEMENT:

- **Cut: 18 Cubic Yards**
- Fill: 9 Cubic Yards
- **Total Removed From Site: 9 Cubic Yards**

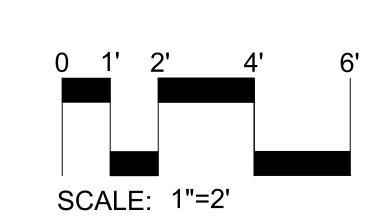

SITE DATA: Tax Parcel ID: 18-001-09-004 Land Lot: District: R-75 Zoning: 0.314 ACRES Acreage: Address: 1339 Chalmette Drive ATLANTA 30306

Owner:

DEKALB COUNTY SUSAN AND BEN CLARE Adam Ardoin 24 Hour contact: 404-556-8691

SHEET NUMBER DT-2.1

12-30-20

FINAL

AND CONSULTING, LLC

678.503.0390-0

GRILL STATION

DETAILS

SCALE

VARIES

Pushes gate closed

Adjustable closing speed

Gently closes both small and large gates up to 125lbs.

Can be installed on top, bottom or middle of gate Recommended for pool, garden and barrier gates Can be used on lightweight (non fire-rated) doors

Works best on gates with in-line/flush hinges



DIMENSIONS & SPECIFICATIONS

Dimensions: Length: 7 1/2" Width: 13"

Depth: 2 1/2" Mounting Bracket Dimensions: 3 1/4" x 1 3/4" Max. Gate Weight: 125 lbs.

Max. Gate Width: 54" Max. Opening Angle: 90 degrees Min. Operating Temperature: 10 degrees Max. Operating Temperature: 110 degrees

Closing/Latching Method: Hydraulic

Material: Steel Finish: Powder-Coated Color: Black

Hinge Arrangements: In-line/flush hinges Opening Pressure: Variable, depending on gate size

Type of Gate Material: Vinyl, Wood, Steel, Chain Link


The LockeyUSA Turtle Back TB100 Hydraulic Gate closer must mount on the hinge side/pull side of the gate in order to push the gate closed. The TB100 works best if the gate has in-line/ flush hinges flush with the gate post with 1" or less gap.

ORDERING INFORMATION Order #: TB100

www.LockeyUSA.com/TB100

SELF CLOSING GATE LATCH

INFORMATION NTS

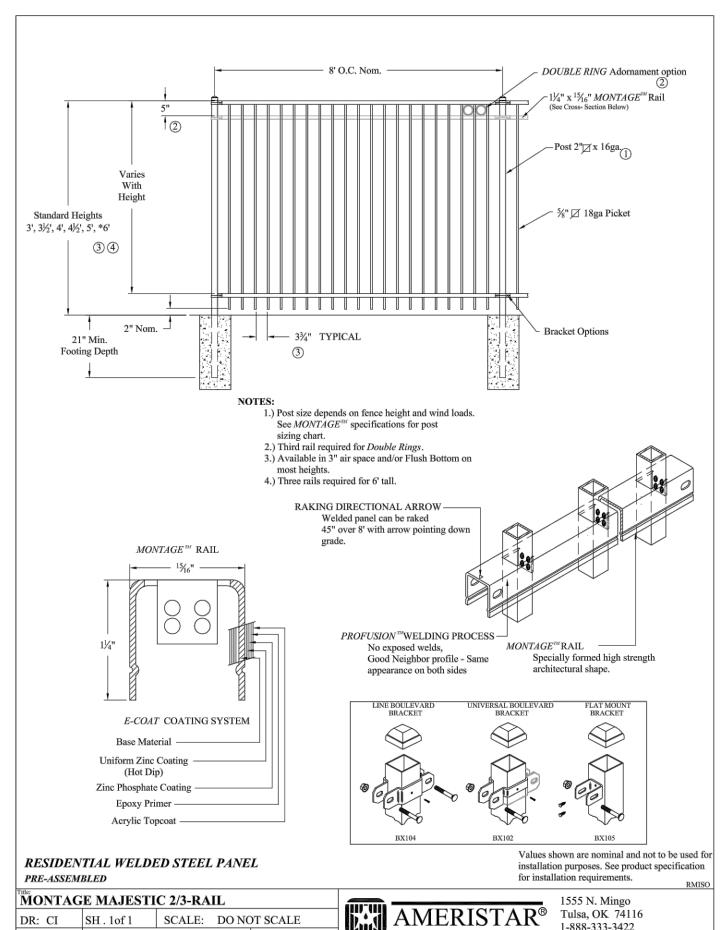

-Fence and Gates not to have third rail. -Fence and Gates to have 52.75" from top of bottom rail to top of top rail. Per code, the rails

DR: CI SH. 1 of 1 SCALE: DO NOT SCALE





SELF CLOSING GATE LATCH PHOTO

3', 3½', 4', 4½', 5', 6'

2" (Hinge Clearance) -

RESIDENTIAL WELDED STEEL GATE

MONTAGE MAJESTIC 2/3-RAIL SGL & DBL GATE

3', 3½', 4', 4½', 5', 6'

NTS

15/16" x 1¼"MONTAGE™Rail

 Post size varies with Height (see MONTAGE" Post-Sizing Chart)

- ¹⁵∕₁₆" x 1¼"*MONTAGE™*Rail

∕ ⅓" Sq. x 18Ga. Picket

Bolt on Hinge

nstallation purposes. See product specification

1555 N. Mingo

Tulsa, OK 74116

1-888-333-3422

1¼"Sq. x 16Ga. √ ¾" Sq. x 18Ga. Picket

1.) Post size depends on fence height, weight and wind loads.

See MONTAGE is specifications for post sizing chart. 2.) See Ameristar gate table for standard out to outs. Custom gate

Additional styles of gate hardware are available on request. This could change the Latch & Hinge Clearance.

Double gate Arrangement

5' HT. DECORATIVE GATES

INFORMATION

NEW MagnaLatch® Top Pull With its release knob out of reach of children, the MagnaLatch Top Pull sets the standard for safety

4x4 Post PT

1 x 6


Board PT

NEW MagnaLatch® Vertical Pull Perfect for pet security gates and general gates around the home. MagnaLatch Vertical Pull offers the gates around swimming pools, childcare centers same innovative design as MagnaLatch Top Pull, only or wherever safety is critical. No wonder it's the in a smaller, more compact model. world's most trusted safety gate latch.

6' HT. WOOD FENCE

ELEVATION

6'-4"

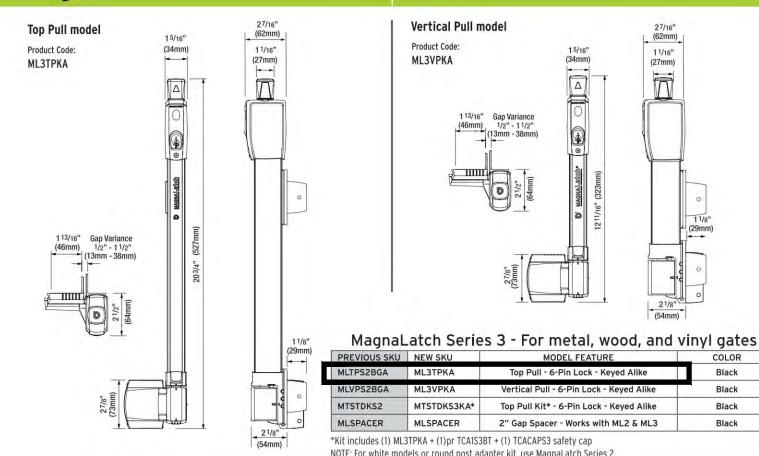

-Use ML3TPKA -To be mounted a minimum of 45" above the ground surface directly below gate.

INFORMATION

POSITIVE LATCHING MECHANISM

TOTAL LOT SIZE (SQ FT): 13,697 TOTAL DISTURBED AREA (SQ FT): 6,000

NO WATERS OF THE STATE EXIST WITHIN 200 FEET OF THE PROJECT SITE.

DIRT STATEMENT:

- **Cut: 18 Cubic Yards**
- Fill: 9 Cubic Yards
- **Total Removed From Site: 9 Cubic Yards**

SITE DATA: 18-001-09-004 Tax Parcel ID: Land Lot: District: Zoning: 0.314 ACRES Acreage: Address: 1339 Chalmette Drive ATLANTA 30306

DEKALB COUNTY SUSAN AND BEN CLARE Owner: 24 Hour contact: Adam Ardoin

12-30-20 FINAL



Fence Side FACING INSIDE of Lot

1"=2'

4x4 Post PT

2x 4 Horiz.

2x 4 Horiz.

nailer PT

Board PT

2x 4 Horiz. nailer PT

1 x 6

nailer PT

6' HT. WOOD FENCE

Fence Side

of Lot

1"=2'

FACING OUTSIDE

SCALE: 1"=2'



WATERS OF THE STATE NOTE:

AND CONSULTING, LLC

678.503.0390-0

MISC DETAILS


SHEET NUMBER DT-3.0



VARIES

404-556-8691 TYP. RAILING ON STEPS



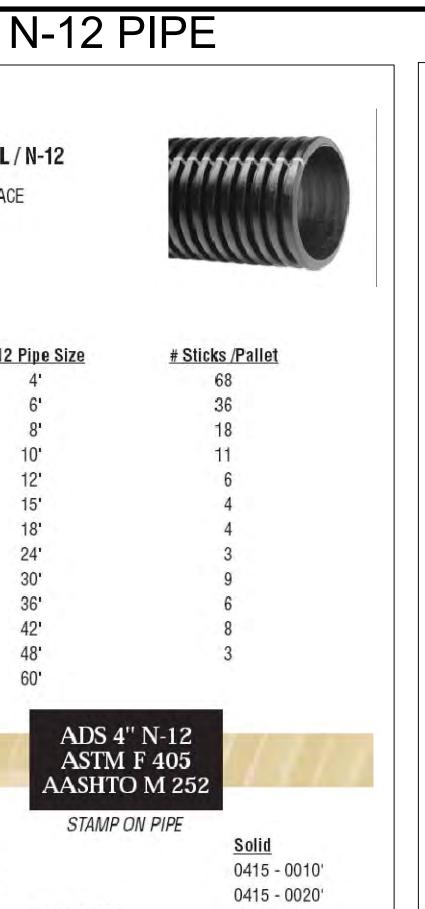

DUAL WALL / N-12

N-12 Pipe Size

ADS 4" N-12

ASTM F 405

STAMP ON PIPE

2 HOLE PIPE

3 HOLE PIPE

W/SOCK (0424HA)

W/SOCK (0424HA)

ADS 6" N-12

ASTM F 405

AASHTO M 252

STAMP ON PIPE

STICK W/SOCK (0624HA)

ADS 8" N-12

ASTM F 667

AASHTO M 252

STAMP ON PIPE

STICK W/SOCK (0824HA)

ADS 10" N-12

ASTM F 667

AASHTO M 252

STAMP ON PIPE

STICK W/SOCK (1024HA)

ADS 12" N-12

ASTM F 667

AASHTO M 294

STAMP ON PIPE

STICK W/SOCK (1224HA) 1295 - 0020'

Solid

0615 - 00101

0615 - 0013

0615 - 00201

0815 - 0013

0815 - 0020'

1015 - 0013

1015 - 0020

1295 - 0010'

1295 - 0013'

N-12 PIPE

Perforated*

0411 - 0020'IB

0611 - 0020'IB

0811 - 0020'IB

1011 - 0020'IB

Perforated

<u>Perforated</u>

Perforated

<u>Perforated</u>

1881 - 0020' IB

2481 - 0020' IB

1581 - 0020' IB

1281 - 0020'IB

*4" - 10" Limited Geographically

1283 - 0020'IB STICK W/SOCK (1224HA)

1583 - 0020' IB STICK W/SOCK (1524HA)

1883 - 0020' IB STICK W/SOCK (1824HA)

2483 - 0020' IB STICK W/SOCK (2424HA)

INTERGRATED BELL

0415 - 0020'IB

0615 - 0020'IB

0815 - 0020'IB

1015 - 0020'IB

1285 - 0020'IB

1585 - 0020' IB

1885 - 0020' IB

2485 - 0020' IB

INNER SURFACE

(4" - 60")

Perforated

0411 - 0010'

0411 - 0020'

0412 - 0010'

0413 - 0010

0423 - 0010'

0423 - 0020'

Perforated

0611 - 0010'

0611 - 0013

0611 - 0020'

0623 - 0020'

Perforated

0811 - 0013"

0811 - 0020'

0823 - 0020'

<u>Perforated</u>

1011 - 0013'

1011 - 00201

1023 - 0020'


<u>Perforated</u>

1291 - 0020'

1293 - 0020'

"plain end" as shown, "bell/spigot end" and "bell/bell end". N-12 Fabricated 11.25° Bends Pipe Size Part # 0491AN 0691AN 0891AN 1091AN 1291AN 1591AN 1891AN 2491AN 3091AN 3691AN 4291AN 4891AN 6091AN N-12 Fabricated 22.5° Bends Part # Pipe Size 0492AN 0692AN 0892AN 1292AN 1592AN 1892AN 2492AN 3092AN 36" 3692AN 4292AN 4892AN 6092AN N-12 Fabricated 30° Bends Pipe Size Part # 0495AN 0695AN 0895AN 1095AN 1295AN 1595AN 1895AN 3095AN 3695AN

These fabricated fittings are also available

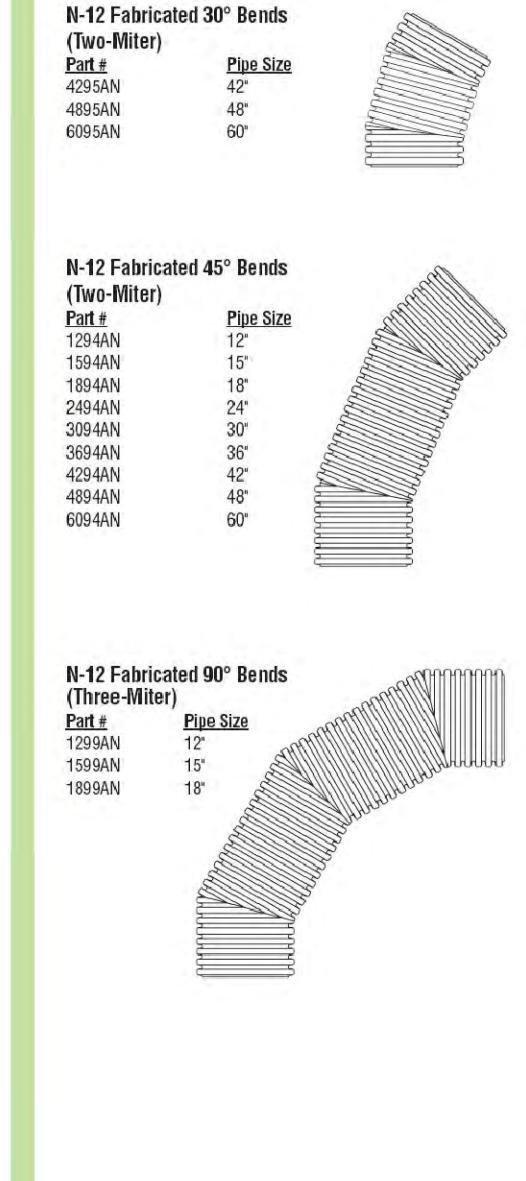

N-12 ADAPTER

N-12 ADAPTER

with Schedule 40 spigot

EXTERNAL COUPLER SW

0312AA

0412AA*

0512AA

0612AA

0812AA

1012AA

with SDR 35 spigot

N-12 BENDS

N-12 ADAPTORS

Size

24"

Size

code

0468 AG

0668 AG

0868 AG

1068 AG

1268 AG

1568 AG

1868 AG

2468 AG

0478 AG

0678 AG

0878 AG

1078 AG 1278 AG


1578 AG

1878 AG


2478 AG

SINGLE WALL PIPE



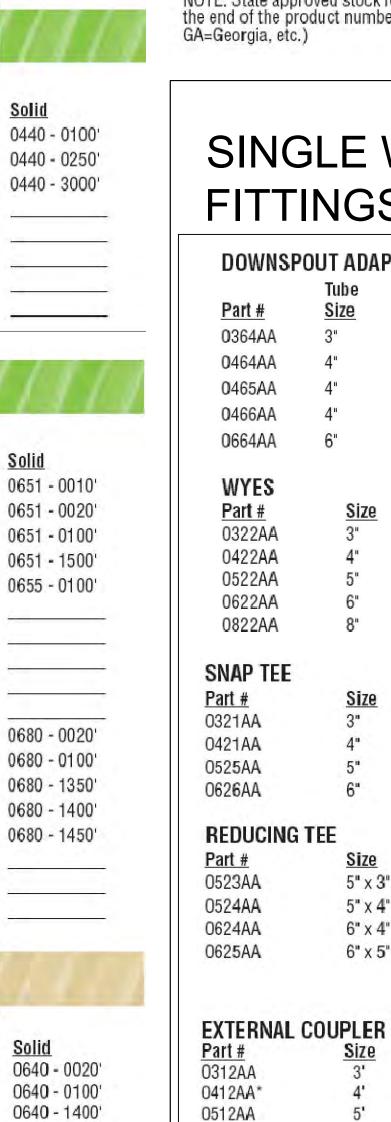



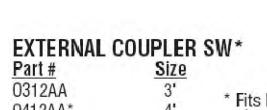

0812AA

1012AA

6" x 5"



* Fits N-12 0612AA

Downspou

 3.25×2.5

3.25 x 2.5

 4.25×3

4 x 6

2.56 x 2.56 Raingo

ADS 8" I.D. **ASTM F 667**

MAXI

	STAMP ON PIPE	
Perforated		Solid
0801 - 0020'	STICK	0851 - 0020
0801 - 0820'	MAXI	0851 - 0820
0870 - 0020'	(SB2) STICK / NO CEREX	
0871 - 0020'	(SB2) STICK W/CEREX (083	35HA)
0872 - 0020'	STICK W/CEREX (0835HA)	
0873 - 0020'	STICK W/SOCK (0824HA)	-
0873 - 0820'	MAXI W/SOCK (0824HA)	

COIL W/SOCK (0425HA)

MAXI W/SOCK (0425HA)

ADS 6" I.D.

ASTM F 405

STAMP ON PIPE

STICK

COIL

MAXI

COIL (WHITE)

6" FINE SLOT PERF

6" FINE SLOT PERF

COIL W/CEREX (0614HA)

COIL W/SOCK (0624HA)

MAXI W/SOCK (0624HA)

COIL W/CEREX (0614HA)

COIL W/SOCK (0624HA)

MAXI W/SOCK (0624HA)

ADS 6" I.D.

AASHTO M 252

STAMP ON PIPE

COIL W/CEREX (0614HA)

COIL W/SOCK (0625HA)

MAXI W/SOCK (0625HA)

0443 - 3000'

Perforated

0601 - 0010"

0601 - 00201

0601 - 0100"

0601 - 1400'

0609 - 0100'

0681 - 00201

0681 - 01001

0681 - 1350"

0681 - 1450'

Perforated

0641 - 00201

0641 - 0100'

0641 - 1400'

0643 - 1400'



SITE DATA: Tax Parcel ID: 18-001-09-004 Land Lot: 12 District: Zoning: 0.314 ACRES Acreage Address: 1339 Chalmette Drive ATLANTA 30306

Owner: 24 Hour contact: **DEKALB COUNTY** SUSAN AND BEN CLARE Adam Ardoin 404-556-8691

DESCRIPTION

FINAL

12-30-20


AND CONSULTING, LLC


678.503.0390-0


DRAINAGE **SPECIFICATIONS**

> SCALE **VARIES**


SHEET NUMBER DR-1.0

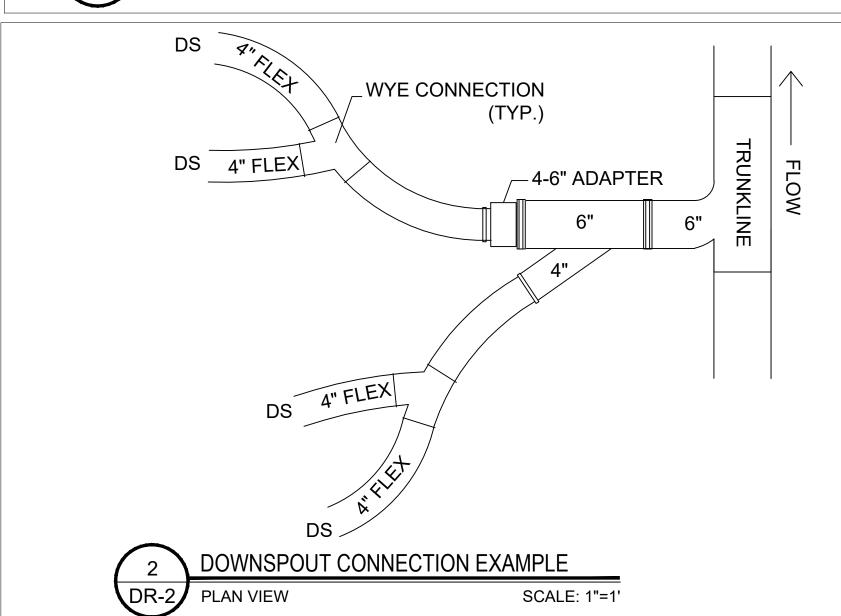

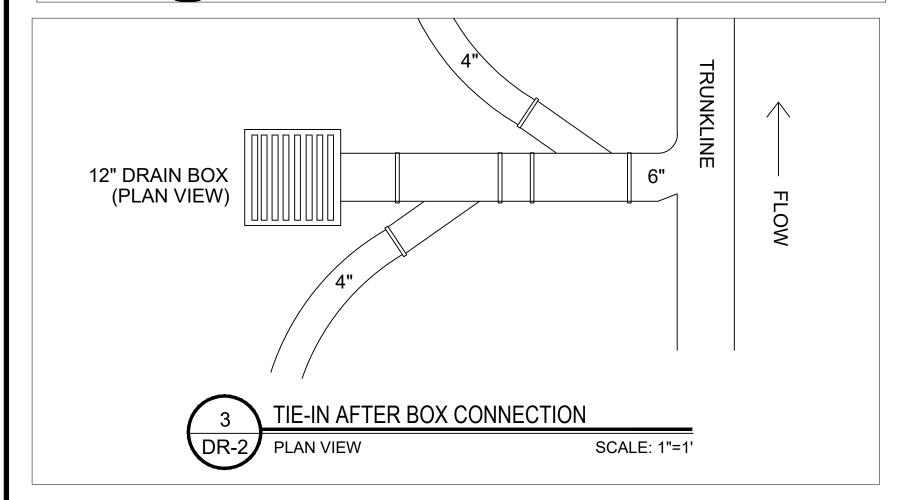

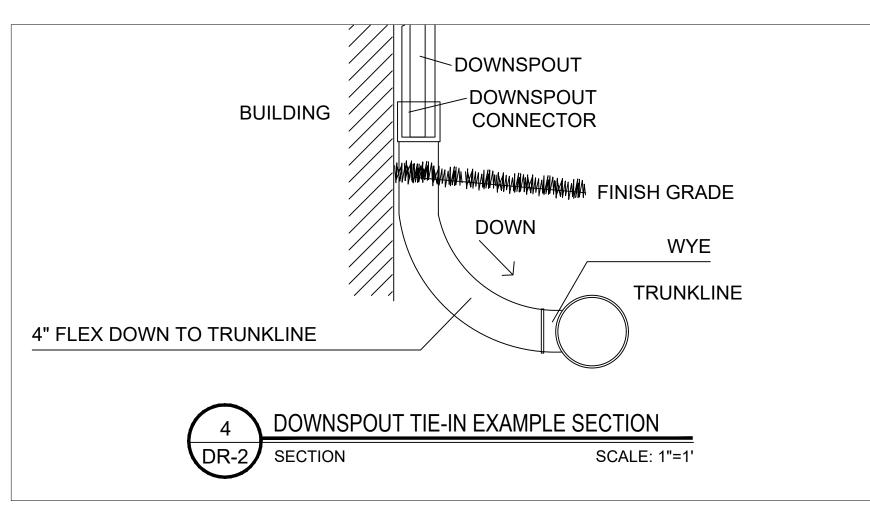

SPEED DRAIN

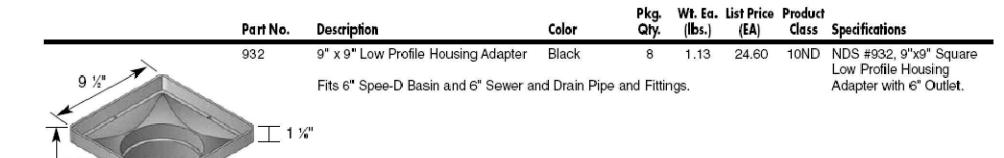

SPEE-D BASINS

Part No.

	Part No.	Description	Color	Pkg. Qty.	Wt. Ea. (lbs.)	List Price (EA)	Product Class	Specifications
6 ½"	101	1 - 3" and 4" Locking Outlet *	Black	10	1.60	13.40	10ND	NDS #101 and #
< >	201	2 - 3" and 4" Locking Outlets *	Black	10	1.90	13.40	10ND	locking outlet #2
8 3/s" 2 3/s" 1" 6" 1" 6"	4 %e"	#101, #201 Outlets fit 3" or 4" Sewer #101 Outlet also fits 4" SCH 40 and Use NDS #66 as Riser for all 6" round *New Locking Outlet snaps on to	d 3" & 4" Triple W and catch basins	all Pipe. (see S&	D fitting	price cata	log).	or #350, 6" Spea Basin. Patent #[

	991	9" x 9" Atrium Grate 9" x 9" Atrium Grate Use with 9"x9" Catch Basin Series.	Green	6	0.87	28.51	10ND	Structural Foam Polyolefin Dome Atrium Grate with UV inhibitor. Open surface area 31.50 square inches. 41.27 GPM.
%" Grate Opening	ps Part No.	Description	Color	Pkg. Qty.	Wt. Ea. (Ibs.)	List Price (EA)		Specifications
	980	9" Square Grate	Black	8	1.50	24.71	10ND	NDS #980, #990, #999, or
OH .	990	9" Square Grate	Green	8	1.50	24.71	10ND	#999S, 9" Square
9"	999	9" Square Grate	Gray	8	1.50	24.71	10ND	Structural Foam Polyolefin
1915.000	999S	9" Square Grate	Sand	8	1.50	24.71	10ND	Grate with UV inhibitor.
	E Para							Open surface area 39.50


(EA) Class Specifications

square inches. 51.75 GPM.


SPEED DRAIN

Use with 9"x9" Catch Basin Series.


	Part No.	Description	Color	Pkg. Qty.	Wt. Ea. (lbs.)	List Price (EA)		Specifications
, 2 3/11	75	4" Atrium Grate	Green	20	0.30	9.39	10ND	NDS #75, #76, #78, or
	76	4" Atrium Grate	Gray	20	0.30	9.39	10ND	#78S, Flat Top Structural
A	78	4" Atrium Grate	Black	20	0.30	9.39	10ND	Foam Polyolefin Atrium
4 1/4"	78S	4" Atrium Grate Fits 4" Sewer and Drain Pipe and F 4" Triple Wall Pipe.				9.39	10ND	Grate with UV inhibitor. Open surface area 17.00 square inches. 22.27 GPM.
4 %s" 4 %s"	<u> </u>	* TO BE CONNEC PIPE	TED DI	REC	TLY	TO 4	4" Fl	_EX

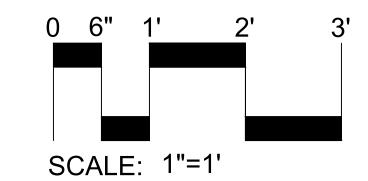

18" DRAIN INLET

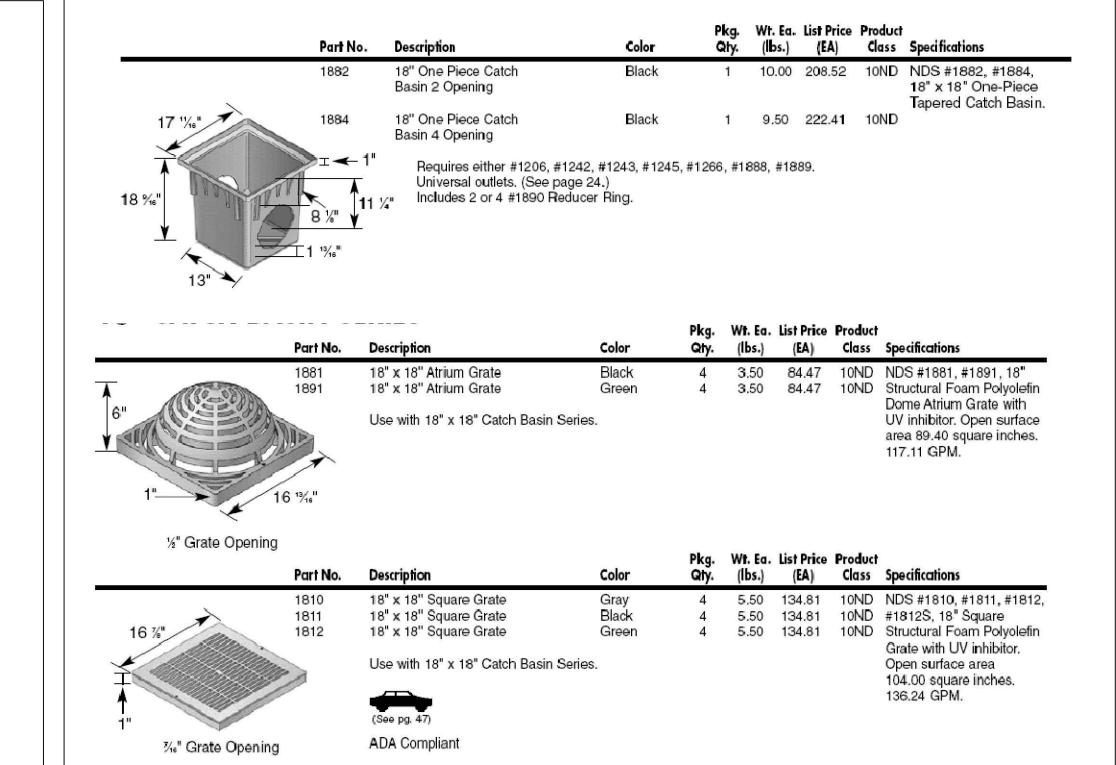

12" DRAIN INLET

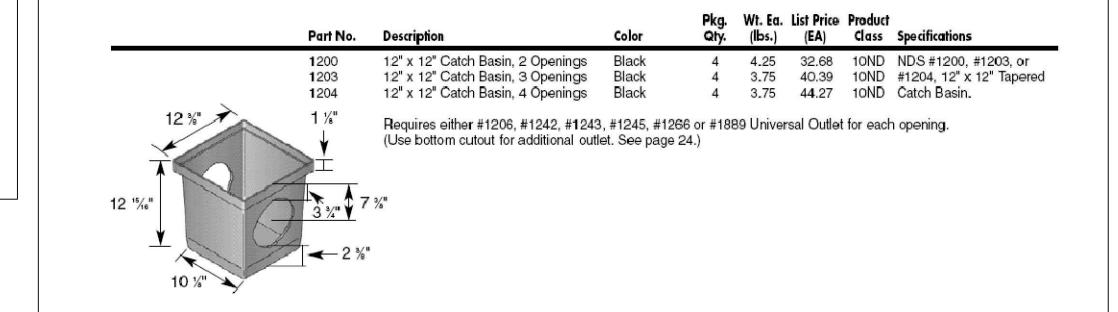

	Part No.	Description	Color	Pkg. Qty.	Wt. Ea. (Ibs.)	List Price (EA)		Specifications
6" 1 1/2"	1280 1290	12" x 12" Atrium Grate 12" x 12" Atrium Grate Use with 12" x 12" Catch Basin Series	Green Black	8 8	2.00 2.00	41.86 41.86	10ND 10ND	NDS #1280, #1290, 12" Structural Foam Polyolefin Dome Atrium Grate with UV inhibitor. Open surface area 50.60 square inches. 66.29 GPM.
%" Grate Opening				n.i				
% drate opening	Part No.	Description	Color	Pkg. Qty.	(lbs.)	List Price (EA)		Specifications
- A drate opening	1210	12" x 12" Square Grate	Gray	Qty. 8	(lbs.) 2.00	(EA) 36.69	Class 10ND	NDS #1210, #1211, #1212,
11 %"	1210 1211	12" x 12" Square Grate 12" x 12" Square Grate	G r ay Black	Qiy. 8 8	(lbs.) 2.00 2.00	(EA) 36.69 36.69	Class 10ND 10ND	NDS #1210, #1211, #1212, or #1212S, 12" Square
	1210	12" x 12" Square Grate	Gray	Qty. 8	(lbs.) 2.00	(EA) 36.69	Class 10ND	NDS #1210, #1211, #1212,



SITE DATA: Tax Parcel ID:

18-001-09-004 Land Lot:

District: Zoning: Acreage:

0.314 ACRES Address: 1339 Chalmette Drive ATLANTA 30306 **DEKALB COUNTY**

SUSAN AND BEN CLARE Owner: 24 Hour contact: Adam Ardoin

404-556-8691

SHEET NUMBER DR-2.0

12-30-20 FINAL





DRAINAGE **SPECIFICATIONS**

678.503.0390-0

VARIES

<u>Home</u> ▶ Flo-well Calculator

NDS Flo-Well Calculator

Step 1:

Enter the Square Feet of Drainage Area 1: (Ex. Roof) Enter the Square Feet of Drainage Area 2: (Ex. Grass)

Step 2:

Choose the Coefficient of Runoff for Area 1: 1.0 (Concrete/Aspl

Choose the Coefficient of Runoff for Area 2: 0.35 (Grass

Step 3:

Choose the 25 Year Rainfall: (see rainfall map). 2.5 in/hr

Step 4:

Enter the depth of the gravel backfill beneath the Flo-Well: (Dimension A) .5

Step 5:

Enter the thickness of the gravel backfill around the Flo-Well: (Dimension B) 2

Step 6:

Press the Calculate button for results: Calculate Reset Print

FLO-WELL SIZING CALCULATIONS

Step 7: view results:

Runoff	40.87 GPM 0.1 CFS
Volume of water	1226.10 Gallons
to be stored	163.92 Cubic feet

of Flo-Wells

Amount of Gravel 13.91 Cubic yards 375.57 Cubic feet

Download Installation Details

Stacked Flo-Well(TM) Installation Detail Side-by-Side Flo-Well(TM) Installation Detail

> Nisit ndspro.com for specs, detail drawings, and case studies

Material: UV Protected High Density Polypropylene (HDPE)

Includes (3) FWSPS33 Side Panels and (1) FWAS24C cover

LFWAS24 also includes (1) FWFF67 Filter Fabric Wrap

Part #: FWAS24

Weight: 18.96 lbs each

Fits: 4" SCH-40 and DWV pipe

Will hold 50 gallons of water

Colors: Black

28 ³/₄ ¹¹

WE PUT WATER IN ITS PLACE

FLO-WELL® STORM WATER

LEACHING SYSTEM

24"

FLO-WELL

WE PUT WATER IN ITS PLACE

NTS

TECHNICAL

SPECIFICATIONS

12-30-20 FINAL




AND CONSULTING, LLC

678.503.0390-0

FLO-WELL SPECIFICATIONS

> SCALE **VARIES**

SHEET NUMBER DR-3.0

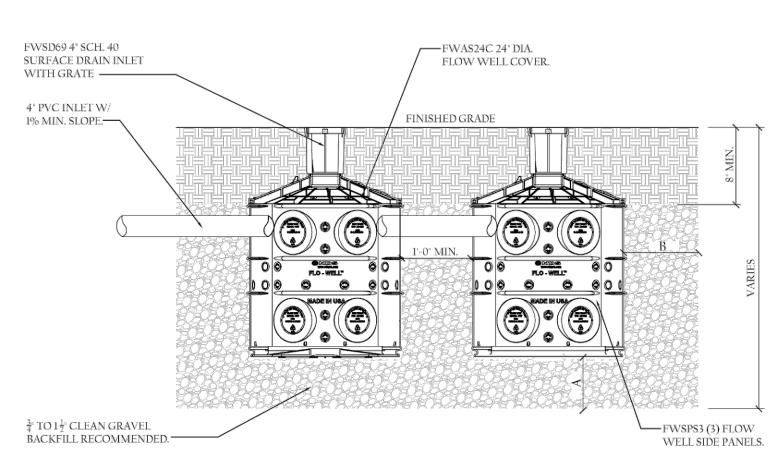

SIDE BY SIDE FLO-WELL **ELEVATION**



Call before you dig.

SITE DATA: Tax Parcel ID: Land Lot:

District: Zoning: R-75 Acreage: 0.314 ACRES Address:

1339 Chalmette Drive ATLANTA 30306 **DEKALB COUNTY** SUSAN AND BEN CLARE Owner:

24 Hour contact: Adam Ardoin 404-556-8691

18-001-09-004

—FWSPS3 (3) FLOW WELL SIDE PANELS. BACKFILL RECOMMENDED. -

FLO-WELL CALCULATIONS

PROPOSED IMPERVIOUS

LOW RETAINING WALL

POOL EQUIPMENT AREA

2'X2' STEPPING STONES (4)

POOL DECK

ADDITIONAL STAIRS BACK PORCH

TOTAL PROPOSED/ADDED IMPERVIOUS

REQUIRED WATER QUALITY VOLUME

(roof area, driveways, patios, and etc.)

PROPOSED IMPERVIOUS TO BE CAPTURED

4 DOWNSPOUTS OF HOUSE (APPROX 67% OF HOUSE)

WQv(cuft)=0.1 x 1573 (Square Feet of Impervious Area)

WQv (gallons)= 0.1 x 1573 (Square Feet of Impervious Area) x 7.5

OVERALL FLO-WELL TANKS (FROM NDS FLO-WELL CALCULATOR)

PROVIDED TOTAL WATER QUALITY VOLUME TO BE CAPTURED (CU. FT.)

CHART

FLO-WELL CALCULATION

FLO-WELL STACK #1 COVERAGE (2 FLO-WELLS, STACKED)

FLO-WELL STACK #2 COVERAGE (2 FLO-WELLS, STACKED)

FLO-WELL STACK #3 COVERAGE (2 FLO-WELLS, STACKED)

REQUIRED TOTAL WATER QUALITY VOLUME

FWSD69 4^a SCH. 40 SURFACE DRAIN INLET

WITH GRATE -

4" PVC INLET W/

1% MIN. SLOPE.—

 $\frac{3}{4}$ " TO $1\frac{1}{2}$ " CLEAN GRAVEL

TOTAL STORMWATER TO BE CAPTURED (SQ. FT.)

SQUARE FEET

1560

1573

1573

54.64

54.64

54.64

157.3 WQv (cuft)

1179.75 WQv (gallons)

NTS

-FWAS24C 24" DIA. FLOW WELL COVER.

FINISHED GRADE

STACKED FLO-WELL **ELEVATION** NTS

NTS