

Chief Executive Officer

DEPARTMENT OF PLANNING & SUSTAINABILITY

Director

Michael Thurmond

Andrew A. Baker, AICP

Application to	or Certificate	of Appropriateness

Date Received:	Application No.:
Address of Subject Property: 1199 OXFORD F	ID NE ATLANTA GA 30306
Applicant: GARRETT COLEY	E-Mail: coleypermits1@gmail.com
Applicant Mailing Address: PO BOX 957421	DULUTH GA 30095
679 896 6679	Fax:
Applicant's relationship to the owner: Owner □ Ar	chitect: ☐ Contractor/Builder ☐ Other AUTHORIZED AGENT
Owner(s): JOE THOMAS & MAGGIE WILS	ON E-Mail: mwilson186@gmail.com
	E-Mail:
Owner(s) Mailing Address: 1199 OXFORD RD	NE ATLANTA GA 30306
Owner(s) Telephone Number: <u>434-981-6203</u>	
Approximate age or date of construction of the prima project: 1929	ary structure on the property and any secondary structures affected by this
Nature of work (check all that apply):	
New construction □ Demolition □ Addition New accessory building □ Landscaping □ Sign installation or replacement □ Other □	Moving a building □ Other building changes □ Fence/Wall □ Other environmental changes □
Description of Work: PROPOSED WORK WILL INCLUDE INTERIOR AL	TERATIONS TO AN EXISTING SINGLE FAMILY HOME
NEW FIREPLACE AT EXISTING REAR F	ORCH AND NEW SIDE ENTRY
	-

This form must be completed in its entirety and be accompanied by supporting documents, such as plans, list of materials, color samples, photographs, etc. All documents should be in PDF format, except for photographs, which may be in JPEG format. Email the application and supporting material to plansustain@dekalbcountyga.gov An incomplete application will not be accepted.

Signature of Applicant/Date

1199 Oxford Road Interior Renovation

COPPER SKY

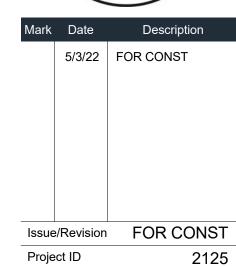


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Oxford Road or Renovation

Mark Date Description 5/3/22 FOR CONST



Issue/Revision FOR CONST
Project ID 2125
CAD File Name central.rvt
Drawn By CP
Checked By CP

COVER SHEET

wing No.
A-0.0

PROJECT INFORMATION

INTERIOR RENOVATION TO AN EXISTING SINGLE FAMILY RESIDENCE. NEW FIREPLACE AT EXISTING REAR PORCH AND NEW SIDE ENTRY.

GOVERNING CODES:

- International Residential Code, 2018 Edition, with Georgia Amendments (2020)
- International Fire Code, 2018 Edition, with Georgia Amendments (2020)
- International Plumbing Code, 2018 Edition, with Georgia Amendments (2020)
 International Mechanical Code, 2018 Edition, with Georgia Amendments (2020)
- International Fuel Gas Code, 2018 Edition, with Georgia Amendments (2020)
- National Electrical Code, 2017 Edition, with no Georgia Amendments
 International Energy Conservation Code, 2015 Edition, with Georgia Supplements
- and Amendments (2020)
 International Swimming Pool & Spa Code, 2018 Edition, with Georgia Amendments
- Prescriptive Deck Details Per 2012 IRC and 2014/15 Amendments

ADDRESS: 1199 Oxford Road Atlanta, Ga 30306

LAND LOT: DISTRICT: -

COUNTY: DeKalb

ZONING: R-85 (DeKalb County Uninc)
Druid Hills Historic District

NET LOT AREA: 13,940 sf (.32 Acre)
GROSS LOT AREA: -

EXISTING SF: 4,101 sf

NEW SF: 4,101 Sf (No Change to Cxisting)

LOT COVERAGE (35% MAX)
BLDG FOOTPRING + PAVING + DECKS / NET LOT AREA:

EXISTING No Change to Existing
PROPOSED No Change to Existing

BUILDING CODE DATA

STORIES HEIGHT

WEATHER MODERATE
FLOOD HAZARDS NONE (NOT IN FLOOD PLAIN, NO STATE WATERS WITHIN 200' OF SITE)

NO CHANGE

WIND SPEED 90 MPH, Exposure B

WINTER DESIGN TEMP 22 de GROUND SNOW LOAD 5 psf

TYP DEAD LOADS

20 psf Roof, 15 psf Floor, 10 psf Attic
40 psf, 30 psf sleeping rooms

20 psf Roof, 15 psf Floor, 10 psf Attic
40 psf, 30 psf sleeping rooms

TYP ROOF LOAD

TERMITE

FROST LINE DEPTH

MEAN ANNUAL TEMP

SEISMIC DESIGN CATEGORY

20 psf

SEVERE

12"

66.2 deg

SYMBOL LEGEND

ABBREVIATIONS

MFR. MANUFACTURER

MTL. METAL

PROJECT DIRECTORY

Joe Thomas & Maggie Wilson

EMAIL: mwilson186@gmail.com

EMAIL: jim.walker@coppersky.net

EMAIL: cpatton@pattonarchitects.com

107 Weatherstone Drive, Suite 540

EMAIL: maria@3lpengineering.com

CONTACT: Maggie Wilson

PHONE: 434.981.6203

Copper Sky Renovations

CONTACT: Jim Walker

PHONE: 404.931.7419

Patton Architects, LLC

CONTACT: Cody Patton

PHONE: 404.368.2399

Woodstock, GA 30188

PHONE: 954.261.8936

CONTACT: Maria Arguellas

1698 Fernleaf Circle

Atlanta, GA 30318

STRUCTURAL:

MEP:

COLUMN NUMBER

AND LINE

Design / Build

3LP Engineering

1155 Zonolite Rd Suite A2

OWNER:

1199 Oxford Road

Atlanta, Ga 30306

CONTRACTOR:

Atlanta, Ga 30306

ARCHITECT:

A.D.A.	AMERICANS W/ DISABILITIES ACT	N/A	NOT APPLICABLE
AFF	ABOVE FINISHED FLOOR	N.I.C.	NOT IN CONTRACT
ARCH.	ARCHITECT / ARCHITECTURAL	N.S.F.	NET SQUARE FOOTAGE
BD.	BOARD	O.C.	ON CENTER
BLDG.	BUILDING	O.D.	OUTSIDE DIAMETER
C.L.	CENTERLINE	O.H.	OPPOSITE HAND
CLG.	CEILING	P-LAM.	
CLR.	CLEAR	PLYWD.	PLYWOOD
C.M.U.	CONCRETE MASONRY UNIT	PROJ.	PROJECT / PROJECTION
COL.	COLUMN	PT.	PAINT
CONC.	CONCRETE	P.T.	PRESSURE TREATED
CONST.	CONSTRUCTION	QTY.	QUANTITY
CONT.	CONTINUOUS	RCP	REFLECTED CEILING PLAN
CPT.	CARPET	RAD.	RADIUS
DIA.	DIAMETER	R.O.	ROUGH OPENING
DIM.	DIMENSION	S.C.	SOLID CORE
	DOWN	SCHED.	SCHEDULE
	DETAIL	SECT.	SECTION
ELEC.	ELECTRIC / ELECTRICAL	S.F.	SQUARE FOOT / SQUARE FOOTAGE
	ELEVATION / ELEVATOR	SIM.	SIMILAR
,-	EQUAL	SPEC.	SPECIFICATION
	EXISTING	SQ.	SQUARE
	EXTERIOR	STD.	STANDARD
	FIRE EXTINGUISHER	TEMP.	TEMPORARY
	FIXTURE	T.O.	TOP OF
	FOOT / FEET	T.O.S.	
_	GROSS SQUARE FOOTAGE	T.O.W.	TOP OF WALL
_	GYPSUM WALL BOARD	TYP.	TYPICAL
GYP.	GYPSUM	U.N.O.	UNLESS NOTED OTHERWISE
H.C.	HOLLOW CORE / HANDI-CAP	V.I.F.	VERIFY IN FIELD
H.M.	HOLLOW METAL	VCT	VINYL COMPOSITION TILE
	HEIGHT	V.O.J.	VERIFY ON JOB
	HEATING VENTILATION & AIR CONDITION	-	WITH
IN.	INCH	W/O	WITHOUT
	LINEAR FEET	W.C.	WATER CLOSET
MAT'L.	MATERIAL	WD.	WOOD

W.H.

WATER HEATER

WEIGHT

GENERAL NOTES

- Construction shall conform to the requirements of all governing federal, state, and local codes.
- 2. All materials, hardware and fixtures will be U.L. listed.
- 3. The drawings illustrate general workscope requirements and do not elaborate on installation techniques. All work performed shall meet or exceed industry standards, be performed in accordance with manufacturer's recommendations, and shall conform to all provisions of state, county and city codes, building laws, ordinance rules and regulations.
- 4. Contractor or Owner shall obtain and pay for building permits.

5. Coordinate exact locations of conduit, ductwork, mechanical and electrical devices, and light fixtures with the Architect in the field.

6. All partitions are dimensioned to finish face of partition unless noted otherwise. All dimensions shown on the drawings shall be considered critical. It shall be the responsibility of the contractor to notify the Architect of any deviation in the placement of work prior to installation.

7. Drawings are furnished to show design intent for construction only and do not show every condition or aspect of construction. Contractor to inform the Architect of any discrepancies or unforseen conditions prior to proceeding with any work. Do not scale drawings. Dimensions govern.

8. Contractor to remove existing soils to allow for new construction. See Civil Drawings.

9. Debris resulting from the construction shall be removed entirely from the construction site on a daily basis to a waste area provided by the contractor.

10. All work shall be done in a workmanlike manner and in accordance with accepted construction standards. All walls, ceilings, and other assemblies to be plumb, true, and square, unless otherwise noted.

11. Mechanical, electrical and plumbing scope, fixtures and locations will generally be noted on the drawings. The contractor is responsible for providing permit drawings and obtaining all MEP permits.

12. Double studs construction to be used at all cased and door openings.

13. Outlets and utilities indicated on plan are minimum requirements. Additional telephones or outlets may be required by code or by owner. General Contractor to verify all locations in field.

14. All floor and wall penetrations in rated assemblies shall be sealed with approved, current firestop assemblies appropriate for the rated wall assembly.

15. Contractor is responsible for soil testing. Contractor is responsible for any required testing of material and assemblies installed by contractor.

16. All assemblies, material to meet current Georgia Energy Code requirements.

17. Interior finishes, materials, and furnishings shall comply with and meet the smoke and fire rating requirements of all state and local codes. In particular, all interior finishes shall meet requirements set forth in the standard building code.

18. Final clean-up of building and site shall be the responsibility of the general contractor. Building and site shall be turned over in a clean and new condition.

19. Provide one fire extinguisher per residential unit.

20. Not Used.

21. All lumber in contact with concrete slabs, exterior masonry walls, or in conjunction with concrete slabs, exterior masonry walls, or in conjunction with gravel stops or roofing shall be preservative treated in accord with AWPA C1-77 and AWPI LP-22, CCA, Type A, non-leaching type preservative.

22. Not Used.

23. The contractor shall provide a warranty for correction of the work of this project for the period of one year after substantial completion or as otherwise stipulated in the contract documents.

24. The Architect is not responsible for changes made or authorized by the owner, owner's representatives, tenants, contractor or others without written consent by the architect or consultant.

25. The contractor shall be responsible for coordination of structural, mechanical, electrical, and plumbing work with the architectural drawings. All discrepancies in the documents shall be reported to the architect for resolution of any conflicts with any design elements before the work is done.

26. The contractor shall field verify construction tolerances and take field measurements of any existing conditions related to the work of this project. Unforseen conditions encountered at the site materially different from those indicated in the contract document shall be promptly reported to the Architect or owner's representative before the conditions are disturbed.

27. The contractor shall be responsible for all cutting, patching and fitting necessary to achieve the scope of the work.

28 Existing utilities or other mechanical, electrical, or plumbing equipment requiring removal, capping, termination,

and/or relocation shall be included in the overall scope and performance of the project by the contractor.29. All substrate surfaces are to be prepared to receive finish materials per manufacturer's product literature and

written instructions for installation, or application. Fill voids in round columns prior to applying finish materials.

30. The contractor shall verify that no conflicts exist in locations of any and all mechanical, telephone/data, electrical, lighting and plumbing equipment (to include all piping, ductwork, and conduit) and that all required clearance for installation or maintenance or above equipment is provided.


31. The contractor shall provide and install equipment and appliances specified unless otherwise noted. The contractor shall verify all plumbing and electrical requirements related to equipment and appliances in the scope of work.


DESCRIPTION A-0.0 | COVER SHEET Χ A-2. 01 | FLOOR PLANS EXISTING A-2. 02 | FLOOR PLANS EXISTING A-3.0 ELEVATIONS AS-BUILT |X|FLOOR PLANS DEMO | X | X |FLOOR PLANS NEW $X \mid X$ A-2.2 FLOOR PLANS NEW $X \mid X \mid$ A-3.1 EXTERIOR ELEVATIONS $X \mid X \mid$ **STRUCTURAL** S-2.1 STRUCTURAL BEAM SKETCH | X | S-2.2 STRUCTURAL BEAM SKETCH SEE STRUCTURAL LETTER AND SKETCHES DATED APRIL 15, 2022 BY 3LP ENGINEERING


DRAWING LOG


ARCHITECTURAL

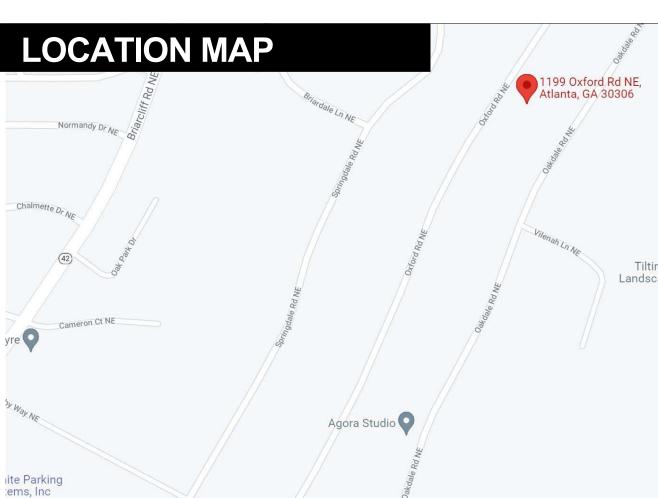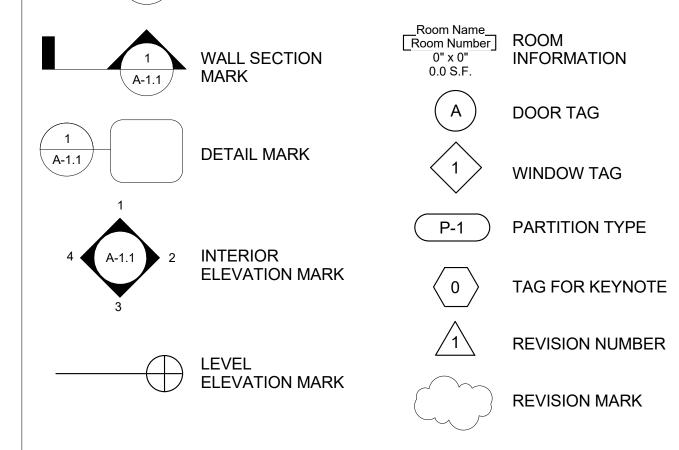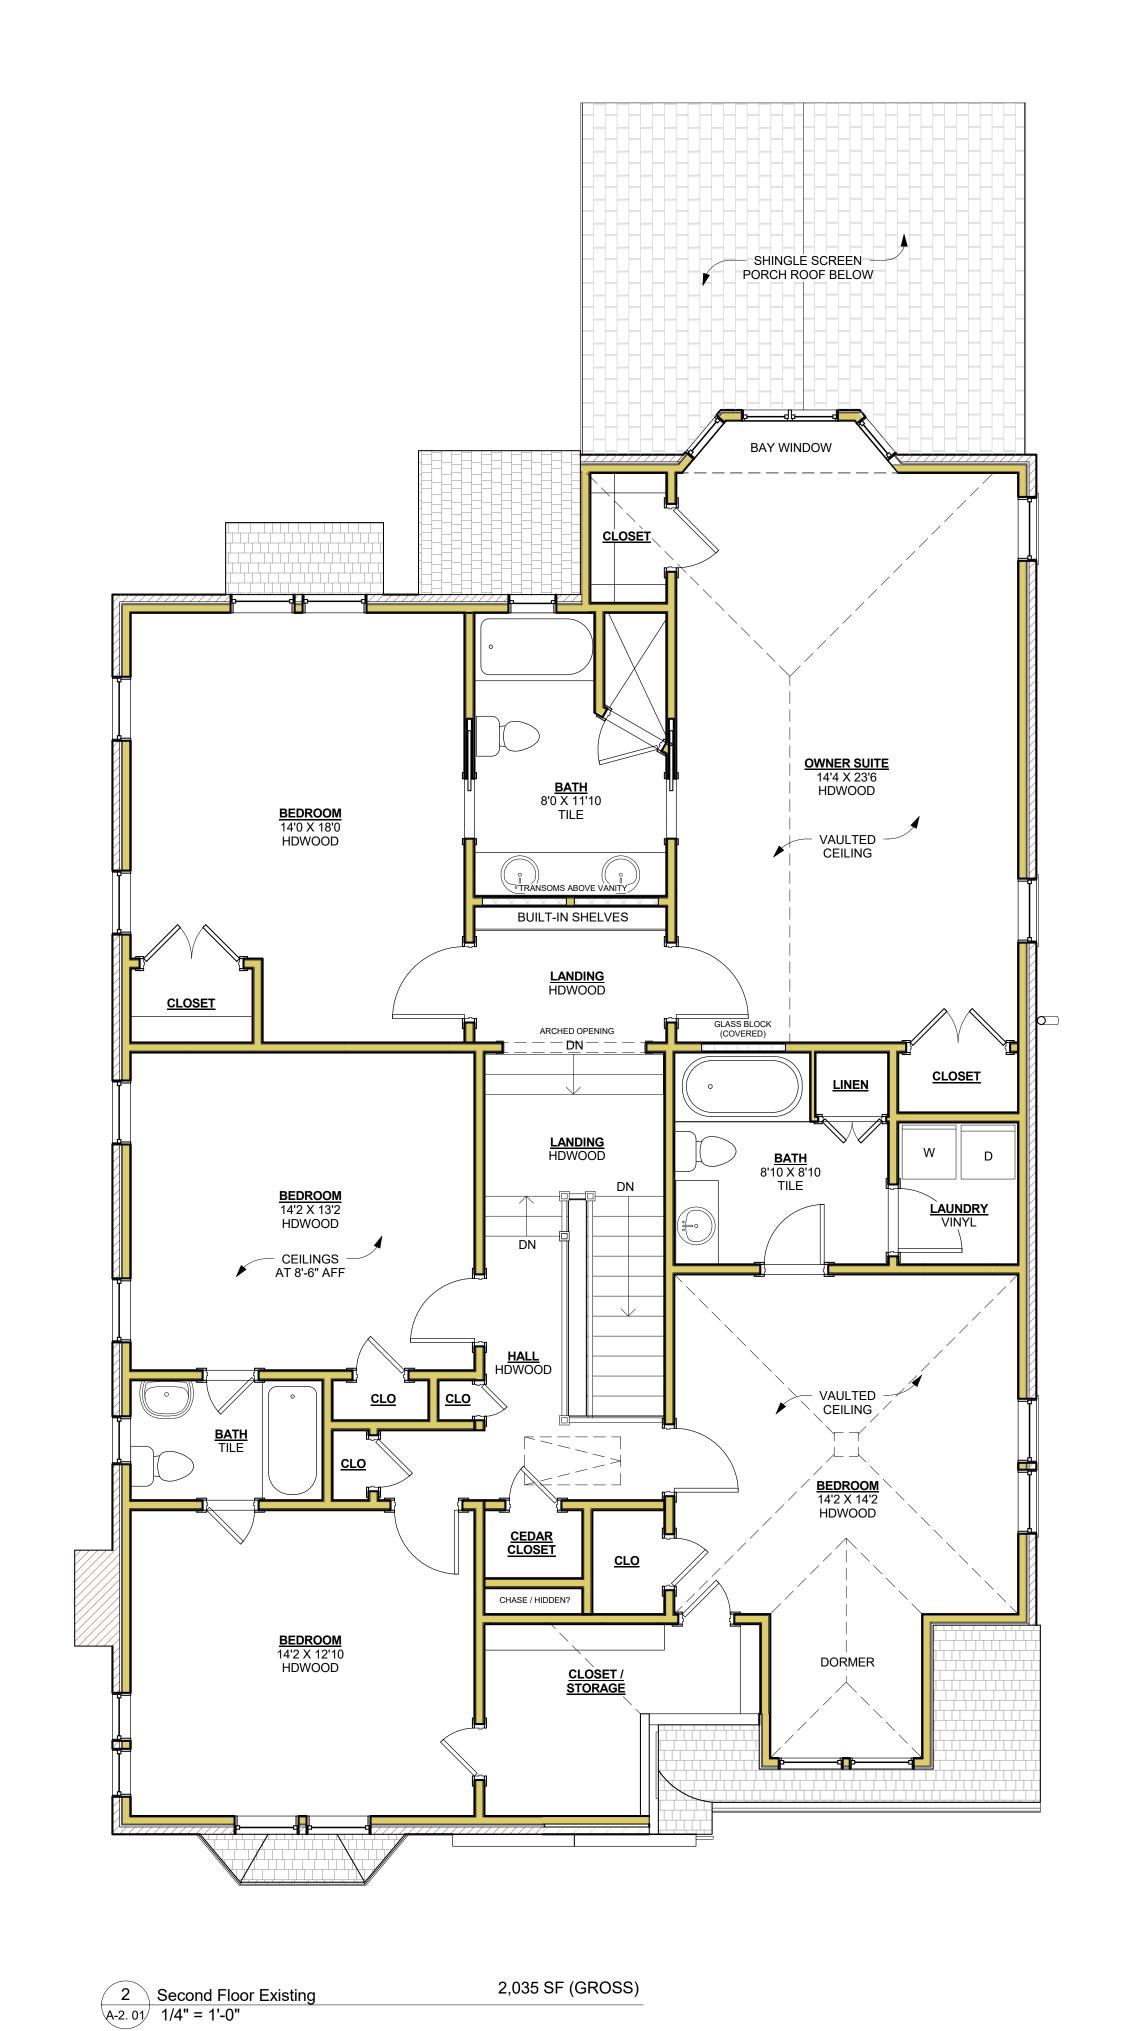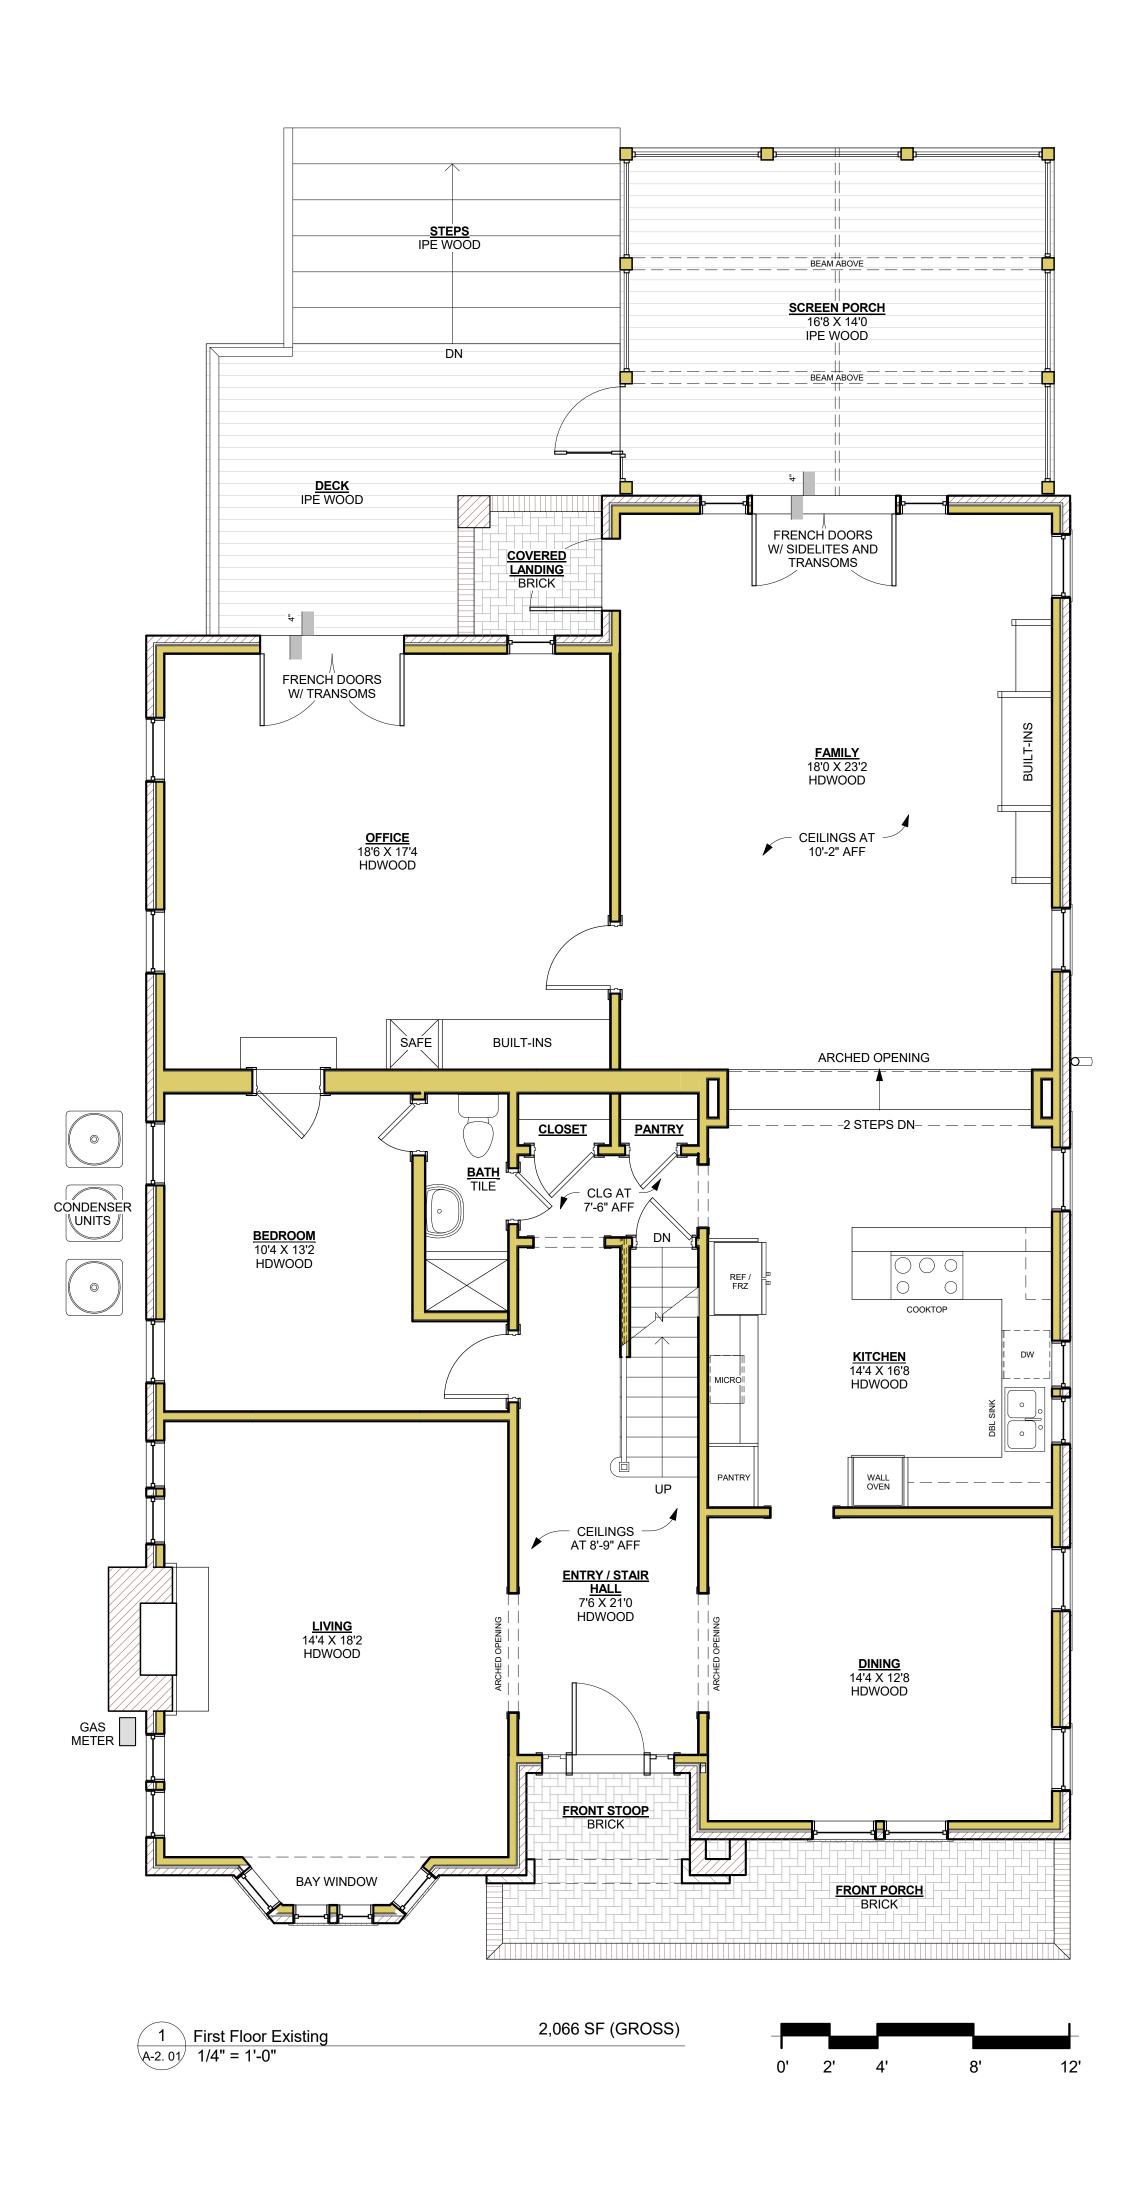Chalmette Dr. NE











10/29/21 AS BUILT

Issue/Revision

CAD File Name

Project ID

Drawn By

Checked By Sheet Title

5/3/22 FOR CONST

FLOOR PLANS

EXISTING

A-2. 01

FOR CONST

2125

CP

CP

central.rvt



Iterior RenovationAtlanta, Ga 30306
DeKalb County Oxford Road

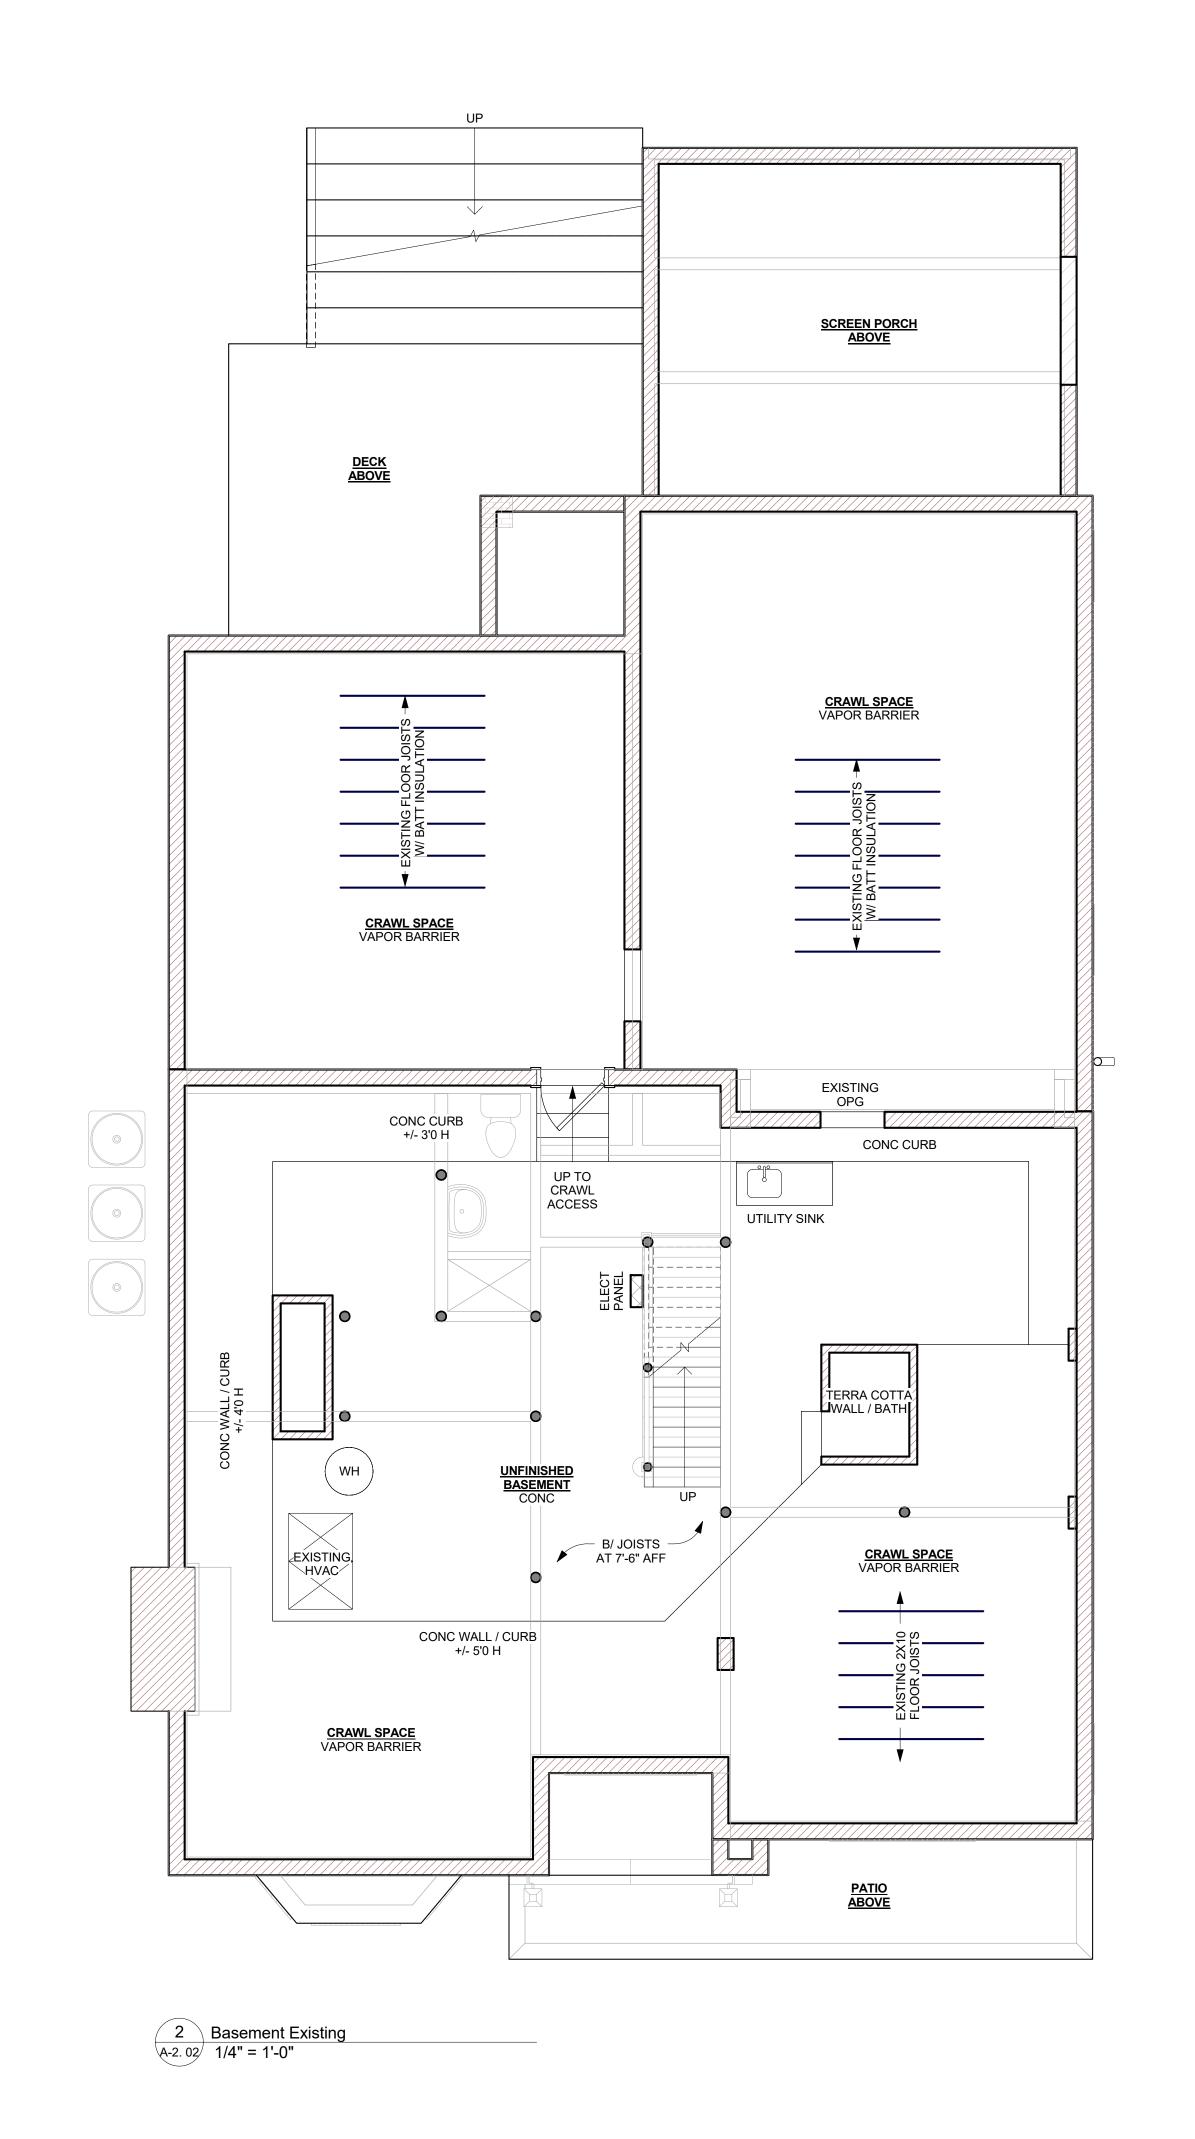
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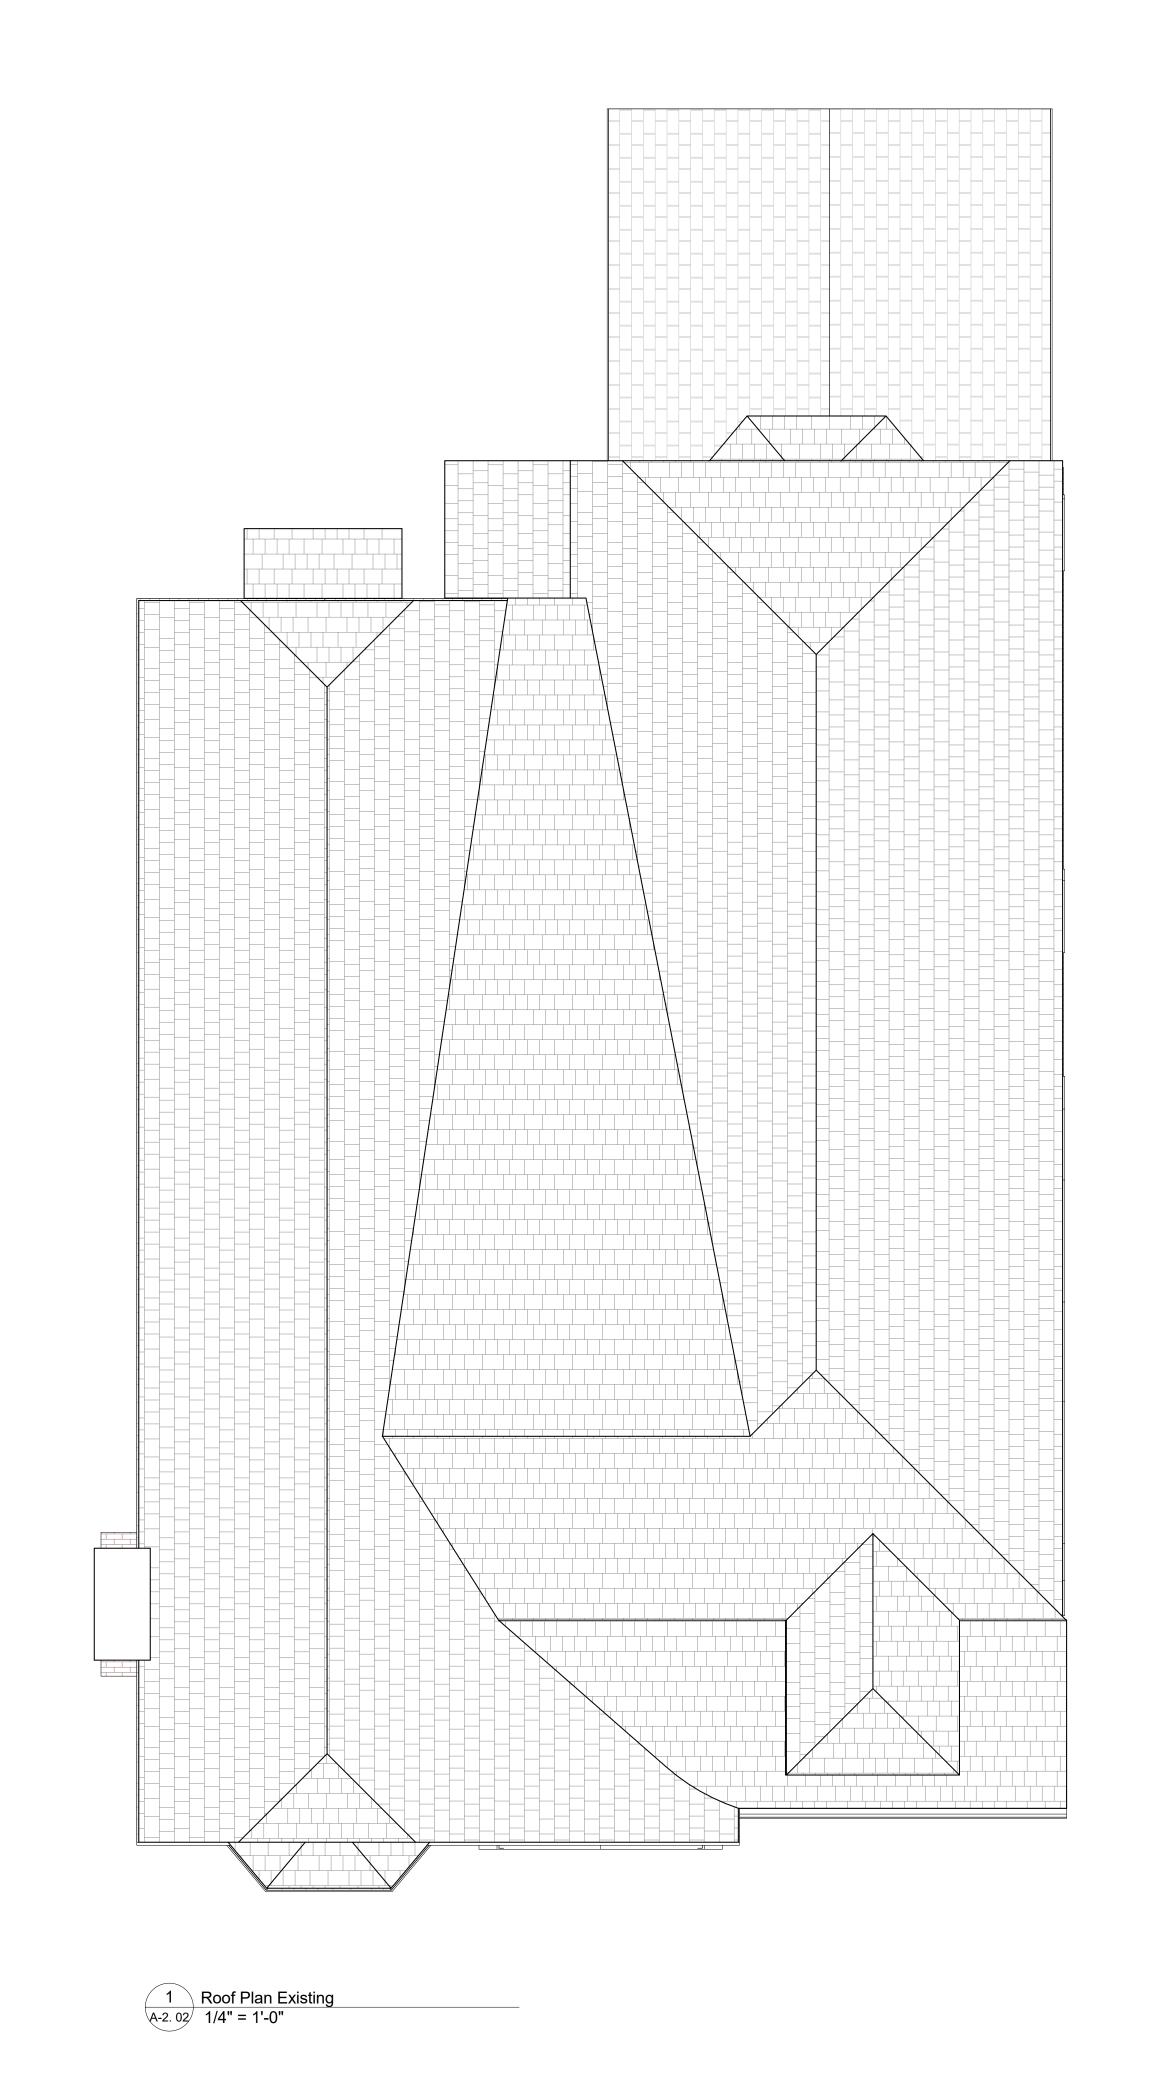
PATTON ARCHITECTS


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Issue/Revision FOR CONST

FLOOR PLANS

EXISTING

Project ID

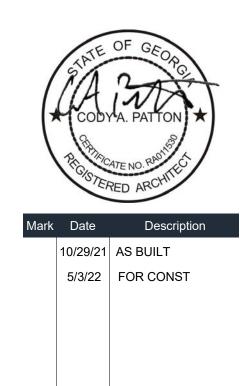Drawn By

Checked By Sheet Title

CAD File Name

2125

CP

CP

central.rvt



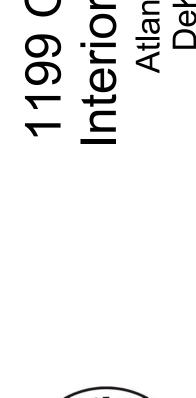














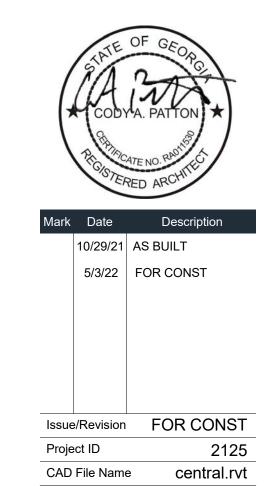
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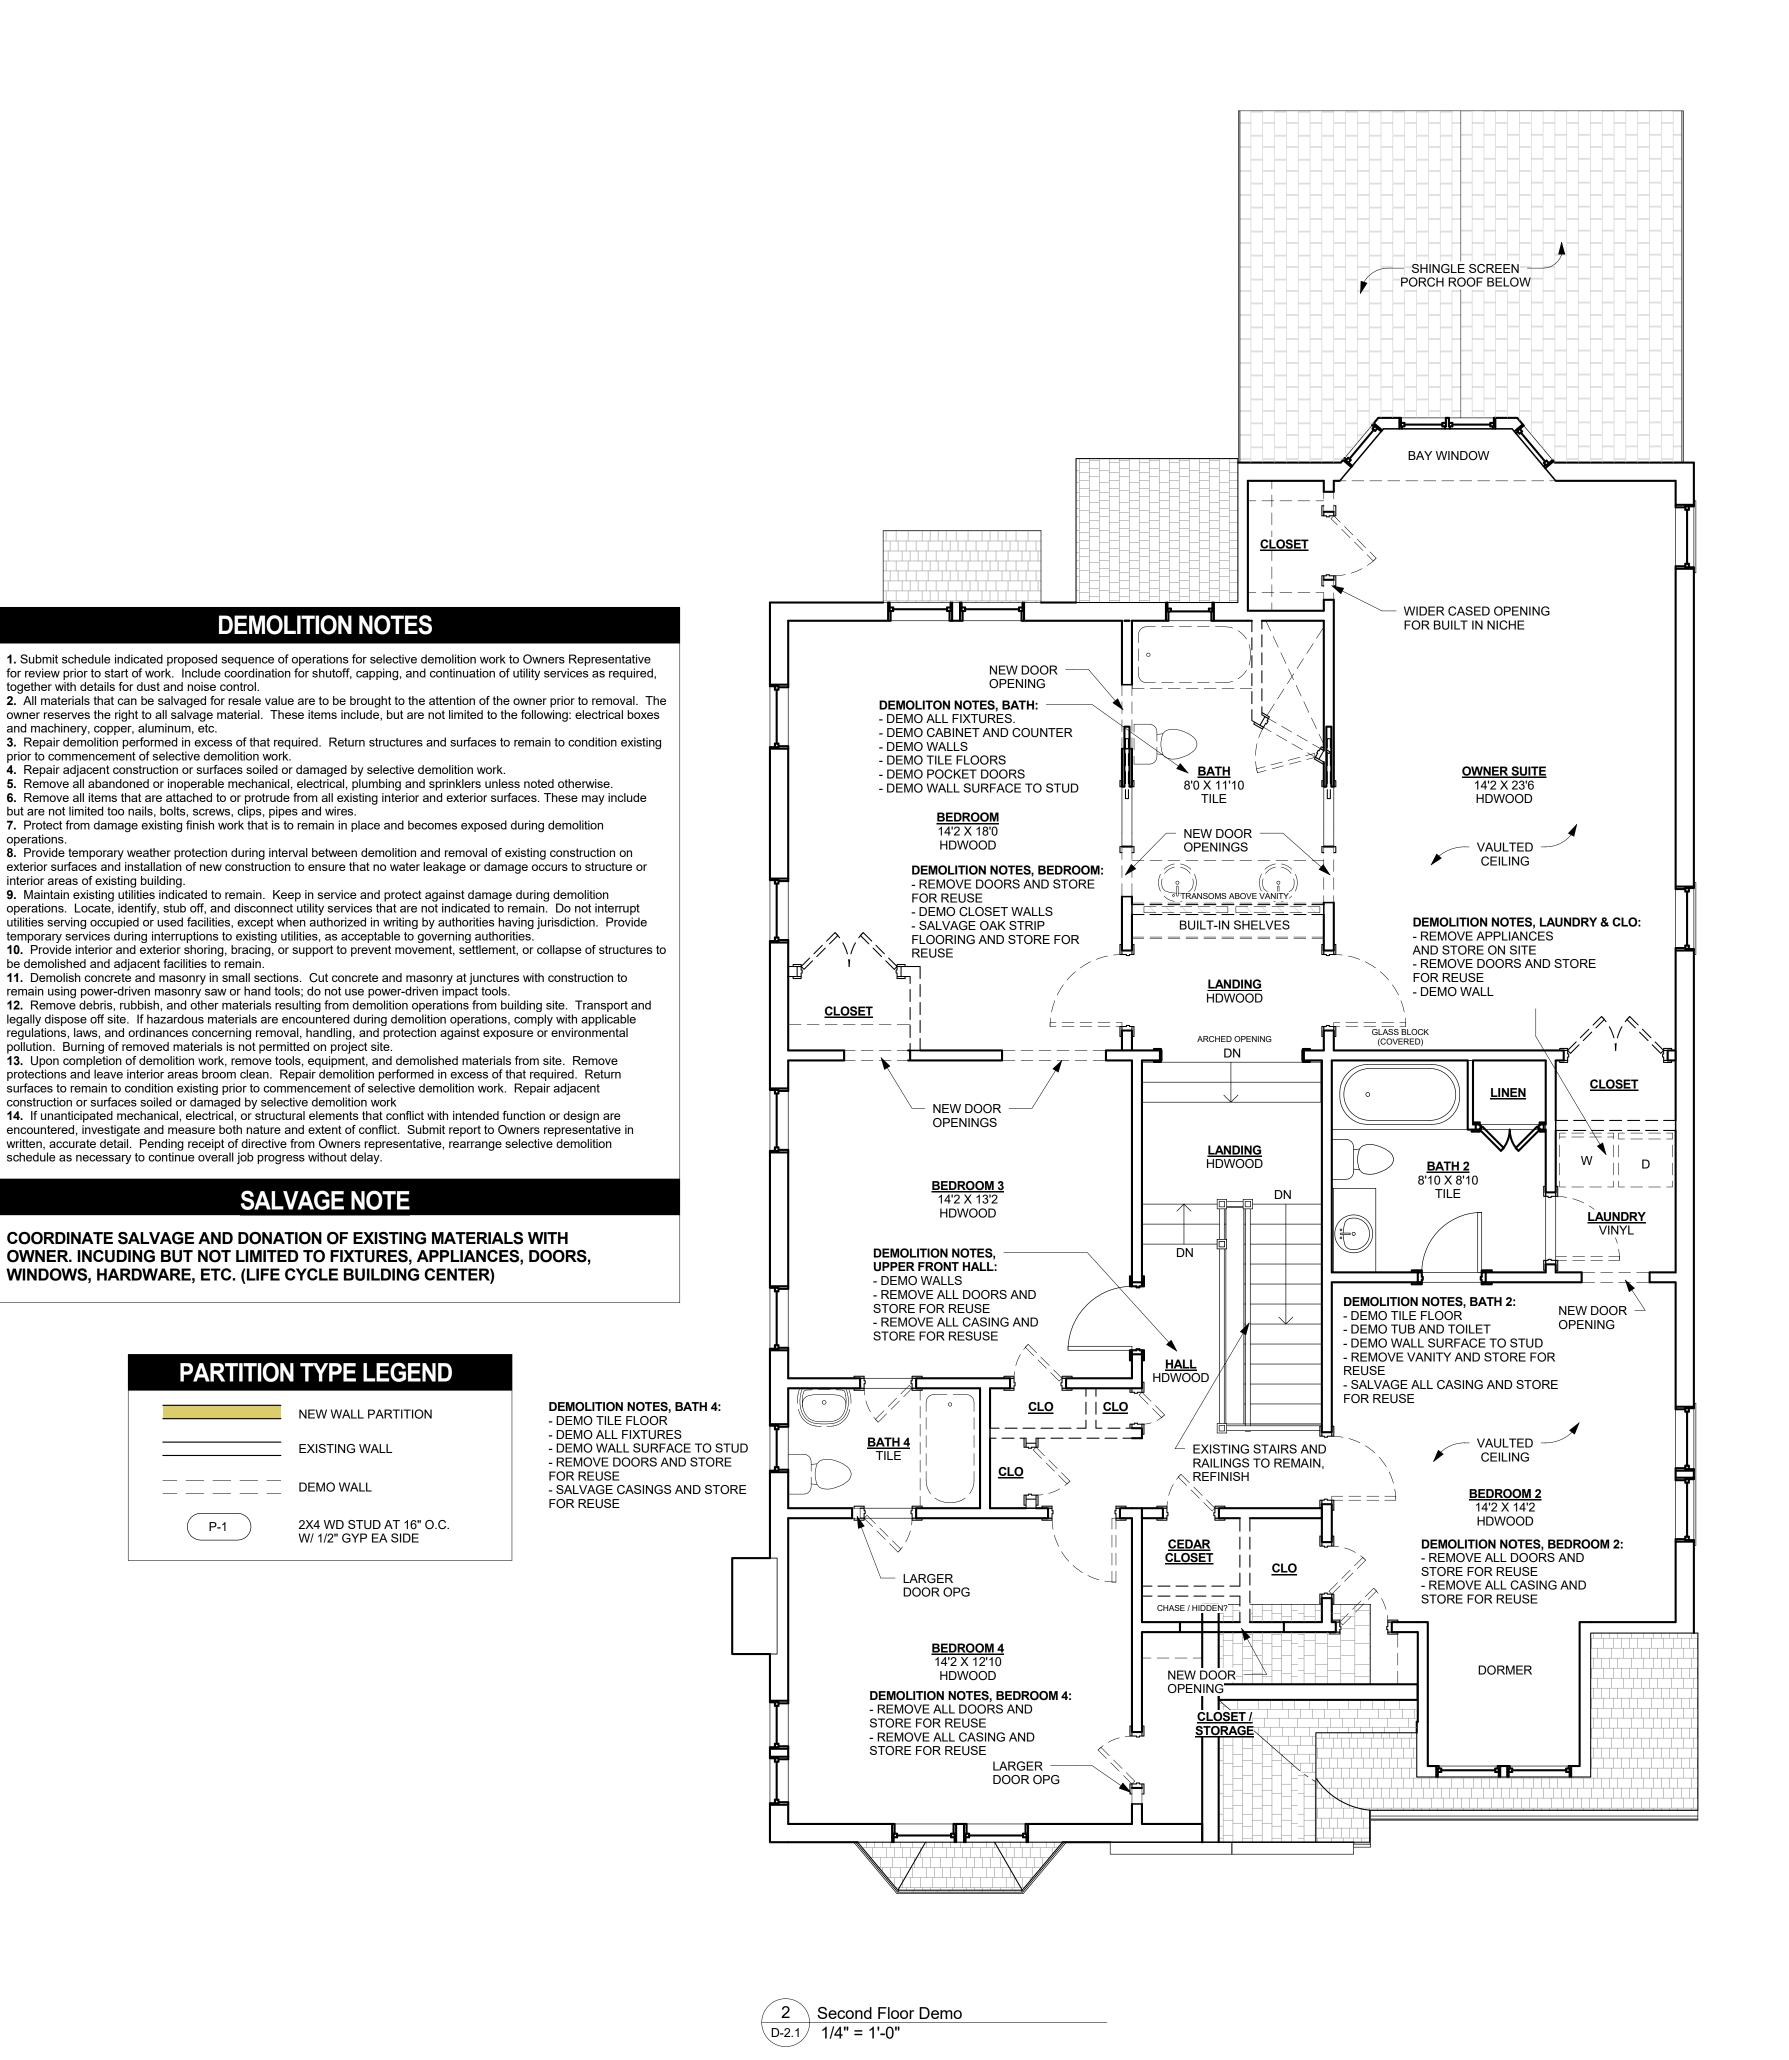
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CP CP Checked By

ELEVATIONS AS-BUILT

Right Elevation Existing
A-3.0 1/4" = 1'-0"



DEMOLITION NOTES

1. Submit schedule indicated proposed sequence of operations for selective demolition work to Owners Representative

together with details for dust and noise control.

prior to commencement of selective demolition work.

be demolished and adjacent facilities to remain.

but are not limited too nails, bolts, screws, clips, pipes and wires.

pollution. Burning of removed materials is not permitted on project site.

construction or surfaces soiled or damaged by selective demolition work

schedule as necessary to continue overall job progress without delay.

and machinery, copper, aluminum, etc.

interior areas of existing building.

for review prior to start of work. Include coordination for shutoff, capping, and continuation of utility services as required,

3. Repair demolition performed in excess of that required. Return structures and surfaces to remain to condition existing

6. Remove all items that are attached to or protrude from all existing interior and exterior surfaces. These may include

8. Provide temporary weather protection during interval between demolition and removal of existing construction on

exterior surfaces and installation of new construction to ensure that no water leakage or damage occurs to structure or

operations. Locate, identify, stub off, and disconnect utility services that are not indicated to remain. Do not interrupt

utilities serving occupied or used facilities, except when authorized in writing by authorities having jurisdiction. Provide

11. Demolish concrete and masonry in small sections. Cut concrete and masonry at junctures with construction to

12. Remove debris, rubbish, and other materials resulting from demolition operations from building site. Transport and

legally dispose off site. If hazardous materials are encountered during demolition operations, comply with applicable

regulations, laws, and ordinances concerning removal, handling, and protection against exposure or environmental

13. Upon completion of demolition work, remove tools, equipment, and demolished materials from site. Remove protections and leave interior areas broom clean. Repair demolition performed in excess of that required. Return surfaces to remain to condition existing prior to commencement of selective demolition work. Repair adjacent

14. If unanticipated mechanical, electrical, or structural elements that conflict with intended function or design are

written, accurate detail. Pending receipt of directive from Owners representative, rearrange selective demolition

COORDINATE SALVAGE AND DONATION OF EXISTING MATERIALS WITH

WINDOWS, HARDWARE, ETC. (LIFE CYCLE BUILDING CENTER)

_ _ _ _ _ _

P-1

OWNER. INCUDING BUT NOT LIMITED TO FIXTURES, APPLIANCES, DOORS,

PARTITION TYPE LEGEND

NEW WALL PARTITION

2X4 WD STUD AT 16" O.C.

W/ 1/2" GYP EA SIDE

FOR REUSE

FOR REUSE

EXISTING WALL

DEMO WALL

encountered, investigate and measure both nature and extent of conflict. Submit report to Owners representative in

SALVAGE NOTE

5. Remove all abandoned or inoperable mechanical, electrical, plumbing and sprinklers unless noted otherwise.

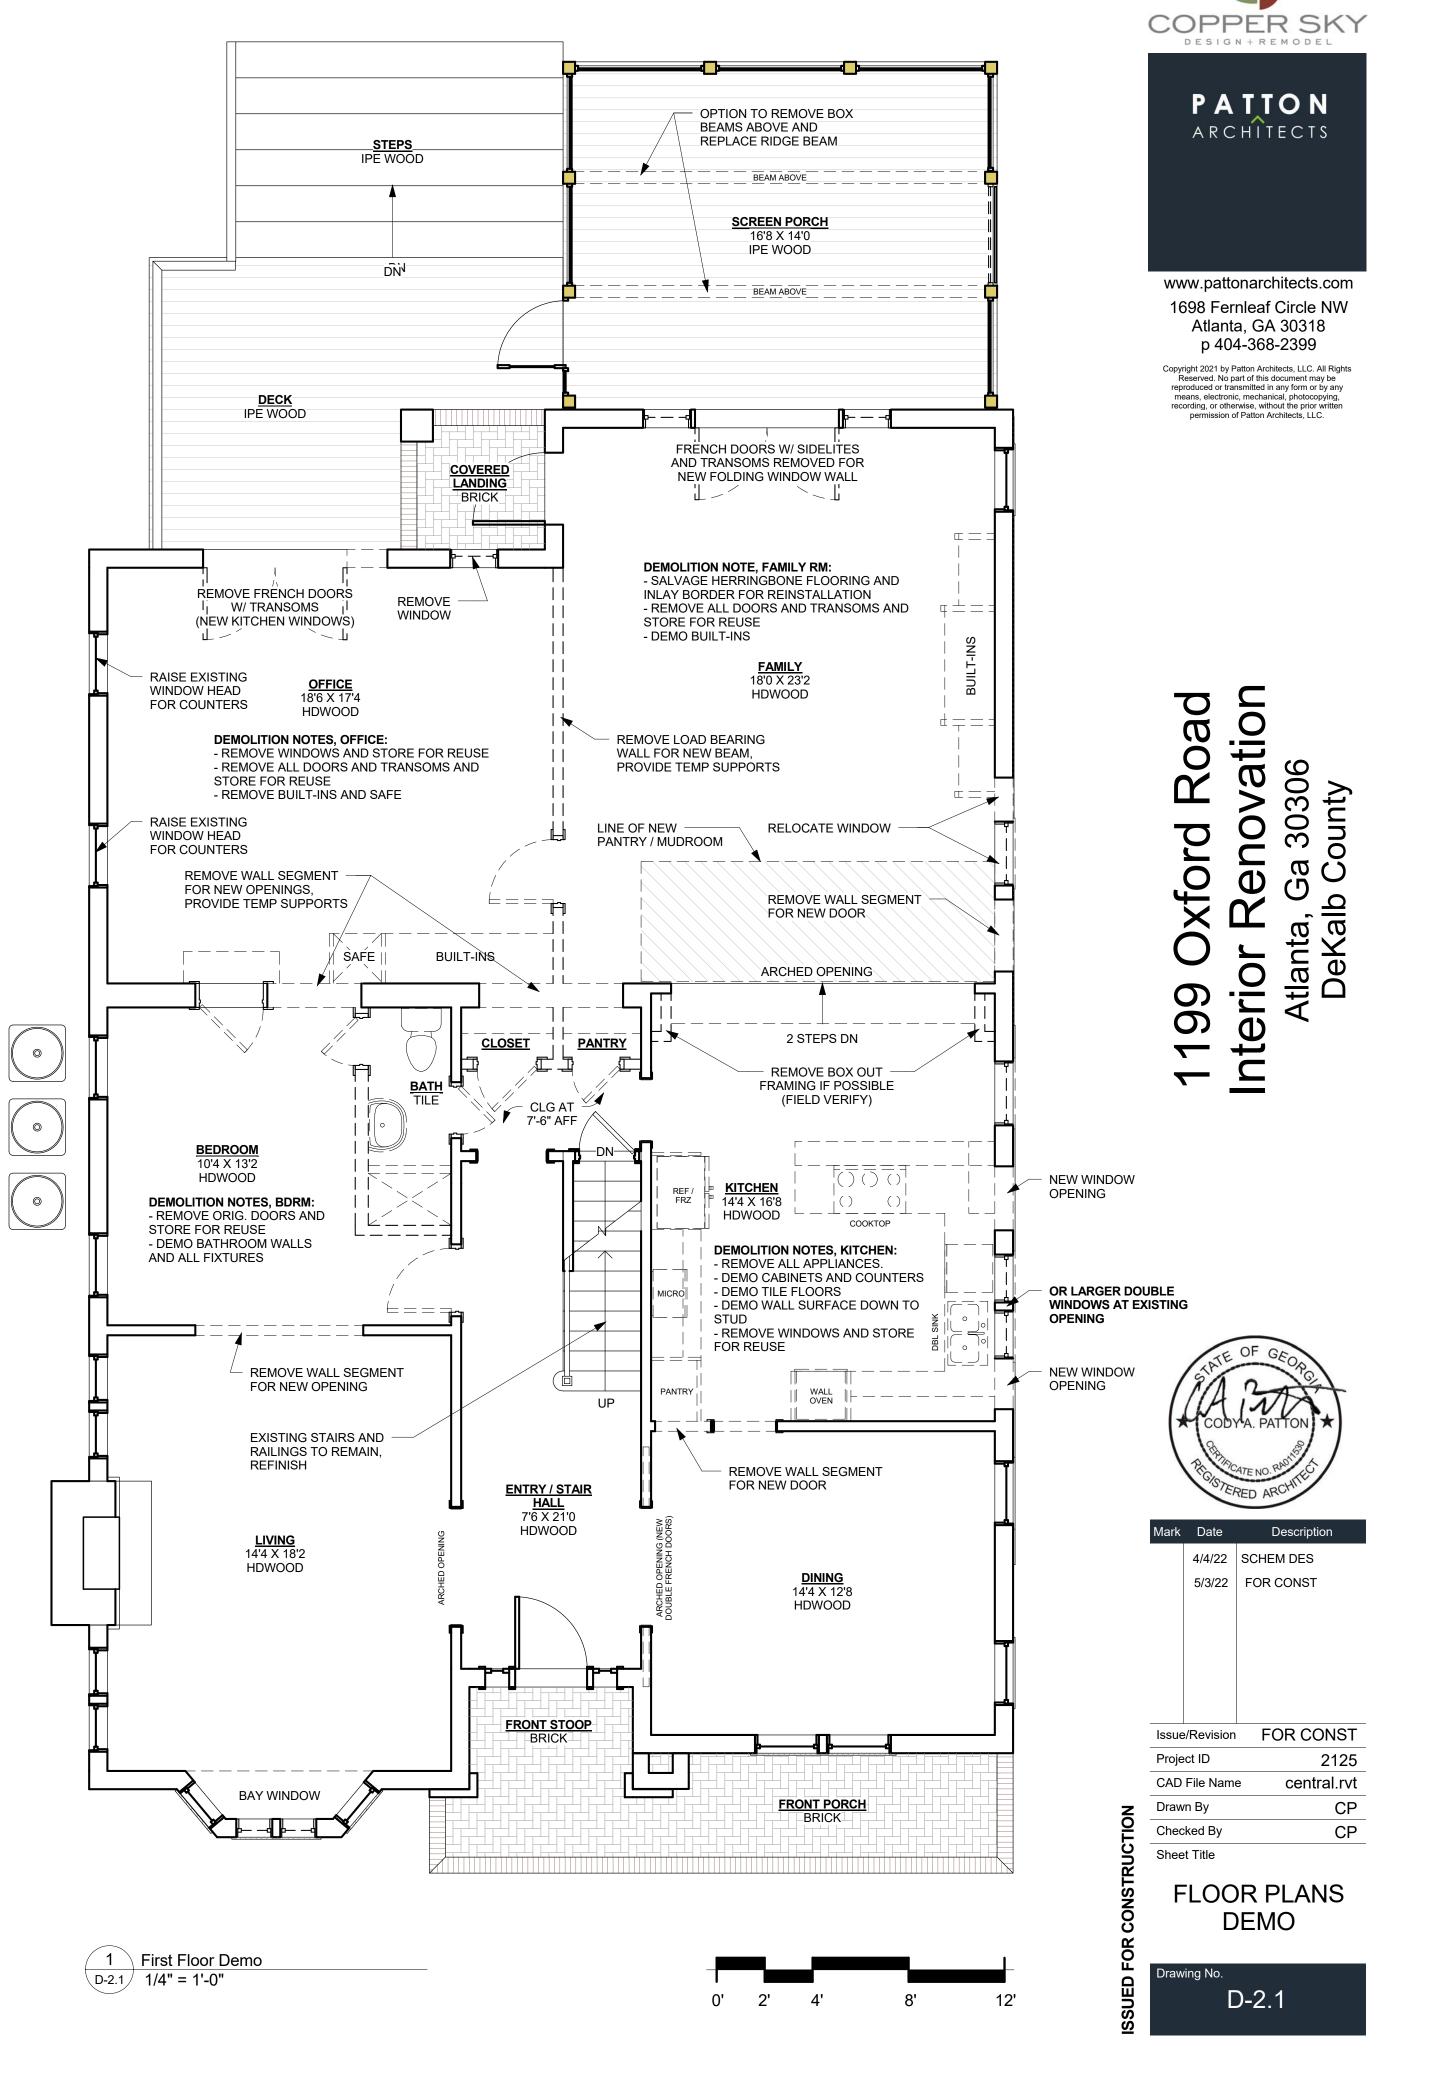
7. Protect from damage existing finish work that is to remain in place and becomes exposed during demolition

9. Maintain existing utilities indicated to remain. Keep in service and protect against damage during demolition

4. Repair adjacent construction or surfaces soiled or damaged by selective demolition work.

temporary services during interruptions to existing utilities, as acceptable to governing authorities.

remain using power-driven masonry saw or hand tools; do not use power-driven impact tools.



GENERAL NOTES

1) CONTRACTOR TO FIELD VERIFY ALL DIMENSIONS AND EXISTING CONDITIONS. NOTIFY OWNER OR ARCHITECT OF ANY

DISCREPANCIES OR UNFORSEEN CONDITIONS PRIOR TO ANY WORK. 2) ALL INTERIOR WALLS ARE P-1 U.N.O. 3) WALLS ARE DIMENSIONED FROM FACE OF FINISH UNLESS NOTED OTHERWISE. DOORS AND WINDOWS ARE DIMENSIONED FROM EDGE

4) ALL GYPSUM BOARD AT BATHROOM AREA AND KITCHEN SINK AREA TO BE WATER RESISTANT. PROVIDE CEMENT BOARD AT TILE

5) PROVIDE BLOCKING AT ALL BATHROOM ACCESSORIES, WALL CABINETS, AND SHELVING.

6) CENTER LIGHT FIXTURES ON DOORWAYS, IN ROOMS OR ABOVE PLUMBING FIXTURES WHERE APPLICABLE. 7) PROVIDE SWITCHES & ELECTRICAL OUTLETS PER RESIDENTIAL ÉLECTRICAL CODE. INSTALL AT 18" AFF OR AT 44" AFF AT COUNTERTOPS. PROVIDE GFCI OUTLETS AT WET AREAS AND EXTERIORS. COORD OUTLETS, DIMMER SWITCHES, CABLE, & DATA

8) PROVIDE ALLOWANCE AND INSTALL ALL APPLIANCES, PLUMBING, AND LIGHTING FIXTURES AS SELECTED BY OWNER. 9) NEW INTERIOR DOORS TO BE SOLID CORE WOOD TO MATCH EXISTING OR AS SELECTED BY OWNER. PROVIDE HARDWARE AND

10) ALL INTERIOR TRIM (BASE, CROWN, DOOR AND WINDOW TRIM) TO MATCH ORIGINAL / EXISTING, PAINT. 11) REPLACE EXISTING FURNACE, CONDENSER UNIT AND DUCTWORK

AS REQUIRED. VERIFY MODEL AND SIZING WITH OWNER & MECH CONTRACTOR. MIN SEER 14. 12) COORDINATE ALL PLUMBING AND HVAC ROUTING IN FIELD,

VÉRIFY WITH OWNER. 13) PROVIDE BATT OR SPRAY INSULATION AT NEW EXTERIOR WALLS AND CEILINGS (MIN R-13 WALL, R-38 CEILINGS, R-19 FLOORS OVER

GERNERAL SCOPE NOTES

UNCONDITIONED SPACE)

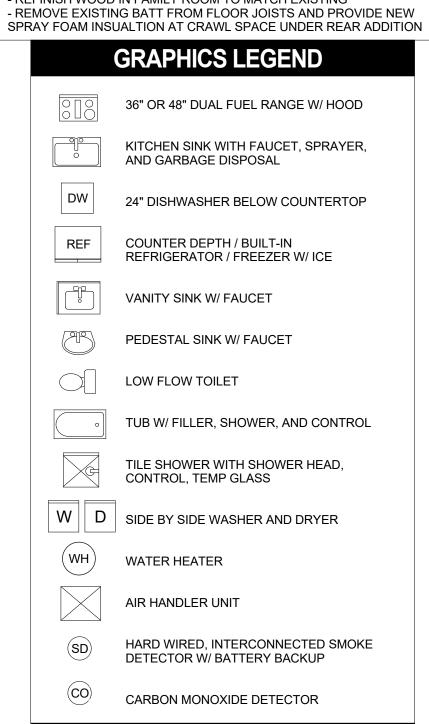
LOCKSETS AS SELECTED BY OWNER.

- REPLACE CROWN MOLDING IN SPACES THAT DO NOT HAVE ORIGINAL PROFILE (TO MATCH ORIGINAL CROWN W/ PICTURE RAIL) - SAND & PAINT OR REPLACE BASE, CROWN, & CASINGS THAT ARE

DAMAGED - SAND & PAINT / REFINISH DOORS THAT ARE UNFINISHED OR

DAMAGED - CLEAN OR REPLACE DOOR HARDWARE & HINGES THAT ARE PAINTED OVER (MATCH ORIGINAL) - REPAIR PLASTER OR GYP WALLS WHERE DAMAGED / WORN

- REMOVE EXISTING TILE IN KITCHEN, REPLACE WITH NEW HARDWOOD - REFINISH WOOD IN FAMILY ROOM TO MATCH EXISTING



FINISH SCHEDULE				
ROOM	FLOOR	CEILING	WALL	
BEDROOMS	HARDWD	GYP, PAINT	GYP, PAINT	
BATHS	TILE	GYP, PAINT	GYP, PAINT	
CLOSETS	MATCH ROOM	GYP, PAINT	GYP, PAINT	
KITCHEN	HARDWD	GYP, PAINT	GYP, PAINT	
AMLY	HARDWD	GYP, PAINT	GYP, PAINT	
OFFICE	HARDWD	GYP, PAINT	GYP, PAINT	
_AUNDRY	WD OR TILE	GYP, PAINT	GYP, PAINT	
POWDER	HARDWD	GYP, PAINT	GYP, PAINT	

PARTITION TYPE LEGEND

NEW WALL PARTITION

2X4 WD STUD AT 16" O.C.

W/ 1/2" GYP EA SIDE


EXISTING WALL


DEMO WALL

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P-1

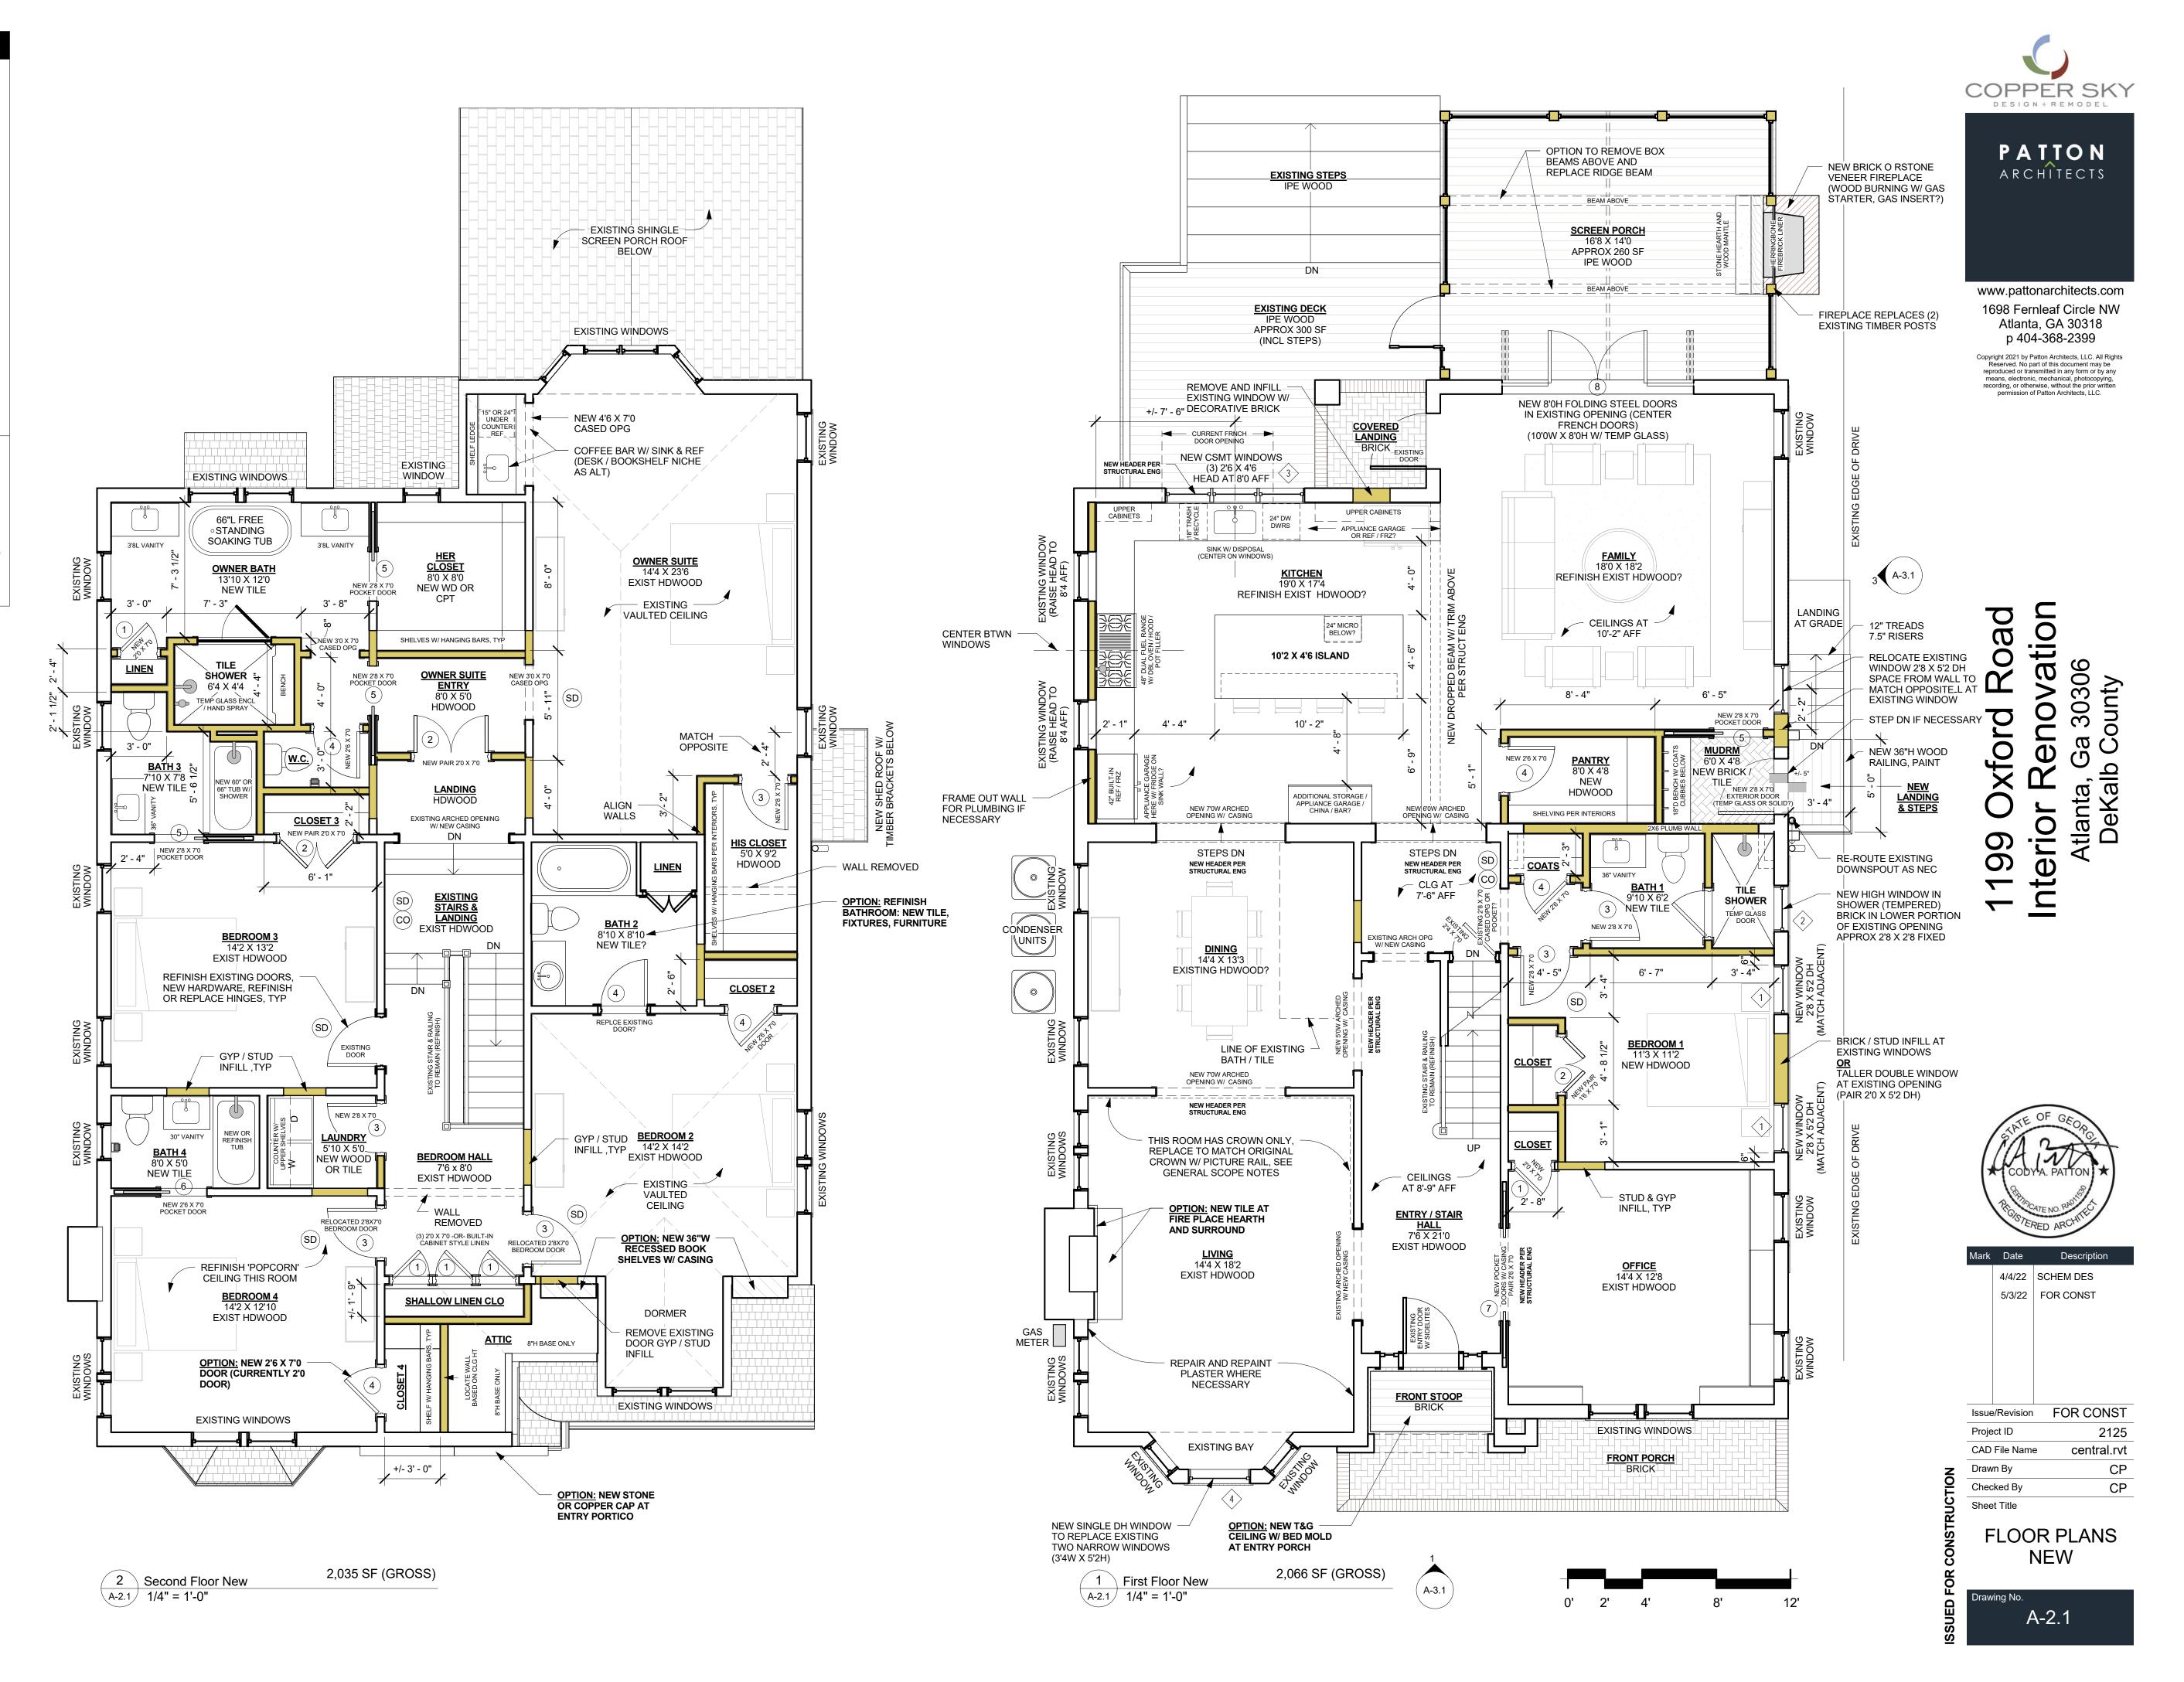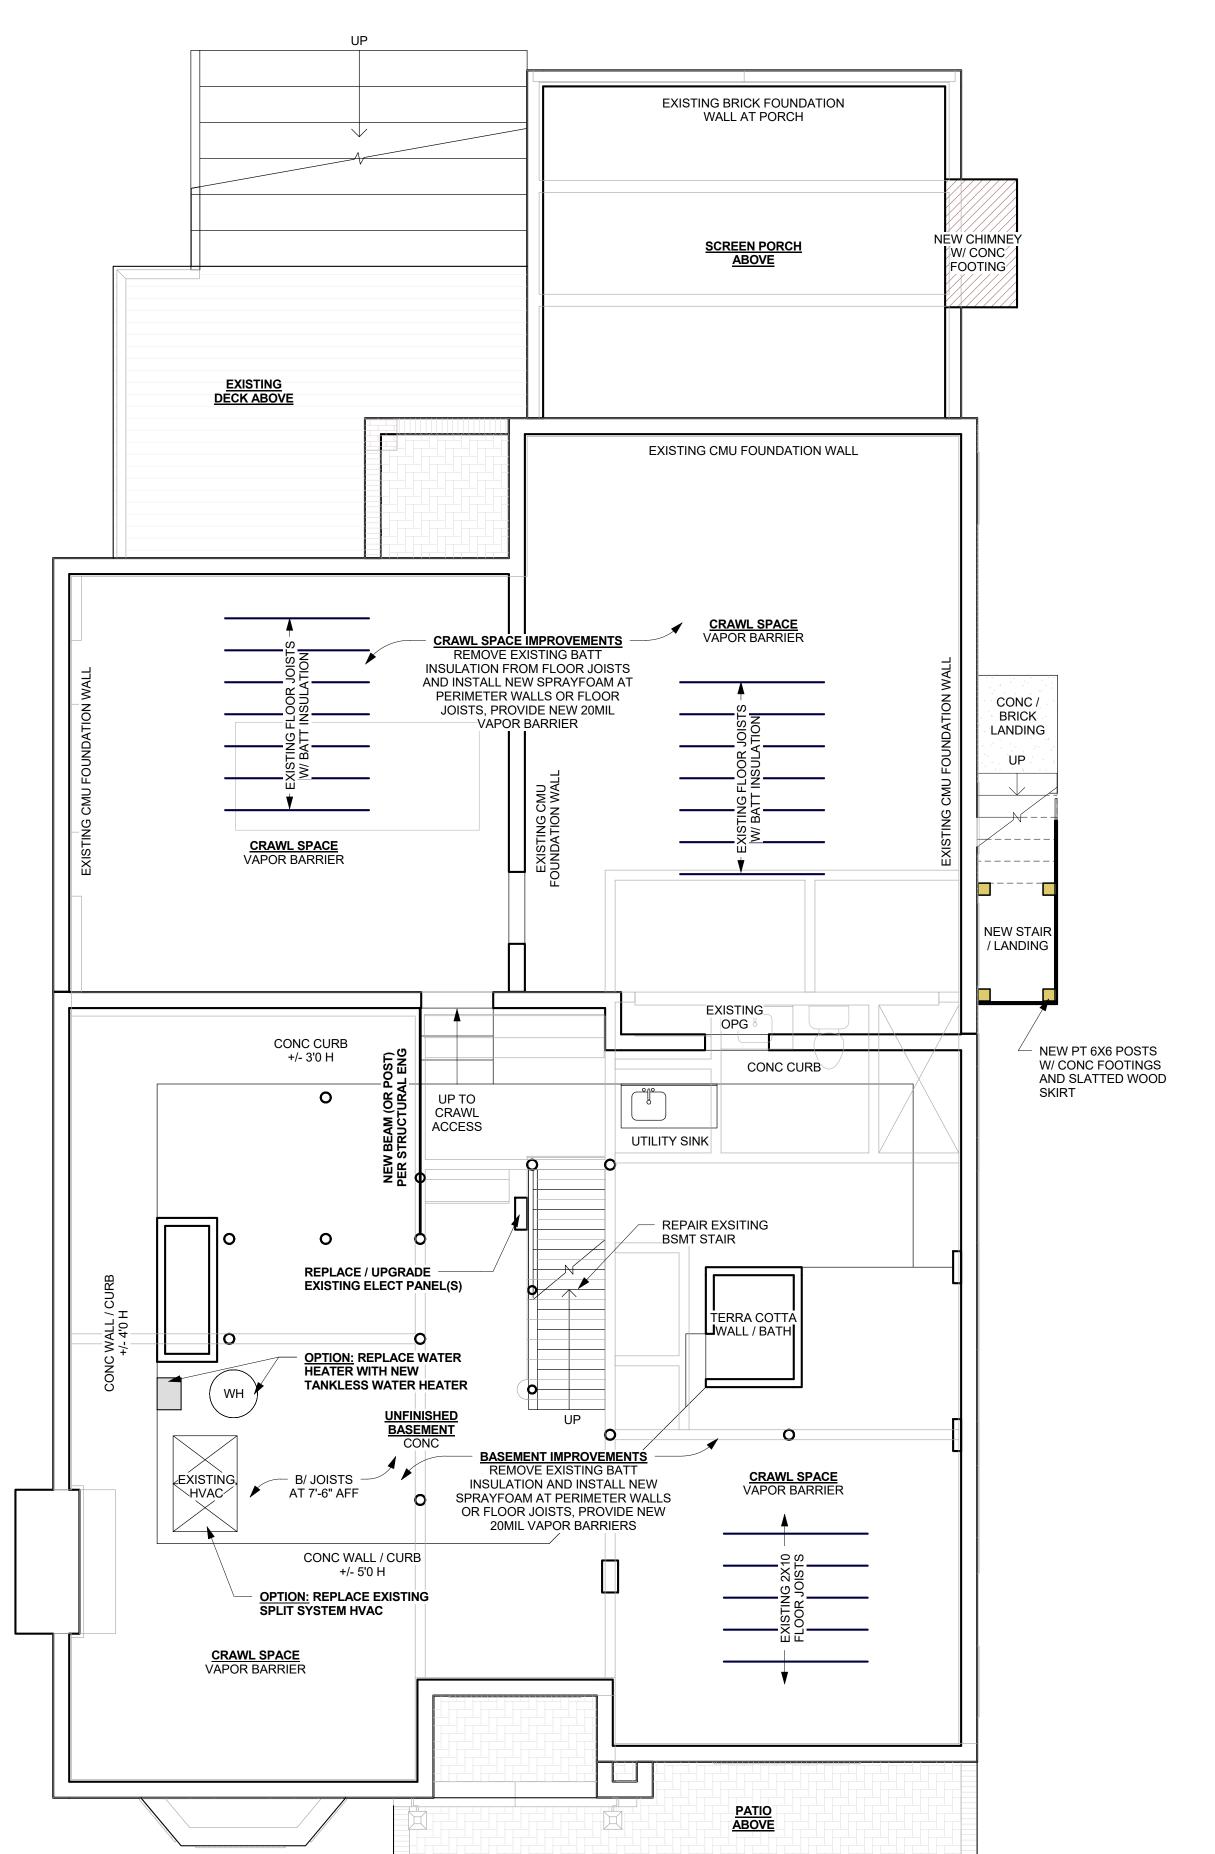FINISH NOTES: 1) INSTALL AND FINISH ALL WOOD FLRS TO MATCH EXISTING 2) VERIFY CEILING, WALL, AND TRIM PAINT COLORS WITH OWNER. REPLACE ALL POPOCORN CEILINGS. 3) NEW KITCHEN, LAUNDRY, & BATHROOM COUNTERTOPS TO BE STONE OR QUARTZ AS SELECTED BY OWNER. INSTALL BACKSPLASH AS SELECTED BY OWNER. 4) PROVIDE ALLOWANCE FOR ALL CABINET AND DOOR HARDWARE TO BE SELECTED BY OWNER. 5) PROVIDE ALLOWANCE FOR WIRE OR WOOD CUSTOM SHELVING IN CLOSETS, VERIFY W/ OWNER. 6) PROVIDE ALLOWANCE FOR CABINETRY IN BATHS. KICTHEN, LAUNDRY, BARS, & BUILT-INS. 7) TILE SURROUNDS TO CEILING AT TUBS AND SHOWERS. PROVIDE RECESSED SOAP NICHES AT TUBS & SHOWERS. 8) PROVIDE MIN 6" BASE, 4" CROWN, AND 4" CASING IN NEW SPACES. PROFILES TO MATCH EXISTING / SELECT BY INTERIORS.








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4/4/22 SCHEM DES 5/3/22 FOR CONST

	Issue/Revision		FOR CONS
	Proje	ct ID	21:
Z	CAD	File Name	e central.r
	Drawn By		C
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Checked By

Sheet Title FLOOR PLANS

2 Basement New A-2.2 1/4" = 1'-0"

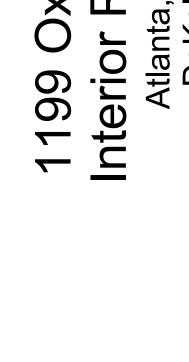DOOR SCHEDULE

1) DOOR PANEL STYLE, HARDWARE, AND FINISH TO MATCH EXISTING OR AS SELECTED BY OWNER. 2) TEMPER ALL GLASS IN OPERABLE DOORS

WINDOW SCHEDULE

2'8 X 5'2 DH

2'8 X 2'8 FIXED

2'6 X 4'6 CSMT

MARK TYPE QUANTITY SIZE

WINDOW NOTES:

ORIGINAL HOUSE.

DOOR OPENINGS.

4 A 2 3'4 X 5'2 DH

TYPE A WOOD (OR MTL CLAD) DOUBLE HUNG - 6 OVER 1
TYPE B FIXED WOOD (OR METAL CLAD) - 6 LITE TO MATCH

WINDOW NOTES

1) ALIGN HEADS OF NEW WINDOWS WITH EXISTING.
2) ALL WINDOWS TO BE WOOD OR METAL CLAD WOOD, SIMULATED DIVIDED

3) EXTERIOR TRIM, SILLS, AND MOLDING TO MATCH EXISTING, PAINT.

4) PROVIDE STANDARD WINDOW HARDWARE.

LITE W/ CLEAR INSULATED GLAZING AND 7/8" MULLIONS OR EQUAL TO MATCH

5) PROVIDE SELF ADHEREING FLASHING AT PERIMETER OF ALL WINDOW AND

6) WINDOWS SIZES ARE NOMINAL SIZES, REFER TO MANUFACTURER FOR ACTUAL SIZES AND ROUGH OPENINGS.
7) PROVIDE MIN OF ONE EMERGENCY EGRESS WINDOW PER BEDROOM

(MARKED WITH 'E'). (CLR HT 24", CLR WIDTH 20", MAX SILL HT 44", 5 SF CLR OPG FOR GROUND FLOOR, 5.7 SF CLR OPG FOR OTHER FLOORS)

8) PROVIDE TEMPERED SAFETY GLAZING IN OPERABLE PANELS, WITHIN 24" OF DOORS, AND WHERE 60" OR LESS ABOVE A WET AREA, OR 36" OR LESS

ABOVE A STAIR, LANDING, OR RAMP. NOTED 'T' ON ELEVATIONS.

EXISTING TOP SASHES

TYPE C WOOD (OR MTL CLAD) CASEMENT - 2 X 3 LITE

TYPE A SOLID WOOD, PANELED, PAINT TYPE B PAIR SOLID WOOD, PANELED, PAINT TYPE C SOLID WOOD PANELED - POCKET

TYPE D STEEL, 2X4 LITES

5 2'0 X 7'0

3 2'0 X 7'0 PAIR

4 2'8 X 7'0 POCKET

1 2'6 X 7'0 POCKET

6 2'6 X 7'0

6 2'8 X 7'0 (2 RELOCATED)

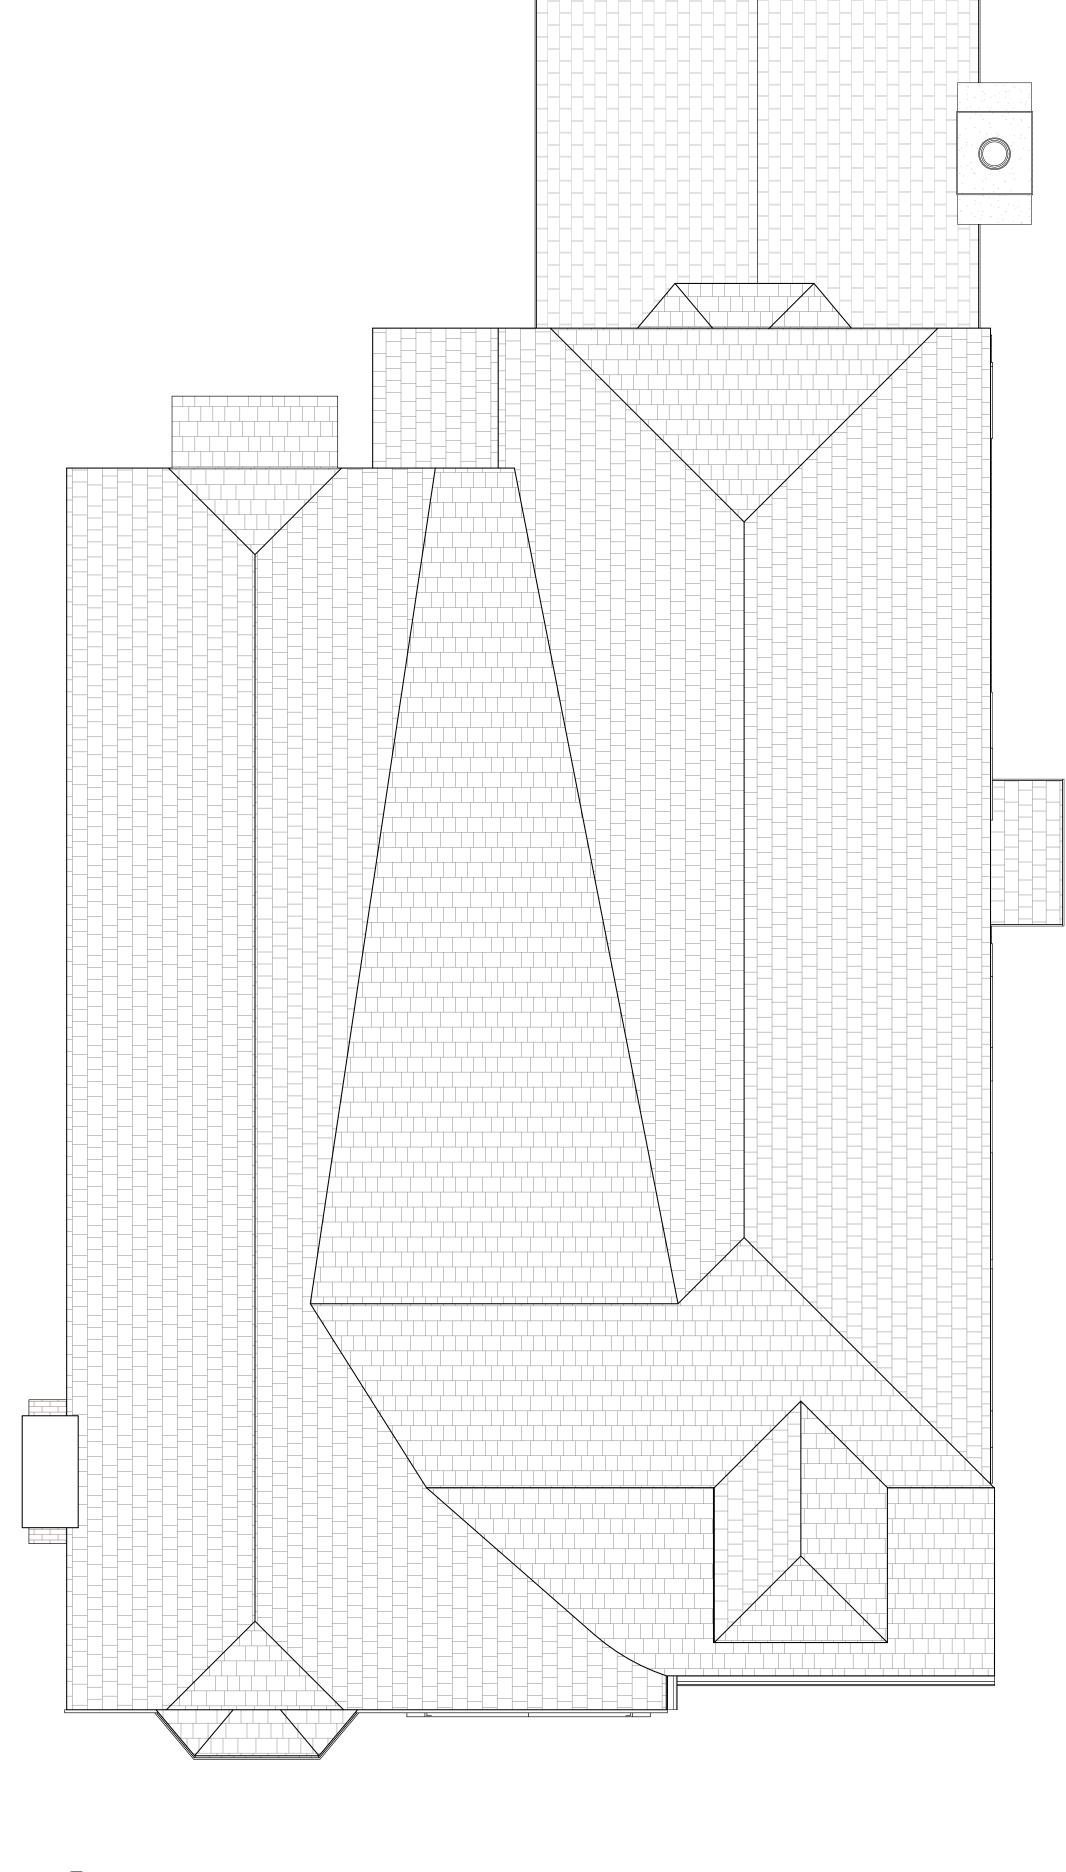
1 2'6 X 7'0 POCKET PAIR (GLASS?)

1 4 PANEL FOLDING STEEL

MARK TYPE QUANTITY SIZE

8

DOOR NOTES:



1 Roof Plan New

A-2.2 1/4" = 1'-0"



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Oxford Road r Renovation Ita, Ga 30306

terior Atlanta

EXTERIOR NOTES

WINDOW NOTES

1) ALIGN HEADS OF NEW WINDOWS WITH EXISTING.
2) ALL WINDOWS TO BE WOOD OR METAL CLAD WOOD, SIMULATED DIVIDED LITE W/ CLEAR INSULATED GLAZING AND 7/8" MULLIONS OR EQUAL TO MATCH

5) PROVIDE SELF ADHEREING FLASHING AT PERIMETER OF ALL WINDOW AND

6) WINDOWS SIZES ARE NOMINAL SIZES, REFER TO MANUFACTURER FOR ACTUAL SIZES AND ROUGH OPENINGS.7) PROVIDE MIN OF ONE EMERGENCY EGRESS WINDOW PER BEDROOM

(MARKED WITH 'E'). (CLR HT 24", CLR WIDTH 20", MAX SILL HT 44", 5 SF CLR

8) PROVIDE TEMPERED SAFETY GLAZING IN OPERABLE PANELS, WITHIN 24" OF DOORS, AND WHERE 60" OR LESS ABOVE A WET AREA, OR 36" OR LESS

OPG FOR GROUND FLOOR, 5.7 SF CLR OPG FOR OTHER FLOORS)

ABOVE A STAIR, LANDING, OR RAMP. NOTED 'T' ON ELEVATIONS.

3) EXTERIOR TRIM, SILLS, AND MOLDING TO MATCH EXISTING, PAINT.

4) PROVIDE STANDARD WINDOW HARDWARE.

ORIGINAL HOUSE.

DOOR OPENINGS.

1) EXTERIOR WALL SHEATHING TO BE 7/16" ZIPSYSTEM BY HUBER W/ FULLY TAPED SEAMS. STANDARD EXTERIOR SHEATHING W/ BUILDING PAPER AS ALTERNATE.

2) EXTERIOR ROOF SHEATHING TO BE 1/2" ZIPSYSTEM BY HUBER W/ FULLY TAPED SEAMS. STANDARD EXTERIOR GRADE DECKING W/ ROOF FELT AS ALTERNATE.

3) BRICK VENEER/FOUNDATIONS TO MATCH EXISTING TEXTURE. PAINT OR STUCCO ALL BRICK TO MATCH EXISTING

4) LAP SIDING TO BE CEDAR, JAMES HARDIE ARTISAN, OR NICHIHA SAVANNAH SMOOTH FINISH. EXPOSURE AS NOTED. PAINT OR STAIN. PROVIDE MATCHING TRIM AS NOTED.

5) CEDAR SHINGLE TO BE CEADAR OR JAMES HARDIE SMOOTH FINISH. PAINT OR STAIN.

6) MAIN ROOFING TO BE ARCHITECTURAL SLATE, COLOR AS SELECTED BY OWNER TO MATCH EXISTING.

7) METAL ROOFING TO BE COPPER OR PREFINISHED METAL STANDING SEAM W/ 12" MAX RIB SPACING, COLOR AS SELECTED BY OWNER.

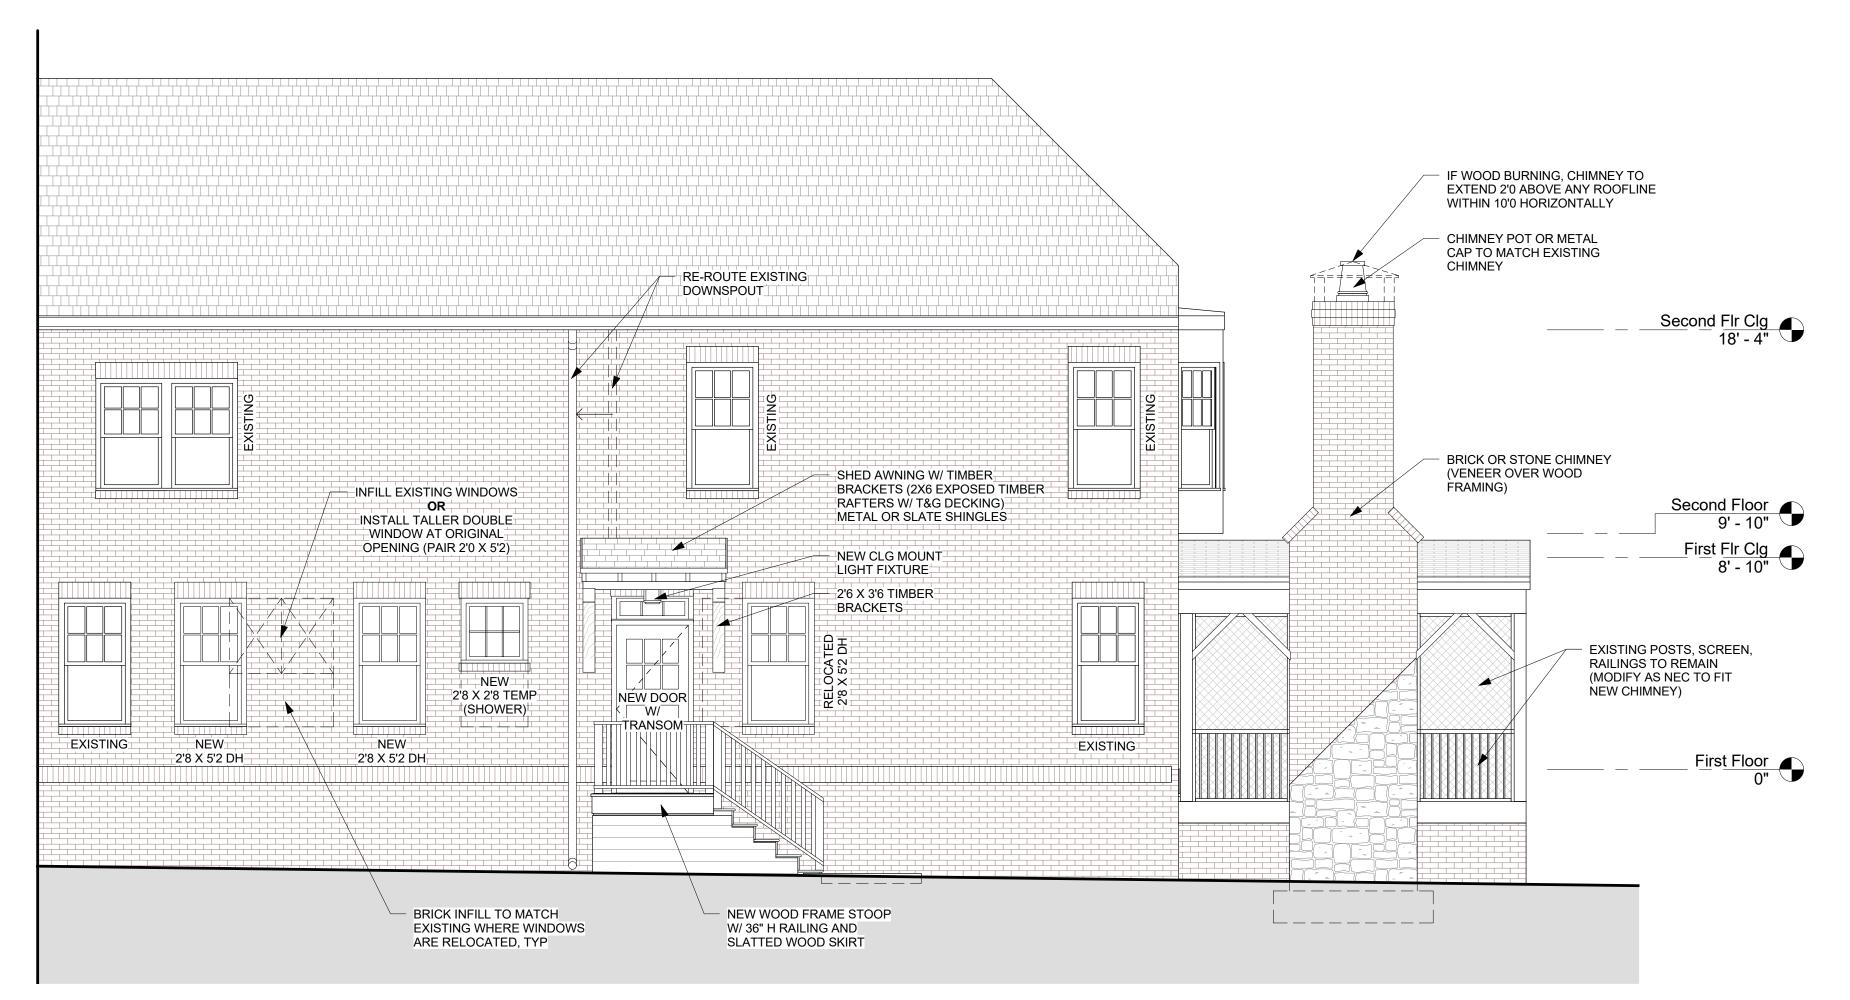
Second Fir Clg
9:10*

First Flog
8:10*

NEW SINGLE WINDOW TO REPLACE
EASY IN IN PARCY DE DOUBLE HUNC
9:10*

PAR SYCH

1 Front Elevation New A-3.1 1/4" = 1'-0"



3 Right Elevation New 1/4" = 1'-0"



Mark Date Description

4/4/22 SCHEM DES

5/3/22 FOR CONST

Issue/Revision FOR CONST
Project ID 2125
CAD File Name central.rvt
Drawn By CP

Drawn By
Checked By
Sheet Title

EXTERIOR ELEVATIONS

CP

Drawing No.
A-3.1

GENERAL NOTES

1) CONTRACTOR TO FIELD VERIFY ALL DIMENSIONS AND **EXISTING CONDITIONS. NOTIFY OWNER OR ARCHITECT OF** ANY DISCREPANCIES OR UNFORSEEN CONDITIONS PRIOR TO ANY WORK.

2) ALL INTERIOR WALLS ARE P-1 UNLESS OTHERWISE

3) WALLS ARE DIMENSIONED FROM FACE OF FINISH UNLESS NOTED OTHERWISE. DOORS AND WINDOWS ARE DIMENSIONED FROM EDGE OF OPENING. 4) ALL GYPSUM BOARD AT BATHROOM AREA AND

KITCHEN SINK AREA TO BE WATER RESISTANT. PROVIDE CEMENT BOARD AT TILE LOCATIONS. 5) PROVIDE BLOCKING AT ALL BATHROOM ACCESSORIES,

WALL CABINETS, AND SHELVING. 6) CENTER LIGHT FIXTURES ON DOORWAYS, IN ROOMS OR ABOVE PLUMBING FIXTURES WHERE APPLICABLE. 7) PROVIDE SWITCHES & ELECTRICAL OUTLETS PER

RESIDENTIAL ELECTRICAL CODE. INSTALL AT 18" AFF OR AT 44" AFF AT COUNTERTOPS. PROVIDE GFCI OUTLETS AT WET AREAS AND EXTERIORS. COORD OUTLETS, DIMMER SWITCHES, CABLE, & DATA W/ OWNER. 8) PROVIDE ALLOWANCE AND INSTALL ALL APPLIANCES,

PLUMBING, AND LIGHTING FIXTURES AS SELECTED BY 9) NEW INTERIOR DOORS TO BE SOLID CORE WOOD TO MATCH EXISTING OR AS SELECTED BY OWNER. PROVIDE

HARDWARE AND LOCKSETS AS SELECTED BY OWNER. **10)** ALL INTERIOR TRIM (BASE, CROWN, DOOR AND WINDOW TRIM) TO MATCH EXISTING, PAINT. 11) REPLACE EXISTING FURNACE, CONDENSER UNIT AND DUCTWORK AS REQUIRED. VERIFY MODEL AND SIZING WITH OWNER & MECH CONTRACTOR. MIN SEER 14. 12) COORDINATE ALL PLUMBING AND HVAC ROUTING IN

EXTERIOR WALLS AND CEILINGS (MIN R-13 WALL, R-38 CEILINGS, R-19 FLOORS OVER UNCONDITIONED SPACE)

GRAPHICS LEGEND

13) PROVIDE BATT OR SPRAY INSULATION AT NEW



FIÉLD, VERIFY WITH OWNER.

36" RANGE W/ HOOD



KITCHEN SINK WITH FAUCET, SPRAYER, AND GARBAGE DISPOSAL

24" DISHWASHER BELOW COUNTERTOP



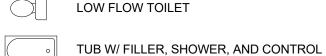
COUNTER DEPTH / BUILT-IN REFRIGERATOR / FREEZER W/ ICE



VANITY SINK W/ FAUCET



PEDESTAL SINK W/ FAUCET





TILE SHOWER WITH SHOWER HEAD AND CONTROL



 $\mid W \mid \mid D \mid$ SIDE BY SIDE WASHER AND DRYER



WATER HEATER



AIR HANDLER UNIT

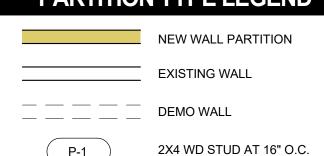


P-1



CARBON MONOXIDE DETECTOR


PARTITION TYPE LEGEND



W/ 1/2" GYP EA SIDE

FINISH SCHEDULE			
ROOM	FLOOR	CEILING	WALL
BEDROOMS	HARDWD	GYP, PAINT	GYP, PAIN
BATHS	TILE	GYP, PAINT	GYP, PAIN
CLOSETS	MATCH ROOM	GYP, PAINT	GYP, PAIN
KITCHEN	HARDWD	GYP, PAINT	GYP, PAIN
FAMLY	HARDWD	GYP, PAINT	GYP, PAIN
OFFICE	HARDWD	GYP, PAINT	GYP, PAIN
LAUNDRY	WD OR TILE	GYP, PAINT	GYP, PAIN
POWDER	HARDWD	GYP, PAINT	GYP, PAIN

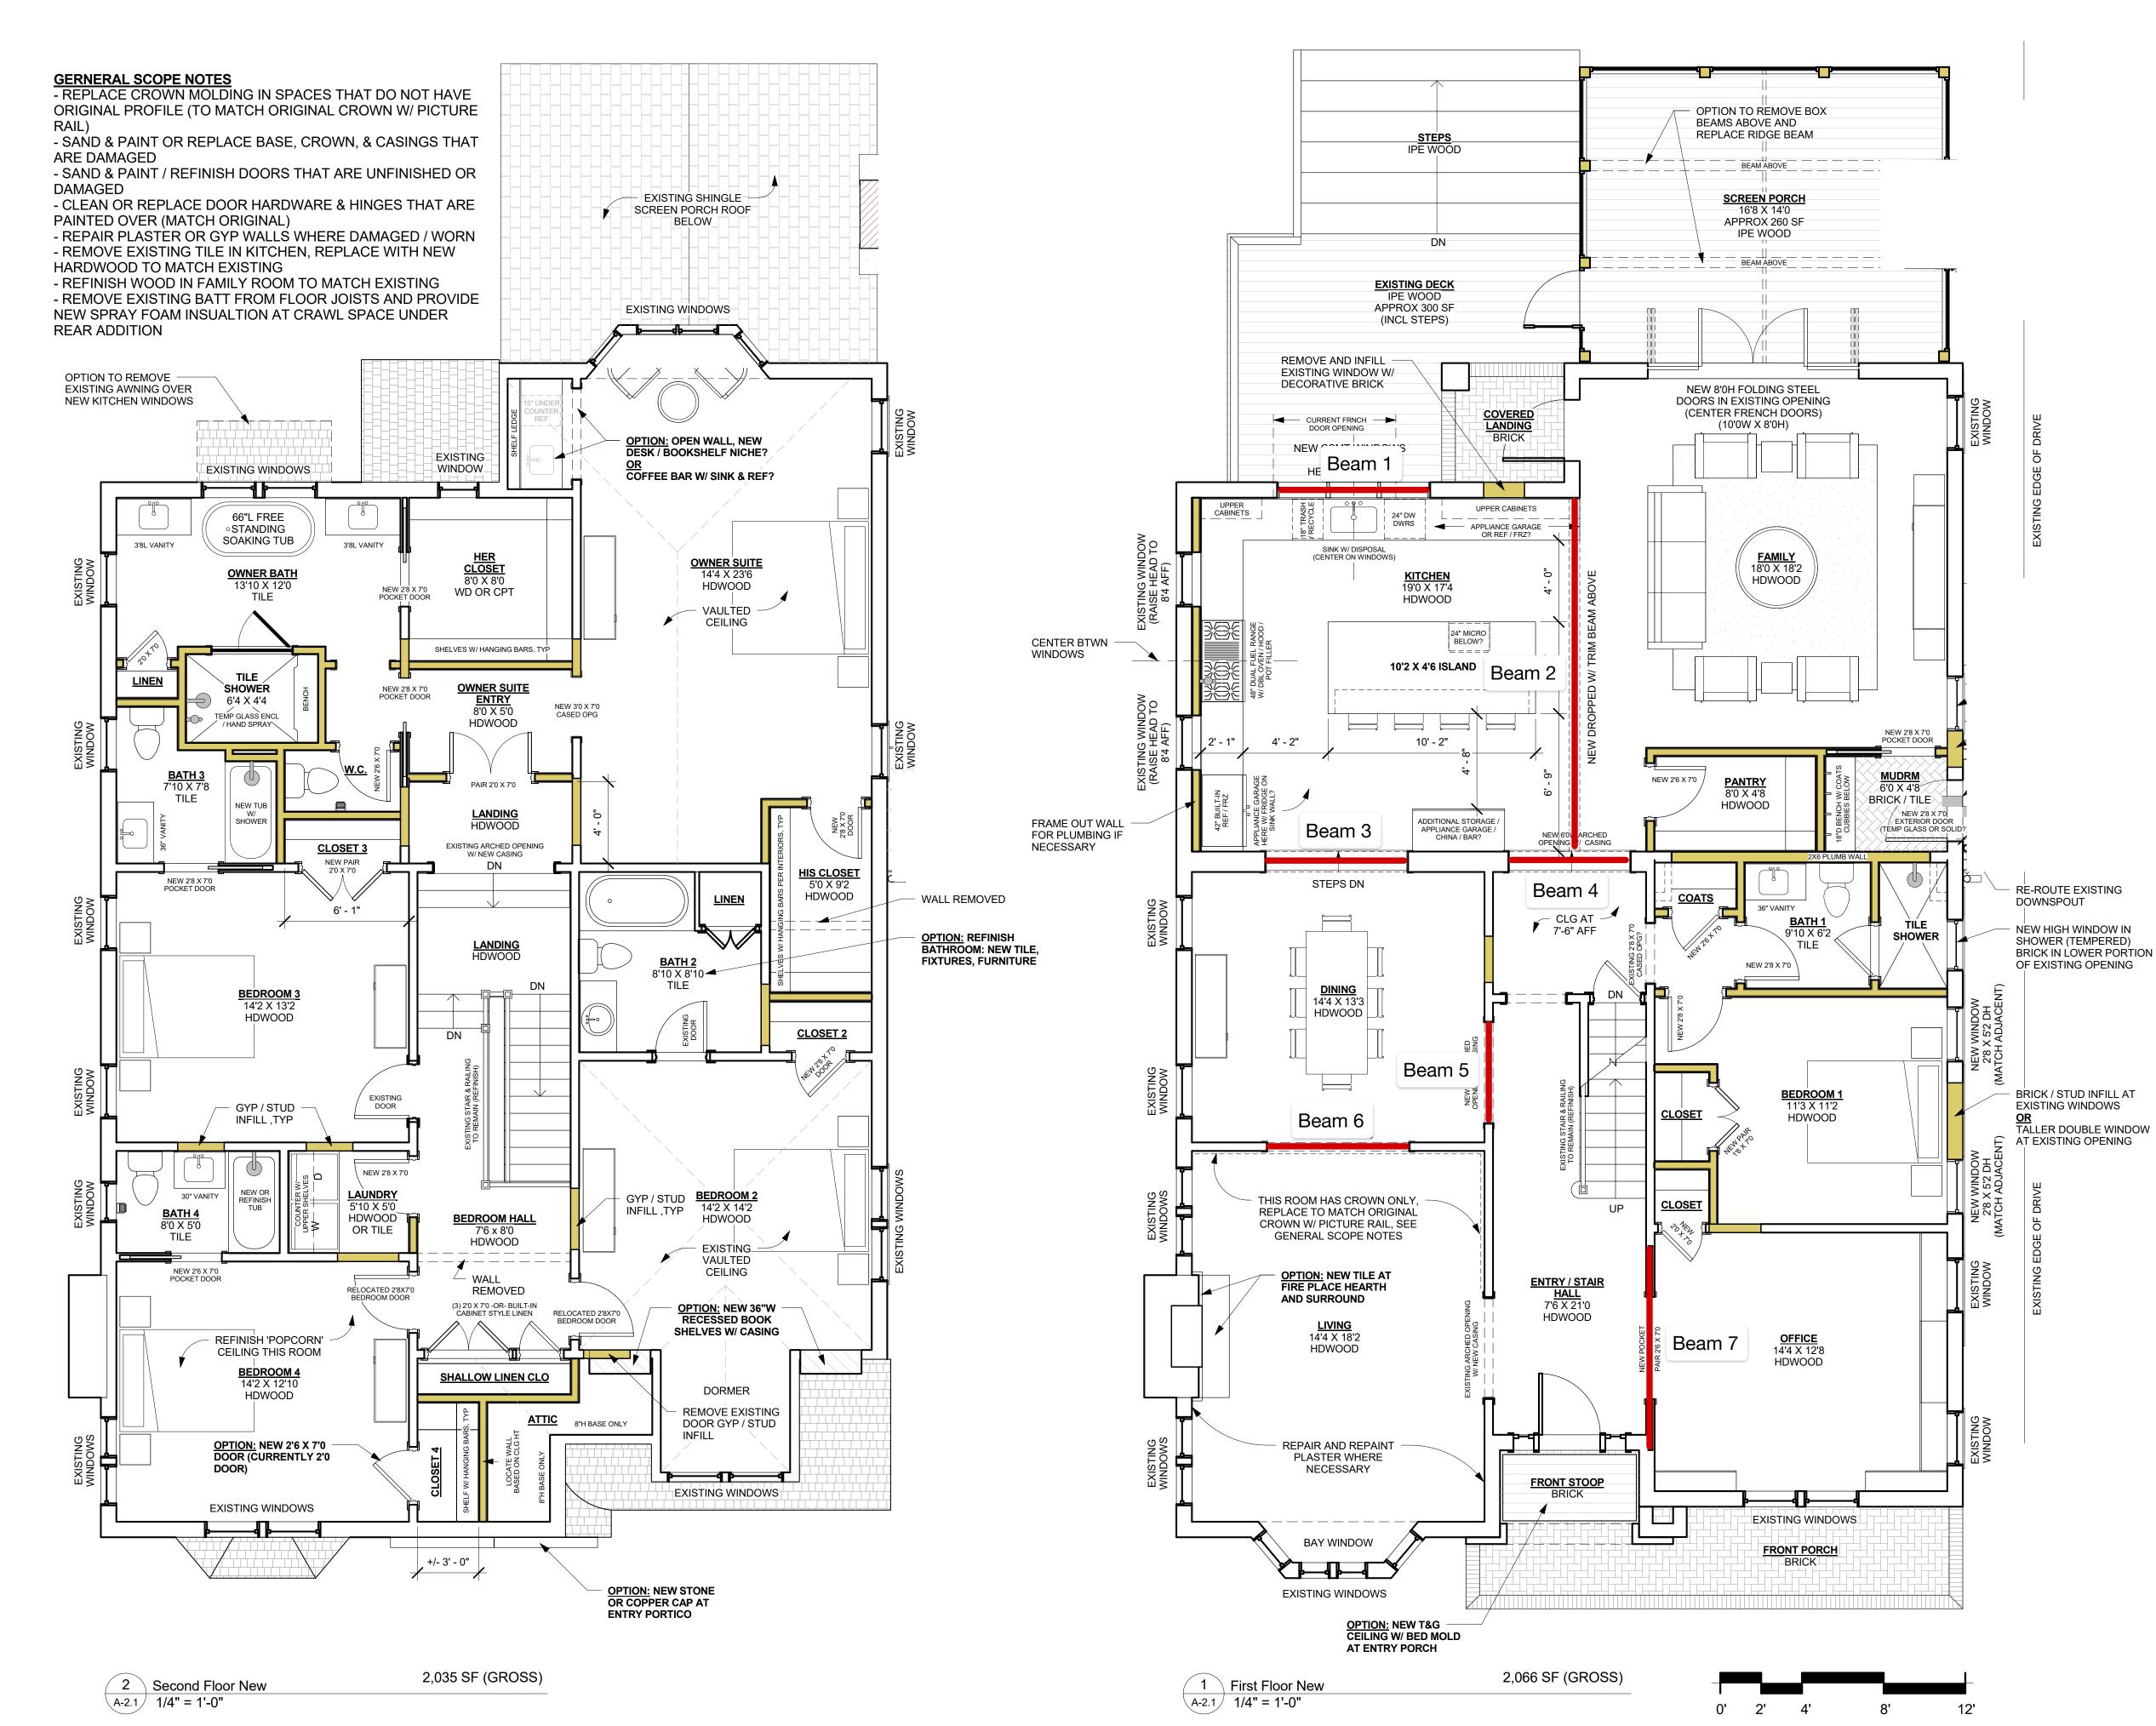FINISH NOTES: 1) INSTALL AND FINISH ALL WOOD FLRS TO MATCH EXISTING. 2) VERIFY CEILING, WALL, AND TRIM PAINT COLORS WITH OWNER. REPLACE ALL POPOCORN CEILINGS. 3) NEW KITCHEN, LAUNDRY, & BATHROOM COUNTERTOPS TO BE STONE OR QUARTZ AS SELECTED BY OWNER. INSTALL BACKSPLASH AS SELECTED BY OWNER. 4) PROVIDE ALLOWANCE FOR ALL CABINET AND DOOR HARDWARE TO BE SELECTED BY OWNER. 5) PROVIDE ALLOWANCE FOR WIRE OR WOOD CUSTOM SHELVING IN CLOSETS, VERIFY W/ OWNER. 6) PROVIDE ALLOWANCE FOR CABINETRY IN BATHS, KICTHEN, LAUNDRY, BARS, & BUILT-INS. 7) TILE SURROUNDS TO CEILING AT TUBS AND SHOWERS. PROVIDE RECESSED SOAP NICHES AT TUBS & SHOWERS. 8) PROVIDE MIN 5 1/2" BASE, 4" CROWN, AND 4" CASING IN NEW SPACES. PROFILES TO MATCH EXISTING / SELECT BY



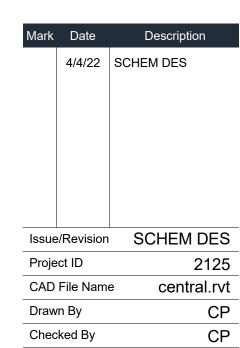




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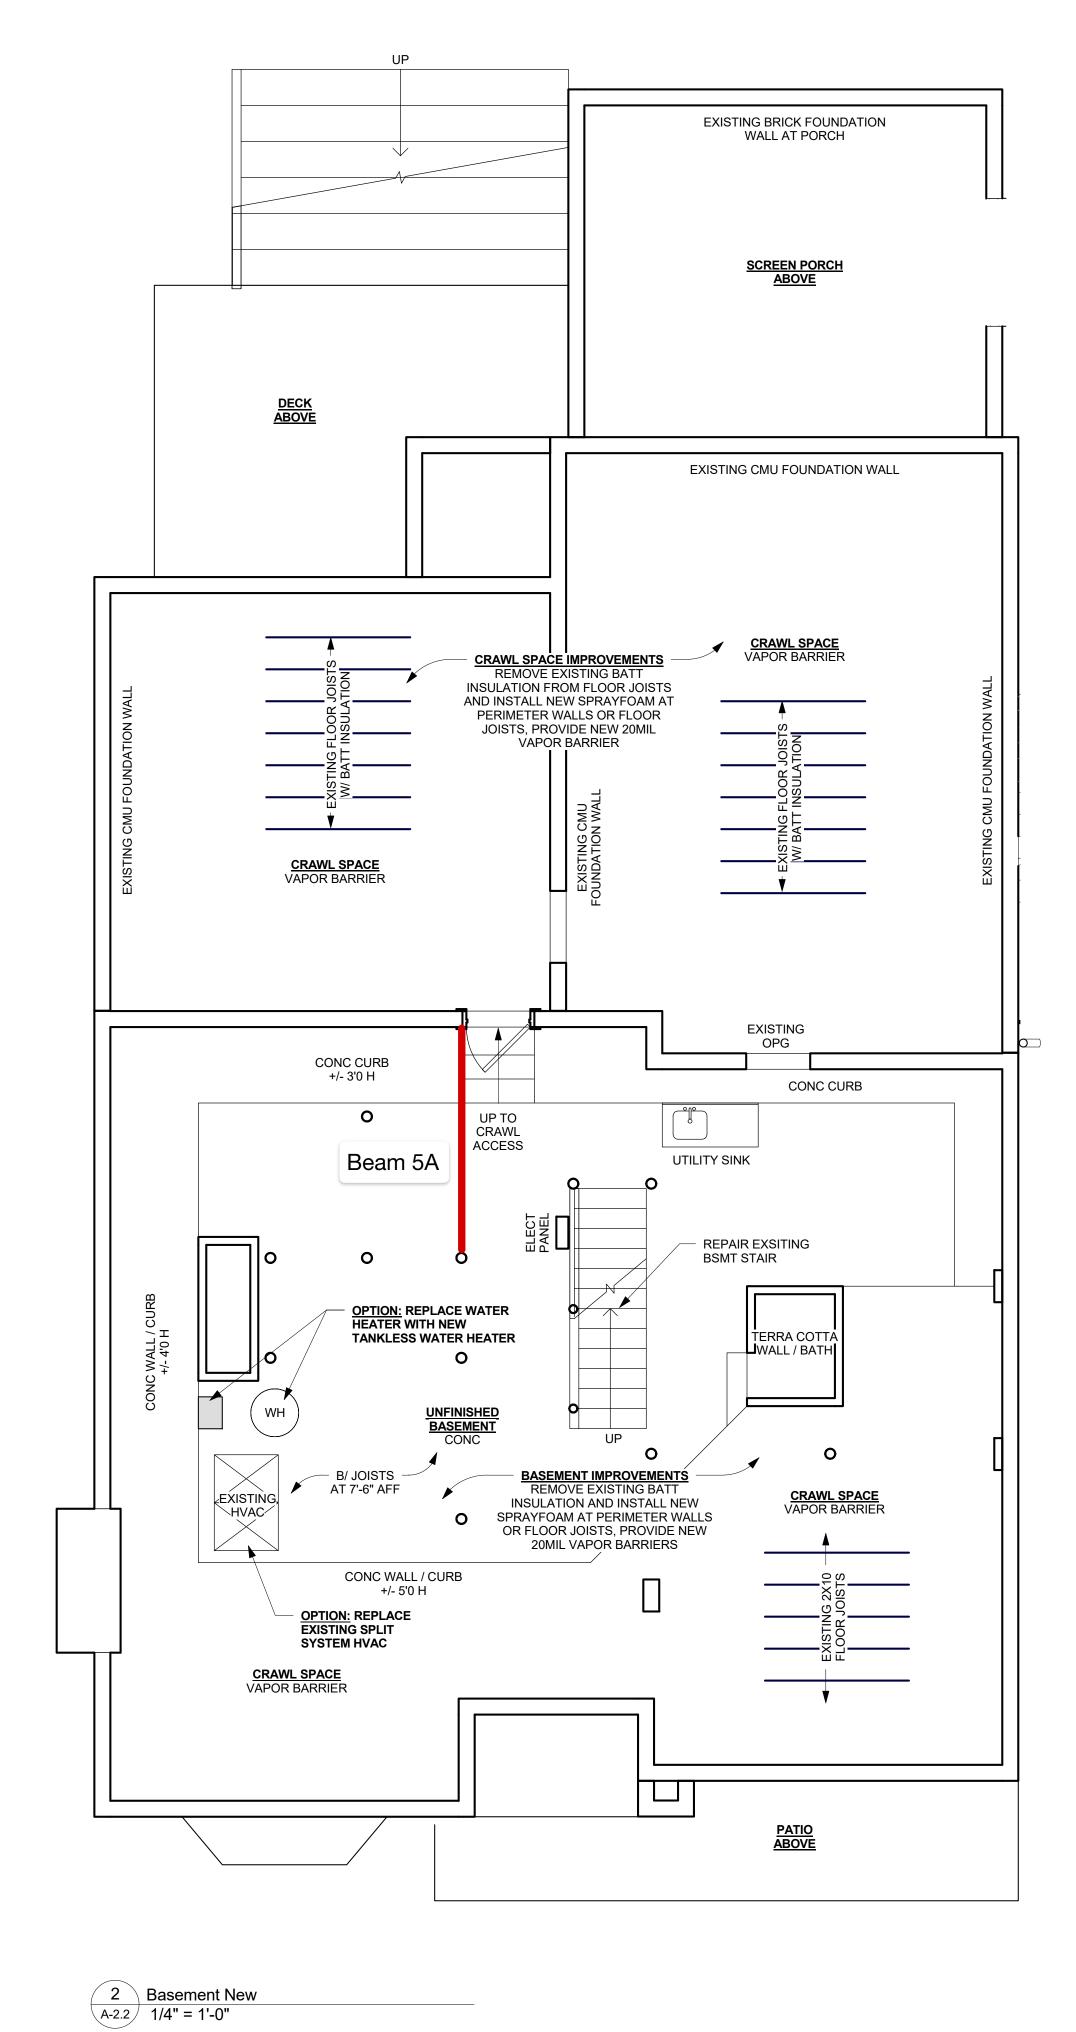
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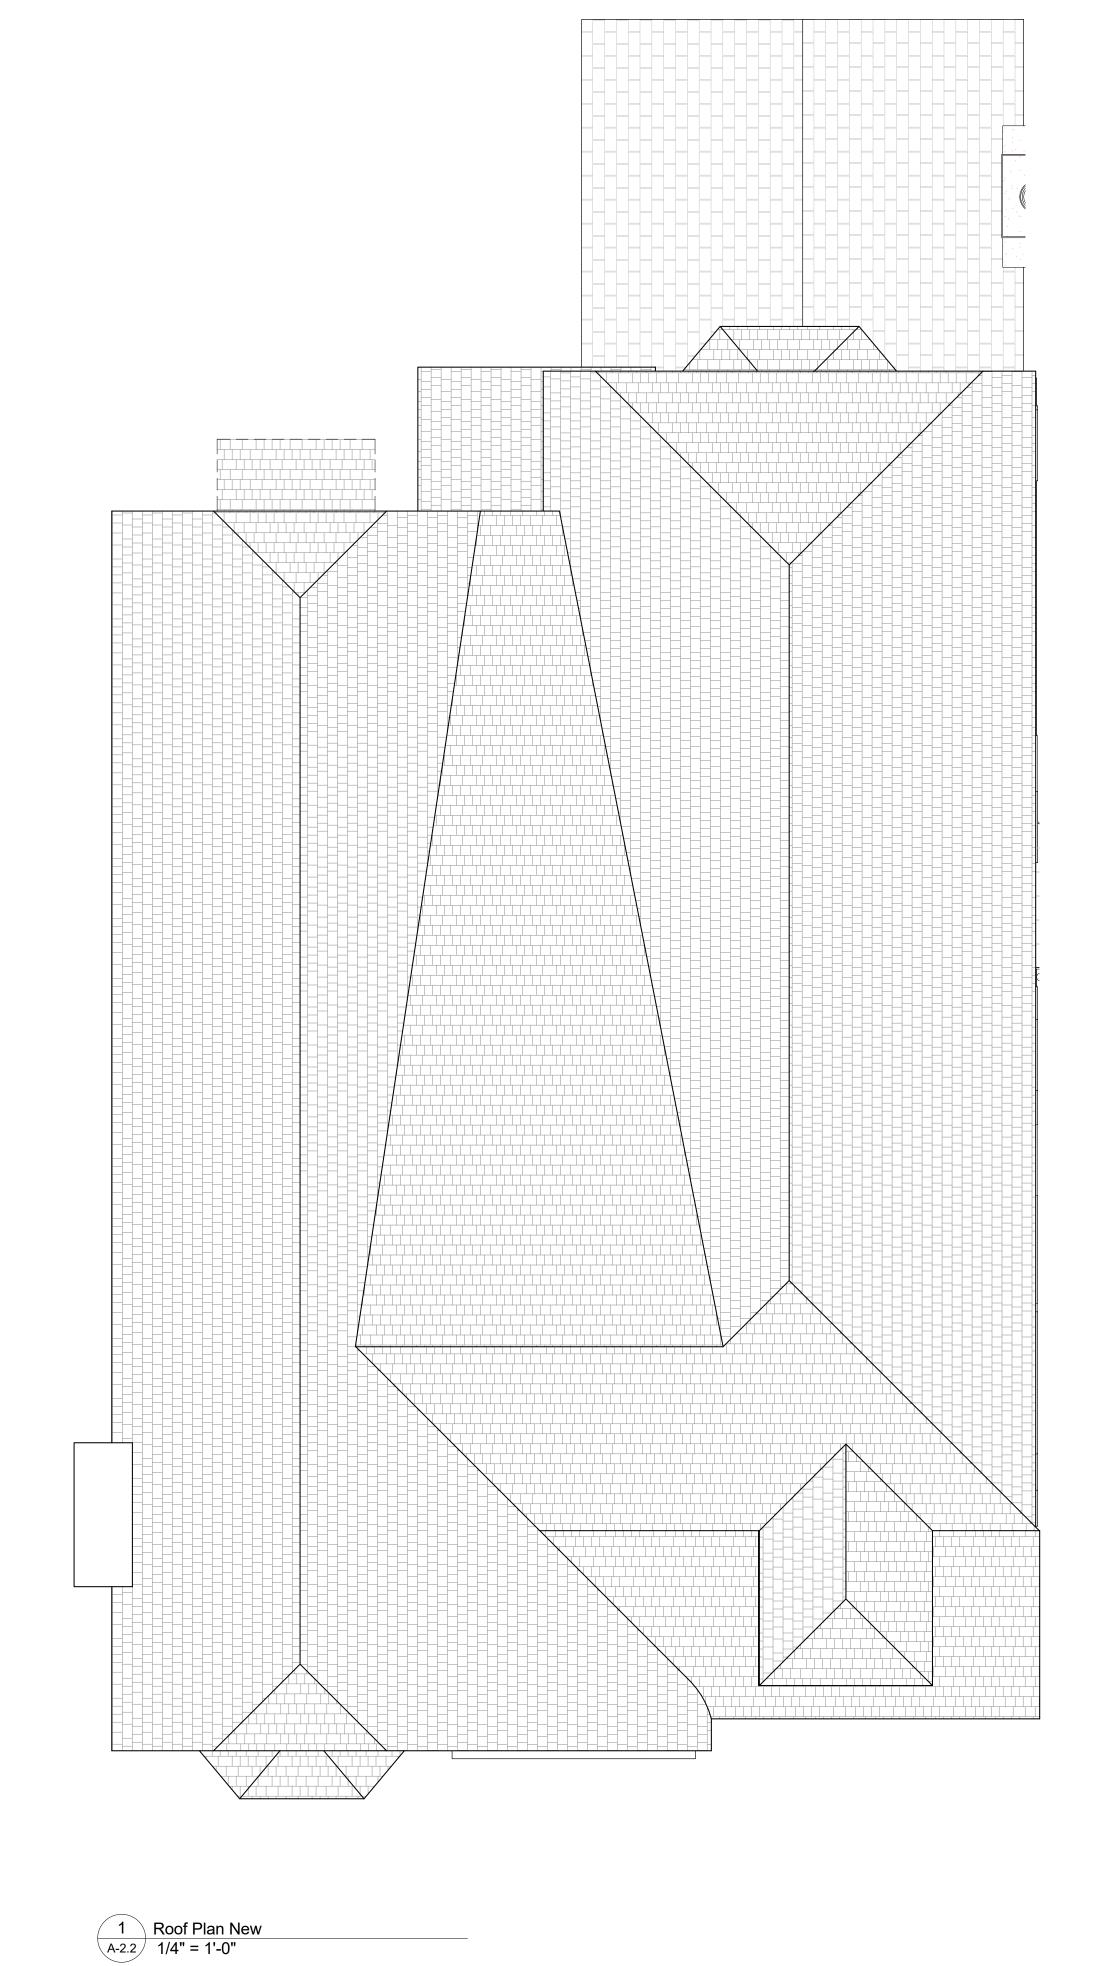


STRUCTURAL BEAM SKETCH



Sheet Title








COPPER SKY

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STRUCTURAL BEAM SKETCH

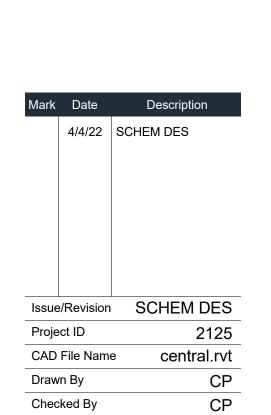