

Chief Executive Officer

### DEPARTMENT OF PLANNING & SUSTAINABILITY

Director

Michael Thurmond

Andrew A. Baker, AICP

Application	tor	Certificate	Of	Appropriateness

Date Received:	Application No.:	
	1556 N. Decatur Road, Atlanta, C	
	rector Real Estate-SW - sweetgreen	E-Mail: benjamin.bass@sweetgreen.com
Applicant: Dell bass / Di	rector near Estate-SW - sweetgreen	E-Mail: Derijariiii.bass@sweetgreen.com
Applicant Mailing Address:	3101 Exposition Boulevard, Los Ar	ngeles, CA 90018
Applicant Phone(s): 214-8	350-8504	Fax:
	bryan.ruesch@jsdinc.com, 224-545-8	712
Applicant's relationship to the	e owner: Owner  Architect:  Contractor/	Builder □ Other 図 Tenant
	**********	
Owner(s): Emory Villag	e, LLC	E-Mail:
-	1000 Deschare Chroat NE Cuito 9	
Owner(s) Mailing Address: _	1230 Peachtree Street, NE, Suite 8	00, Atlanta, GA 30309-3574
project: 60 years  Nature of work (check all that New construction Der New accessory building Sign installation or replacem Description of Work:  Tenant improvement	construction of the primary structure on the pro  at apply):  nolition □ Addition □ Moving a building  Landscaping □ Fence/Wall □ Other  ent ☑ Other □  work for a new sweetgreen restaut	perty and any secondary structures affected by this  Other building changes  er environmental changes  rant. Scope of work includes new exterior
painting and signage	on south and west walls, new store	efront, new fabric canopy over patio area,
	atio perimeter, new wheat paste po	ster series "mural" on the west and interior
remodeling.		
samples, photographs, etc.	All documents should be in PDF format ication and supporting material to pla	porting documents, such as plans, list of materials, color , except for photographs, which may be in JPEG ansustain@dekalbcountyga.gov An incomplete
		Ban Bass 05/27/22 Signature of Applicant/Date Revised 10/5/2020



### Authorization of a Second Party to Apply for a Certificate of Appropriateness

This form is required if the individual making the request is **not** the owner of the property.

I/ We,Jan H. Saperstein				
being owner(s) of the property at $\frac{1}{2}$	556 North Decatur Re	oad, Atlanta, G	iA 30307	
hereby delegate authority to Ben I	Bass, sweetgreen			
to file an application for a certificate	of appropriateness in	my/our behalf.		
			2	

Signature of Owner(s)

Data

### Please review the following information

Approval of this Certificate of Appropriateness does not release the recipient from compliance with all other pertinent county, state, and federal regulations.

Before making any changes to your approved plans, contact the preservation planner (404/371- 2155). Some changes may fall within the scope of the existing approval, but others will require review by the preservation commission. If work is performed which is not in accordance with your certificate, a Stop Work Order may be issued.

If your project requires that the county issue a Certificate of Occupancy at the end of construction, an inspection may be made to verify that the work has been completed in accord with the Certificate of Appropriateness. If the work as completed is not the same as that approved in the Certificate of Appropriateness you will not receive a Certificate of Occupancy. You may also be subject to other penalties including fines and/or required demolition of the non-conforming work.

If you do not commence construction within twelve months of the date of approval, your Certificate of Appropriateness will become void and you will need to apply for a new certificate if you still intend to do the work.



### **DEKALB COUNTY HISTORIC PRESERVATION COMMISSION (HPC)**

2021 Calendar (Revised 06/14/2021)

Certificate of Appropriateness (COA) Applications will only be accepted during the two-week application period seen below.

Applications Accepted	Application Deadline	Sign Must Be Posted	HPC Meeting Date	Last Date to File Appeal (approximate)
June 14	June 25	July 9	July 19	August 3
July 12	July 23	August 6	August 16	August 31
August 16	August 27	September 10	September 20	October 5
September 13	September 24	October 8	October 18	November 2
October 11	October 22	November 5	November 15	November 30
November 8	November 19	December 3	December 13	December 28

All meetings will be held on the third Monday of the month except for December. The HPC meets via Zoom at 6:00 pm. Click <u>HERE</u> for the most recent agenda and applications.

This calendar is subject to change. Revisions will be shown in red. The most recent calendar can be obtained from the Department of Planning and Sustainability web site or call the department at 404/371-2158.



### **How to Obtain a Certificate of Appropriateness**

- 1. Contact the DeKalb County Department of Planning and Sustainability for an application form. You may pick this up at the DeKalb County Department of Planning and Sustainability, 330 West Ponce de Leon Avenue, Third Floor, in Decatur, or you may make your request by mail, telephone (404) 371-2247, or fax (404) 371-2813, or visit the website at <a href="https://www.dekalbcountyga.gov/planning-and-sustainability/forms">https://www.dekalbcountyga.gov/planning-and-sustainability/forms</a>
- 2. Complete and submit the application. Please provide as much supporting material as possible, (plans, material, color samples, photos, etc.). All documents must be in PDF format except for photographs, which may be in JPEG format. Email the application and supporting documents to <a href="mailto:plansustain@dekalbcountyga.gov">plansustain@dekalbcountyga.gov</a>. If all documents are not provided the application will not be complete and will not be accepted.
- 3. The Preservation Planner will post a sign on the property at least ten days before the preservation commission meeting.
- 4. The Preservation Planner will visit the property as part of their review. The commission members may view the property from the right-of-way.
- 5. Applications will be reviewed by the DeKalb County Historic Preservation Commission at its monthly meeting. In most months, the Historic Preservation Commission meets on the third Monday at 7 p.m. at the Maloof Auditorium, 1300 Commerce Drive in Decatur. In unusual circumstances meeting dates and location may be changed.
- 6. The Historic Preservation Commission may approve, approve with modifications or deny an application. The applicant or any affected person as defined by county code may appeal the decision to the DeKalb County Board of Commissioners. Please contact the Department of Planning and Sustainability if you wish to file an appeal. The Historic Preservation Commission is required to make a decision on an application within 45 days of the date of filing, although this time can be extended if the applicant agrees to a deferral.
- 5. Although not required, applicants are encouraged to attend the Historic Preservation Commission meetings. Applicants may make a presentation, but presentations are not required. The commissioners may have questions for the applicant.
- 7. Approval of a Certificate of Appropriateness does not release the recipient from compliance with all other county, state and federal regulations.



### **Design Checklist for a Certificate of Appropriateness**

This checklist was created to help applicants prepare a complete application. Omissions and inaccurate information can lead to deferrals and/or denials of applications. Please review the checklist with the project's architect, designer, or builder. All items will not be applicable to all projects. New construction will involve all categories. One copy of drawings at scale (plus nine reduced sets) should be submitted. Please address questions regarding applicability to your project to the DeKalb County Preservation Planner at 404-371-2155, e-mail <a href="mailto:dccullis@dekalbcountyga.gov">dccullis@dekalbcountyga.gov</a>. Applicants are also referred to the DeKalb County website, <a href="http://www.dekalbcountyga.gov/planning-and-sustainability/planning-sustainability/planning-sustainability/planning-sustainability/planning-sustainability/planning-sustainability/planning-sustainability/planning-sustainability/planning-sustainability/planning-sustainability/planning-sustainability/planning-sustainability/planning-sustainability/planning-sustainability/planning-sustainability/planning-sustainability/planning-sustainability/planning-sustainability/planning-sustainability/planning-sustainability/planning-sustainability/planning-sustainability/planning-sustainability/planning-sustainability/planning-sustainability/planning-sustainability/planning-sustainability/planning-sustainability/planning-sustainability/planning-sustainability/planning-sustainability/planning-sustainability/planning-sustainability/planning-sustainability/planning-sustainability/planning-sustainability/planning-sustainability/planning-sustainability/planning-sustainability/planning-sustainability/planning-sustainability/planning-sustainability/planning-sustainability/planning-sustainability/planning-sustainability/planning-sustainability/planning-sustainability/planning-sustainability/planning-sustainability/planning-sustainability/sustainability/sustainability/sustainability/sustainability/sustainability/sustainability/sustainability/sustainab

I have reviewed the "Design Manual for the Druid Hills Local Historic District"	Υ	Ν
I have reviewed the DeKalb County Tree Ordinance	Υ	N
I have reviewed applicable zoning codes regarding lot coverage, garage sizes, strea	ım buff	ers
Y N		

### 1. General

- a. Label all drawings with the address of the site, owners' name, and contact phone number.
- b. Number all drawings.
- c. Include a graphic scale on reductions.
- d. Date all revisions.
- e. Indicate all unverified numbers with +/- signs
- e. Include photos of the existing condition of the property.

### 2. Site Plan (existing and proposed) to include

- a. Topographical plan with significant trees sized and located;
- b. Setback compared to adjacent houses (ask surveyor to show corners of adjacent houses);
- c. Distance between houses;
- d. Façade width to finished face of material;
- e. Grading and elevations across site;
- f. Dirt removal or regrading if more than 18";
- g. Tree protection plan;
- h. Tree removal and replacement plan

### 3. Driveways and Walkways

- a. Location and relationship to house;
- b. Width:
- c. Material;
- d. Curb cut and apron width



### 4. Fences & Retaining Walls

- a. Placement on lot:
- b. Height of fence or wall. If retaining wall, height on both sides;
- c. Material;
- d. Railing if necessary

### 5. Elevations and Floor Plans << Indicate all unverified numbers with +/- signs>>

- a. Plans for all floors (drawn to scale, 1/4"=1' preferred);
- b. House orientation on site plan;
- c. Scalable elevations for front, rear, left, right;
- d. Height, grade to ridge;
- e. Streetscape comparison showing heights of two flanking houses on each side;
- f. Height from grade to first floor level at all four corners;
- g. Height from grade or finished floor line to eaves at all four corners;
- h. Ceiling heights of each floor, indicating if rough or finished:
- i. Height of space between the ceiling and finished floor above;
- j. Two people of 5'-6" and 6' height shown;
- k. Landscaping plan

### 6. Additions

- a. Placement shown on elevations and floor plan;
- b. Visibility from rights-of-way and paths;
- c. Photos of all facades;
- d. Design proportioned to main house;
- e. Landscaping plan;
- f. Materials and their combinations

### 7. Roof Plan

- a. Shape and pitch of roof;
- b. Roofing material;
- c. Overhang:
- d. Louvers and vents:
- e. Chimney height and material

### 8. Dormers

- a. Construction details provided;
- b. Shape and size of dormer (show dimensions on drawings);
- c. Overhang:
- d. Size of window(s), with nominal size of sash (show dimensions on drawings)

### 9. Skylights

- a. Profile;
- b. Visibility from right-of-way;
- c. Material (plastic lens or glass);
- d. Shown in plan and elevation to scale



### 10. Façade

- a. Consistency in style;
- b. Materials and their combinations

brick size and color stone type and color fiber-cement (e.g. Hardieplank) or wood siding shake or shingle other

- c. Height of foundation at corners;
- d. Ceiling heights comparable to area of influence: basement, first floor, second floor;
- e. Detailing: soldier course, brackets, fascia board; water table;
- f. Height from grade to roof ridge;
- g. Dimensions, proportions and placement of windows, doors

### 11. Entrance

- a. Height and width of door;
- b. Design of door (e.g. 6-panel, craftsman);
- c. Material of door;
- d. Overhang;
- e. Portico height;
- f. Size and height of columns or posts;
- g. Railing

### 12. Windows

- a. Consistent with original as well as the area of influence;
- b. Size and proportion similar to original;
- c. Pane orientation and size similar to original;
- d. Type (e.g. double hung, casement);
- e. Fenestration on walls visible from right-of-way;
- f. Simulated divided light (SDL) or true divided light (TDL): location of muntins between the glass, behind the glass or permanently affixed on exterior;
- g. Material of window and any cladding;
- h. Width of muntins compared to original (show dimensions on drawings);
- i. Shutters or canopies
- j. Dimensions of windows and doors.

### 13. Materials

- a. Show all materials and label them on drawings;
- b. Provide samples of brick or stone;
- c. Provide samples if new or unusual materials



### 14. Garages / Accessory Buildings

- a. Visibility from street;
- b. Placement on site;
- c. Scale, style appropriate for house;
- d. Show dimensions on drawings;
- e. Materials;
- f. Square footage appropriate for lot size;
- g. Garage door size and design
- h. Show height from grade to eaves and to top of roof

### 15. Demolitions

- a. Provide documentation from engineer concerning feasibility of rehabilitation;
- b. Provide photographs of structure to be demolished;
- c. Provide plan for proposed redevelopment





1400 East Touhy Avenue, Suite 215 Des Plaines, IL 60018 312.644.3379

### **Project Description and Company Background** sweetgreen - Emory Village 1556 North Decatur Road, Atlanta, GA 05/27/2022

### The Site

Sweetgreen is proposing to lease a one-story building of approximately 1,813 square feet located at 1556 North Decatur Road, within the Emory Village commercial district. The building Landlord is Emory Village LLC, and the premises was formerly home to a Dragon Bowl restaurant.

The site is located within the C-1 Local Commercial zoning district, and also within the Emory Village Overlay District and the Druid Hills Historic District. We are making application for both Druid Hills Historic District and Emory Overlay District Certificate of Appropriateness.

### The Exterior

Sweetgreen is proposing to enhance and refresh the building exterior with their brand image. The intent is to paint the existing brick masonry walls on all sides with a white color. New "sweetgreen" signage composed of a rear box with double stroke neon is proposed for both the south building face above the entry, and on the west building face. The west building face is also including a wheat paste poster series mural below the new sign and extending about midway of the building length. A new aluminum storefront system with insulated glazing will replace the existing system on the south entry façade.

The existing patio area will also be revived. The existing front canopy structure at the patio area will remain, but will be covered in a new fabric with one of sweetgreen's brand colors. The existing patio barrier fence will be removed and replaced with a new powder coated white ornamental metal fence. New outdoor seating and additional fabric umbrellas (to match the canopy fabric) will be provided for additional shade, along with string lighting for evening patrons. New planters will be added to the east side of the patio to help conceal the existing adjacent property retaining wall, while also adding live greenery to the space.

### The Interior

As a brand, sweetgreen creates experiences which start with their restaurants, which are designed to reflect the personality of the neighborhood. Their spaces are defined by natural materials, communal seating, and an open kitchen concept because sweetgreen is all about transparency.

The interior of this location includes a dining area, open kitchen design and pick up area for online orders. The dining area features custom white oak banquettes and tables overlooking the open kitchen, wall art, plants, and patio area. The kitchen is highlighted in kale green and white tile and stainless steel to showcase the food which is made from scratch daily. The pickup area is zoned in sweetgreen's signature kale green and located near the entrance for easy pick up. The space has been designed with sweetgreen customers as the priority, with the goal of providing an exceptional dine in or pick up experience.

### The Company

Conceived to bridge the gap between healthy eating and convenience, sweetgreen is a fast-casual restaurant serving regionally and locally sourced fresh ingredients that make up their specialty salads and "warm bowls". Every morning, Sweetgreen stores receive deliveries of fresh whole vegetables, fruits and grains, all of which are transformed into healthy, fresh menu items by their employee teams. Sweetgreen also offers a variety of beverages, but does not serve alcohol.

Sweetgreen is passionate about building relationships with each community, supporting and partnering with small and midsize farmers, and also volunteering with local non-profits.

Sweetgreen is committed to sustainability, as evidenced in their food packaging design and waste management practices. All sweetgreen stores have compost services and pick-up, averaging diverting 60% of waste from landfills, composting 75% of food scraps.

www.jsdinc.com









### **Operations**

The following information represents the most frequently asked questions regarding *sweetgreen*'s store operations.


- Employees:
  - o Approximately thirteen (13) employees are anticipated at peak shift, including full and part-time staff.
- Days/Hours of Operation (typical):
  - o Monday through Saturday, 6:00 a.m. to 11:00 p.m.
  - o Sunday 7:00 a.m. to 7:30 p.m.
- Days/Hours Open to the Public (typical):
  - o Monday through Saturday, 10:30 a.m. to 10:30 p.m.
  - o Sunday, 11:00 a.m. to 6:00 p.m.
- Covered Outdoor Dining:
  - Sweetgreen's proposed covered outdoor seating area is an amenity for the convenience of customers and it provides a critical opportunity for enhanced place-making.
  - Hours of operation to be determined and/or as allowed per code Monday through Saturday until 10:30 pm, Sunday until 6:00 pm.
- <u>Days/Hours for Delivery</u>:
  - Rear loading area deliveries anticipated (6) times per week, typically between the hours of 7:00 a.m. and 9:00 a.m.
  - Small deliveries via USPS/UPS/FedEx or similar, anticipated via front door during normal business hours.
- Food Ordering Method
  - Customer to order on-line or park and place an order in-store with two seating options: In-store or in the designated covered outdoor dining space or may leave directly after.
- Trash/Compost/Recycling:
  - Existing trash, composting, and recycling areas are located at the rear of the building, near the loading/service area.
  - Regularly scheduled pick-ups to occur (6) to (7) days per week.
  - o Hours of pick-up to be determined and as allowed per code.

## ATL

## **Emory Village: Concept 2**

1556 N Decatur Rd. Atlanta, GA April 8th, 2022

## SITE LOCATION + VICINITY

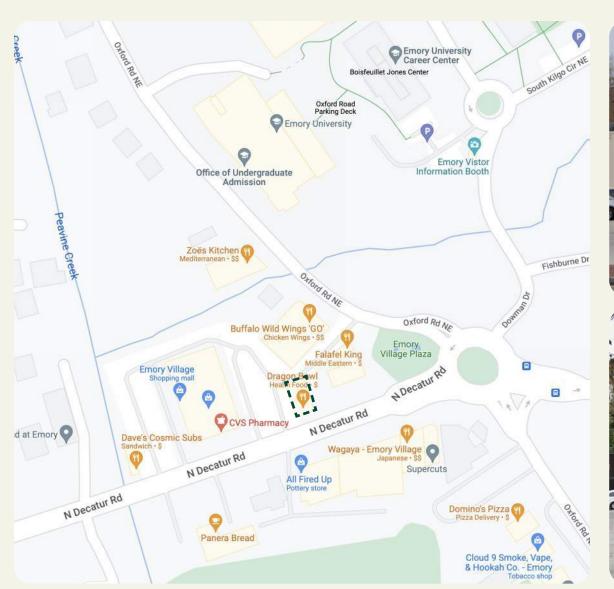






## **LOCKED LAYOUT**



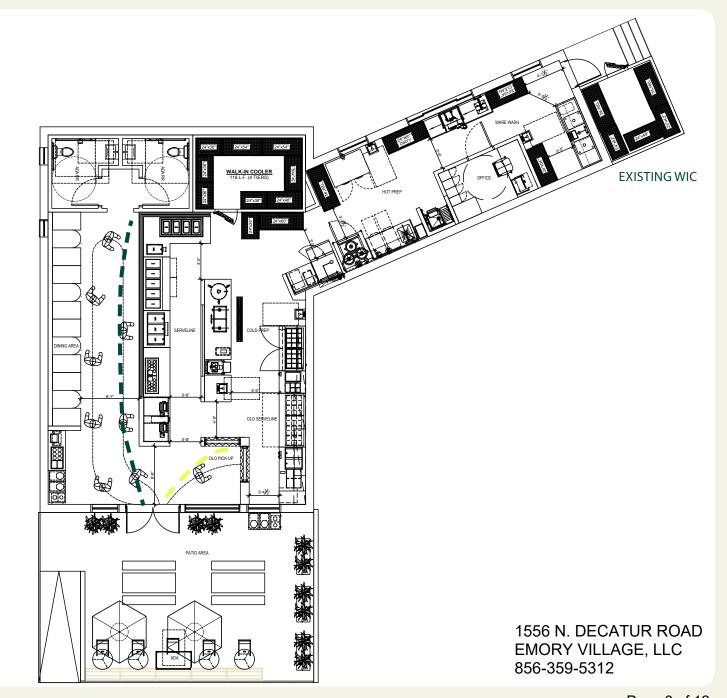

ATL: Emory Village

## MATERIAL PALETTE




ATL: Emory Village

EMORY VILLAGE, LLC 856-359-5312 Page 4 of 12

## **VIEW EXTERIOR 1**

STOREFRONT FACING SOUTHEAST - REAR BOX W/ DBL STROKE NEON 15" H



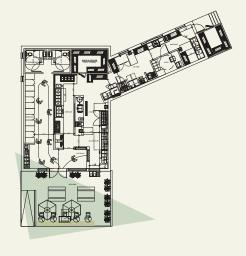

1556 N. DECATUR ROAD EMORY VILLAGE, LLC 856-359-5312




Existing storefront

ATL: Emory Village

## VIEW EXTERIOR 2

REAR BOX W/ DBL STROKE NEON 15" H



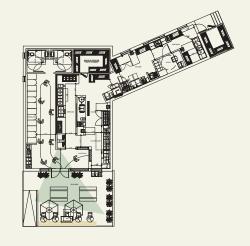


1556 N. DECATUR ROAD EMORY VILLAGE, LLC 856-359-5312




Existing storefront

## **VIEW EXTERIOR 4**

"COOL KIDS" POSTER SERIES WITH REAR BOX W/ DBL STROKE NEON 15" H

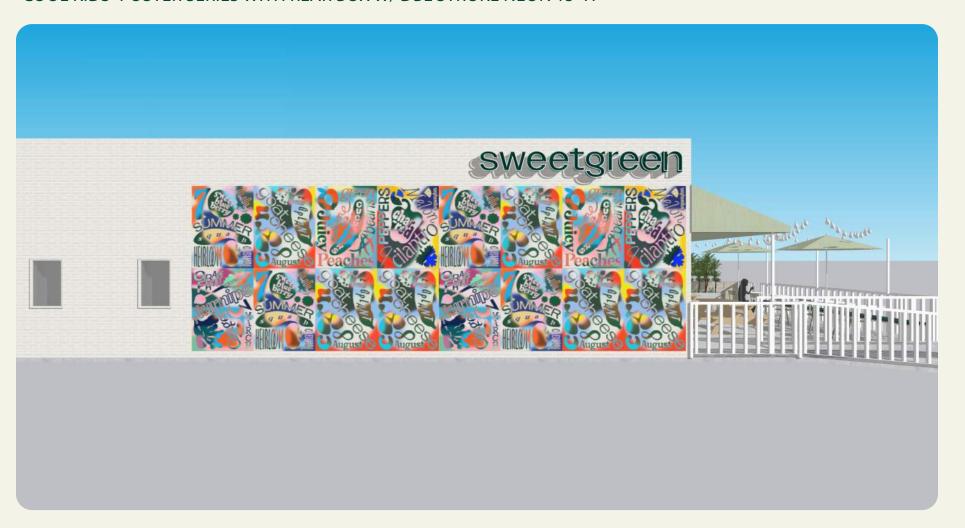

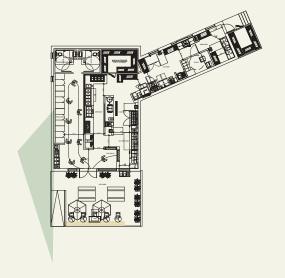

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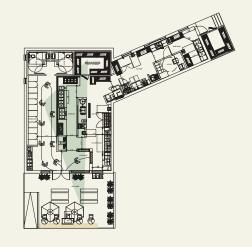


Existing storefront

## **VIEW INTERIOR 10**

**SECTION CUT - FRONTLINE** 







Live Customer Service: 1-888-293-2339

Mon-Fri: 8:00AM-7:00PM | Sat: 10:00AM-3:00PM EST Email: contact@Fifthroom.com

### Treated Pine Picnic Table w/ Attached Benches



6' Picnic Table Shown Unstained with 11" wide seats, 32" wide table top and decorative trim ends.

Prices: \$489 - \$849



### **Price Chart**

Options	Item#	Price
4' Table w/ Benches	[FT48SAE]	\$489
6' Table w/ Benches	[FT72SAE]	\$599
7' Table w/ Benches	[FT84SAE]	\$649
8' Table w/ Benches	[FT96SAE]	\$749
10' Table w/ Benches	[FT120SAE]	\$849

Leaves Warehouse in 7-10 Business Days

## Options and Upgrades Optional Stain:

- Cedar Stain/Sealer [25% Fee]
- Black Stain [25% Fee]
- White Stain [25% Fee]

Add Stainless Steel Hardware [+\$79] Add 2" Umbrella Hole [Free]

3 Optional Stains Available



### In the Good Old Wintertime

Our Treated Pine Picnic Table with Attached Benches is a classic. Its convenience, durability, and attractive design make it a perennial favorite. In fact, with year-round barbecuing becoming so popular during the past decade, our tables are commonly used on porches patios and yards throughout the seasons. So make your own summertime any time with this beautiful, sturdy treated pine table.

### **Specifications**

- · Treated Pine
- Galvanized Bolts, Washers, and Nuts
- 5'W x 30"H
- 32"W
- 11"W
- 140 lbs, 198 lbs, 224 lbs, 250 lbs or 300 lbs
- 750 lbs (each bench)
- · Cedar Tone, White, or Black Staining Available
- Rounded & Sanded Edges
- Made in the U.S.A.

### **Shipping & Assembly**

- · Ships Partially Assembled
- Approx. Assembly Time: 45 Minutes

1556 N. DECATUR ROAD EMORY VILLAGE, LLC 856-359-5312

## sweetgreen







ADA Table 24" x 48" x 29" HT 2-Top Cafe w/ Tripod Base 24" DIA x 29" HT Stackable Chair 18" x 20" x 17/31" HT

Bench w/o Back 18" x L" x 17/32" HT

> 1556 N. DECATUR ROAD EMORY VILLAGE, LLC 856-359-5312







(Top Left) The Douglas | Design: TBG Partners Dallas TX (At Right) Frisco Cinemark The Cut | Design: Kimley Horn - Frisco TX



### **WALL THICKNESS & SIZE LIMITATIONS**

- 1. The standard wall thickness cast for Form and Fiber's boX planters is as
- 3.0" Minimum wall thickness for planters up to 6'-0" L (72")
- 3.5" thickness for planters over 6'-0" L (72") and up to 8'-0" L (96")
- 4.0" thickness may be used per manufacturer discretion
- Limitations in size will apply over 8'-0" L and/or over 4,000 lbs.
- 2. Form and Fiber is able to cast a variety of sizes of boardform planters, however, limitations do apply.
- 8'-0" MAXIMUM LENGTH with a MAXIMUM WIDTH of 4'-0" or less

\*\*NOTE: CONCRETE BOX PLANTERS ARE FULLY CUSTOMIZABLE AND CAN BE FABRICATED TO DESIGNER SIZE SPECIFICATION WITHIN MANUFACTURER LIMITATIONS. NON-STANDARD SIZES WILL REQUIRE A ONE-TIME MOLD UPCHARGE.

### **CONCRETE BOX SERIES STANDARD SIZES**

PRODUCT ID	LENGTH	WIDTH	HEIGHT	MATERIAL	THICK- NESS	AVG. WT.
BX_CON 202014	20"	20"	14"	concrete	3 IN.	385 lbs
BX_CON 242418	24"	24"	18"	concrete	3 IN.	580 lbs
BX_CON 303018	30"	30"	18"	concrete	3 IN.	770 lbs
BX_CON 481824	48"	18"	24"	concrete	3 IN.	1015 lbs
BX_CON 601824	60"	18"	24"	concrete	3 IN.	1214 lbs
BX_CON 721824	72"	18"	24"	concrete	3 IN.	1414 lbs
BX_CON 242424	24"	24"	24"	concrete	3 IN.	725 lbs
BX_CON 482424	48"	24"	24"	concrete	3 IN.	1160 lbs
BX_CON 404024	40"	40"	24"	concrete	3 IN.	1370 lbs
BX_CON 161630	16"	16"	30"	concrete	3 IN.	548 lbs
BX_CON 482430	48"	24"	30"	concrete	3 IN.	1378 lbs
BX_CON 602430	60"	24"	30"	concrete	3 IN.	1631 lbs
BX_CON 722430	72"	24"	30"	concrete	3 IN.	1885 lbs
BX_CON 303030	30"	30"	30"	concrete	3 IN.	1133 lbs

1556 N. DECATUR ROAD **EMORY VILLAGE, LLC** 856-359-5312 Page 11 of 12

### ocean master classic

premium parasols

The Ocean Master Classic market style parasol is the culmination of durable engineering, stylish profiles and functional shade design. Manufactured to marine specifications, all Ocean Master parasols feature 100% replaceable parts for easy service and a 15/5-year warranty. Classic beauty. Classic TUUCI.



### finish options







## ft. / m. 5.5' / 1.65 6.5' / 2.0 7.5' / 2.25

\*8.5' /

square auto-scope ft. / m. \*10.0' / 3.0



octagon ft. / m. 6.0' / 1.8 7.5' / 2.25 \*9.0' / 2.75 \*10.5' / 3.2 \*11.5' / 3.6

octagon auto-scope ft. / m. \*13.0' / 4.0



ft. / m.
7.0' / 2.15

\*8.5' / 2.6

\*10.0' / 3.0

\*11.0' / 3.4



rectangle ft. / m. 5'x8' / 1.5 x 2.45 \*6'x9' / 1.8 x 2.75

rectangle auto-scope ft. / m. \*8' x 12' / 2.45 x 3.65

### finial options





### features:

- a. Manual Lift w/ Stainless Steel Security Pin
- b. "Auto-Loc" Marine Pulley Lift System
- c. "Easy Drive" Crank Lift System
- d. Reinforced Strut Joints Construction
- e. Armor-Wall Mast
- f. Reinforced Pocket Construction

1556 N. DECATUR ROAD EMORY VILLAGE, LLC 856-359-5312

### **ABBREVIATION LEGEND** CENTERLINE **EXISTING** NEW DIAMETER OR ROUND ADDITIONAL ABOVE FINISH FLOOR ALUMINUM ALUM ARCHITECTUR(URAL) ARCH ART AND CHAIR SUPPLIER ALARM SYSTEM SUPPLIER ASS **BOTTOM OF** BOARD BUILDING BLDG. CONCRETE MASONRY UNIT CHEMICAL SUPPLIER CS DIMENSION(S) ELEVATION (VERTICAL HEIGHT) ELECTRIC(AL) ELEC ELEVATION ELEV EQUAL **EXTERIOR** EXT FIBERGLASS-REINFORCED PANEL FIRE-RETARDANT TREATED GAUGE GALVANIZED GALV GENERAL CONTRACTOR GYPSUM GYP HIGH POINT HOOD SUPPLIER HEATING AND VENTILATING **HVAC** INTERIOR KITCHEN EQUIPMENT SUPPLIER KES MAXIMUM MAX. MECHANICAL MECH MANUFACTURER MFR MINIMUM MIN. MISCELLANEOUS MISC MUSIC SYSTEM SUPPLIER MSS NOT IN CONTRACT NUMBER ON CENTER ORIENTED STRAND BOARD OSB POWDER ACTUATED FASTENER PAF POINT OF SALE POS PREPARATION PREP POLYVINYL CHLORIDE PVC **RADIUS ROOF TOP UNITS** RTU **SWEETGREEN** SIMILAR SOLID SURFACE CCTV AND SAFE/CASHBOX STAINLESS STEEL SST STR STRUCTURE **TENANT** TO BE DETERMINED T.B.D. TOP OF T.O. TENANT'S TEST AND BALANCE VENDOR TAB TENANT'S CABLING CONTRACTOR TCC TENANT'S LIGHT/LAMP SUPPLIER TLS TENANT'S MENUBOARD SUPPLIER TMB TENANT'S MILLWORK SUPPLIER TMS TENANT'S PHONE SUPPLIER TENANT'S RAILING SUPPLIER TRS TENANT'S SIGNAGE VENDOR TYPICAL TYP UNINTERRUPTED POWER SUPPLY UNLESS NOTED OTHERWISE U.N.O. VENDOR VD VERIFY IN FIELD V.I.F. VARIES VAR WASHROOM ACCESSORIES TENANT'S WALK-IN COOLER SUPPLIER WCS TENANT'S WINDOW SHADE SUPPLIER **SYMBOL LEGEND** DXXX DATA DEVICE TAG DOOR TAG **BUILDING ELEVATION** FXXX **FURNITURE TAG** KITCHEN EQUIPMENT TAG INTERIOR ELEVATION PLUMBING FIXTURE TAG

### **PROJECT CONTACTS**

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Lena Giang

Sweetgreen

Suite 600

Tulsa, OK 74114

Salas O'Brien

Address Line 1

Address Line 2

Office: 404.881.5300

ELECTRICAL CODE

**ENERGY CODE:** 

**HEALTH CODE** 

WASHROOM ACCESSORIES TAG

**ROOM TAG** 

FINISH TAG

AREA TAG

**REVISION TAG** 

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Office: 918.295.5258

### **LANDLORD** SIGNAGE VENDOR Contact Name Chad Elliot Company Name Ruggles Sign Address Line 1 Address Line 1 Address Line 2 Address Line 2 Email: chad@rugglessign.com

KITCHEN VENDOR **DESIGN MANAGER** Katie Dixon Singer Equipment Design manager, 3881 Ten Oaks Road, Suite 2C architecture + planning Glenelg, MD 21737 Tel: 323.451.9323 kdixon@singerquipment.com

Office: 859.879.1199 ext. 129

sweetgreen.com Tel: 443.419.1009 **CONSTRUCTION MANAGER** Johnathan Davila **ZONING DEPARTMENT** 

City of Atlanta 55 Trinity Avenue johnathan.davila@sweetgreen.c Atlanta, GA 30303 **ARCHITECT OF RECORD** Office of Zoning & Development Email: dcpozd@atlantaga.gov Nathan Sauber Tel: 404.330.6145 Dewberry Architects, Inc. 1350 S. Boulder Ave

BUILDING DEPARTMENT Office of Buildings Email: nsauber@dewberry.com Email: dcp-oob@atlantaga.gov Tel: 404.330.6150

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com Fulton County Health Dept -**Environmantal Health** Central District Office 10 Park Place South S.E. Atlanta, GA 30303 Tel: 404.613.1303

THIRD PARTY INSPECTOR Contact Name Company Name Address Line 1 Address Line 2 Tel: xxx.xxx.xxxx

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DeKalb County Utility

Decatur, GA 30033

Tel: 404.378.4475

**SEWER UTILITY** 

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City of Atlanta

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**Customer Operations Service Center** 

dekalbwaterservice@dekalbcountyga.go

Dept Of Watershed Management

Email: coafog@atlantaga.gov

Atlanta Gas Light Company

Email: tcparks@southernco.com

**Builder and Property Support** 

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Tel: 877.365.3276 option 1

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Atlanta, GA 30318

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William Betts

Thomas Parks, Commerical Acct. Rep

Email: g2gpcbuilders@southernco.com

## **CODE AUTHORITIES**

CODE JURISDICTION LIFE SAFETY CODE NFPA 101 LIFE SAFETY CODE 2018 EDITION W/ STATE AMENDMENTS 2020 BUILDING CODE: 2018 IBC + GA AMENDMENTS (2020) ACCESSIBILITY CODE: 2018 GEORGIA ACCESSIBILITY CODE 120-3-10(.01-.08) 2018 INTERNATIONAL FIRE CODE + GA AMENDMENTS (2020) FIRE CODE:

MECHANICAL CODE: 2018 INTERNATIONAL MECHANICAL CODE + GA AMENDMENTS 2018 INTERNATIONAL PLUMBING CODE + GA AMENDMENTS PLUMBING CODE:

2020 NATIONAL ELECTRICAL CODE 2015 INTERNATIONAL ENERGY CODE + GA SUPPL. (2020) GEORGIA DEPT. OF HEALTH FOOD SERVICE RULES + REGS

## **SITE & OCCUPANCY**

### FOR COMPLETE CODE COMPLIANCE, REFER TO LIFE SAFETY SHEET G-200

PROJECT DESCRIPTION: NEW TENANT IMPROVEMENT **BUILDING HEIGHT:** 1 STORY TENANT AREA: 1,955 **BUILDING USE:** COMMERCIAL G-R, GENERAL RETAIL **ZONING:** RESTAURANT, FAST CASUAL TYPE OF USE: **TYPE OF OCCUPANCY:** A-2

BUILDING OCCUPANT LOAD AREA SF BENCH LF **FACTOR** OCC. LOAD 1.5 LF = 432 SF 30 LF KITCHEN 961 SF 100 SF = REST / CIRC 0 SF = 257 SF - / 1,650 SF 305 SF 1.5 LF = 305 SF 1,955 SF

MAXIMUM DISTANCE OF TRAVEL TO EXIT REQUIRED: 200' - 0" DISTANCE OF TRAVEL TO EXIT PROVIDED: **NUMBER OF EXITS REQUIRED:** 

## **PLUMBING FIXTURES**

NUMBER OF EXITS PROVIDED:

OCCUPANT LOAD	- PLUMBING				
ROOM NAME	AREA SF	1	LOAD FACTOR	=	OCC. LOAD
DINING	432 SF	/	0 SF	=	
KITCHEN	961 SF	/		=	
REST / CIRC	257 SF	/	0 SF	=	
	1,650 SF				0
PATIO	305 SF	/	200 SF	=	2
	305 SF				2

### **TOTAL PLUMBING OCCUPANTS: 46**

FIXTURE	MEN	l: (23)	WOME	EN: (23)
	REQ'D	PROVIDE	REQ'D	PROVIDE
WATER CLOSET	1	1	1	1
URINALS	1	1	N/A	N/A
LAVATORIES	1	1	1	1
DRINKING FOUNTAIN	NOT RE	EQUIRED	NOT RE	EQUIRED

- OCCUPANT USE AND LOAD FACTOR PER NFPA OCCUPANT LOAD FACTOR TABLE
- THE TOTAL NUMBER OF PLUMBING FIXTURES REQUIRED DETERMINED PER IBC 2018
- TABLE 2902.1 WATER TAP PROVIDED IN LIEU OF DRINKING FOUNTAIN

### **GENERAL NOTES**

- 1. THE GC SHALL REVIEW ALL DOCUMENTS AND FIELD VERIFY ALL DRAWING DIMENSIONS, INSPECT EXISTING FIELD CONDITIONS AND CONFIRM THAT THE WORK CAN BE BUILT AS SHOWN IN THE CONSTRUCTION DOCUMENTS.
- 2. ANY DISCREPANCIES BETWEEN THE DEMISED PREMISES PLAN, THE CONTRACT DOCUMENTS DRAWINGS AND THE FIELD INSPECTION CONDITIONS SHALL BE BROUGHT TO THE ATTENTION OF THE ARCHITECT FOR CLARIFICATION BEFORE PROCEEDING WITH WORK
- 3. THE GC SHALL BE RESPONSIBLE FOR THE LOSS AND/OR DAMAGE OF ALL OWNER SUPPLIED MATERIALS AND FIXTURES RECEIVED AND ACCEPTED AT THE SITE, WHETHER IN CONTRACT OR NOT.
- 4. GC SHALL MAINTAIN ALL EXITS, EXIT LIGHTING, FIRE PROTECTION DEVICES AND ALARMS CONFORMING WITH ALL APPLICABLE CODES AND ORDINANCES FOR THE ENTIRE DURATION OF THE WORK.
- 5. DURING ALL PHASES OF THE WORK, THE GC SHALL NOT DISTURB THE FUNCTIONS AND DELIVERIES OF NEIGHBORING TENANTS.
- 6. THE GC SHALL, IN THE WORK OF ALL TRADES, PERFORM ALL CUTTING, PATCHING, RESTORING, REPAIRING AND THE LIKE, NECESSARY TO COMPLETE THE WORK AND RESTORE ANY DAMAGED SURFACES RESULTING FROM THE WORK TO THEIR ORIGINAL CONDITION. ALL SAW CUTTING AND CORING LOCATIONS SHALL BE REVIEWED IN THE FIELD BY PROJECT MANAGER AND COORDINATED WITH THE LANDLORD PRIOR TO COMMENCING WORK. ALL ROOF PATCHING SHALL RETURN AFFECTED AREA TO A "LIKE NEW" CONDITION. PRIOR TO PATCHING THE GC SHALL VERIFY ANY ROOF WARRANTY WITH THE LANDLORD.
- 7. EACH SUBCONTRACTOR SHALL LEAVE THE CONSTRUCTION SITE IN A CLEAN AND ORDERLY CONDITION UPON COMPLETION OF HIS WORK ON A DAILY BASIS. ALL WASTE, RUBBISH AND EXCESS MATERIALS SHALL BE REMOVED FROM THE SITE PROMPTLY. THE GC SHALL BE RESPONSIBLE FOR REMOVAL AND DISPOSAL OF ALL TRASH, INCLUDING OWNER FURNISHED ITEMS AND TRASH GENERATED BY THE OWNER'S CONTRACTORS FOR THE DURATION OF THE PROJECT.
- 8. PERMITS FOR FIRE SPRINKLER SYSTEM, FIRE ALARM, SIGNAGE OR ANY OTHER PERMITS REQUIRED BY LOCAL AUTHORITIES ARE TO BE SUBMITTED UNDER SEPARATE APPLICATIONS. SEE SECTION DEFERRED SUBMITTALS THIS SHEET FOR ADDITIONAL CLARIFICATION.
- 9. DURING ALL CONSTRUCTION PHASES, THE GENERAL CONTRACTOR SHALL PROVIDE A PORTABLE FIRE EXTINGUISHER AS REQUIRED BY LOCAL LAWS AND/OR REGULATIONS.
- 10. A 44" CLEAR EXIT AISLE THOUGH ROOMS TO EXIT DOORS SHALL BE MAINTAINED AT ALL TIMES DURING THE CONSTRUCTION PERIOD.
- 11. EXIT DOORS SHALL SWING IN THE DIRECTION OF EGRESS TRAVEL
- 12. DOORS OPENING INTO AN EXIT CORRIDOR SHALL BE SELF-CLOSING AND HAVE A MINIMUM FIRE RESISTANCE RATING OF NO LESS THAN CORRIDOR WALL. DO NOT INSTALL HOLD-OPEN CLOSERS AT DOORS OPENING INTO EXIT CORRIDORS.
- 13. FIRE DAMPERS SHALL BE PROVIDED BY THE MECHANICAL SUBCONTRACTOR WHERE DUCTS PENETRATE FIRE-RATED WALLS, FLOORS OR CEILING ASSEMBLIES.
- 14. ALL EXIT DOORS SHALL BE READILY OPENED FROM THE EGRESS SIDE WITHOUT THE USE OF A KEY, SPECIAL KNOWLEDGE OR EFFORT.

### **SHEET INDEX**

M-201 HVAC ROOF PLAN

SHEET	SHEET TITLE	PERMIT ISSUE	REVISION A	REVISION B	REVISION C	ADDENDUM 1	ADDENDUM 2	
GENER			<u> </u>	<u> </u>	<u> </u>	_ <	_ <	
	PROJECT INFORMATION	X						Г
G-100	ACCESSIBILITY	X						
G-200	LIFE SAFETY PLAN	X						H
G-300	RESPONSIBILITY MATRIX	X						
DEMOL	ITION							
	DEMO STOREFRONT ELEVATIONS	X						
D-100	DEMOLITION PLAN	X						
I								
ARCHI								
A-000	SITE PLAN	Х						
A-020	BARRICADE PLANS, ELEVATIONS & DETAILS	Х						Г
A-030	STOREFRONT ELEVATIONS	Х						
A-032	ENLARGED PATIO PLAN	Х						
A-101	ANNOTATION & DIMENSION FLOOR PLAN	Х						
A-130	EQUIPMENT & FURNITURE PLAN	Х						
A-140	REFLECTED CEILING AND LIGHTING PLAN	X						
A-300	SLAB DETAILS	Х						
A-360	SAFETY AND ACCESSIBILITY GRAPHICS	X						
A-361	GRAPHICS COORDINATION	Х						
A-400	DOORS & WINDOWS	Х						
A-401	DOOR & WINDOW DETAILS	X						
		X						
MECHA	ANICAL							
	HVAC DEMO ROOF PLAN	X						
								_

## sweetgreen

3000 S. ROBERTSON BLVD. OS ANGELES, CALIFORNIA 9003

THESE DRAWINGS & SPECIFICATIONS ARE CONFIDENTIAL AND SHALL REMAIN THE SOLE PROPERTY OF SWEETGREE CORPORATION. THEY SHALL NOT BE REPRODUCED (IN WHOLE OR IN PART), SHARED WITH THIRD PARTIES OF USED IN ANY MANNER ON OTHER PROJECTS OR EXTENSIONS TO THIS PROJECT WITHOUT THE PRIOR WRITTEN CONSENT OF SWEETGREEN CORPORATION. THESE DRAWINGS & SPECIFICATIONS ARE INTENDED T EXPRESS DESIGN INTENT FOR A PROTOTYPICAL SWEETGREEN STORE (WHICH IS SUBJECT TO CHANGE A ANY TIME) AND MAY NOT REFLECT ACTUAL SITE CONDITIONS. NEITHER PARTY SHALL HAVE ANY OBLIGATIO NOR LIABILITY TO THE OTHER (EXCEPT AS STATED ABOVE UNTIL A WRITTEN AGREEMENT IS FULLY EXECUTED.

ARCHITECT OF RECORD:

Dewberry Architects Inc.

300 N. Lake Ave, 12th Floor Pasadena, Ca. 91101 916.239.4256 Phone 916.239.7245 Fax

STAMP:

XX.XX.XXX

## RD **2**6 2

DRAWN BY: CHECKED BY: PROJECT MANAGER: SG DESIGN MANAGER: SG CONSTR. MANAGER: PROJECT NO: 50139167 TEMPLATE VERSION: 05.06.2022

REVISIONS REV. DATE DESCRIPTION

**PROJECT INFORMATION** 

1556 N. DECATUR ROAD EMORY VILLAGE, LLC 856-359-5312

G-001



**SCOPE OF WORK** 

UNLESS OTHERWISE NOTED.


TENANT EXTERIOR AND INTERIOR ALTERATIONS TO AN EXISTING BUILDING. MODIFICATIONS TO INCLUDE NEW PARTITION WALLS, CEILINGS, ELECTRICAL, PLUMBING AND HVAC AS NEEDED FOR OPERATION OF A FAST-CASUAL SALAD RESTAURANT.

GROUP	TENANT	OCCUPANCY
PREVIOUS USE:	RESTAURANT	A-2
PROPOSED USE:	SWEETGREEN	A-2








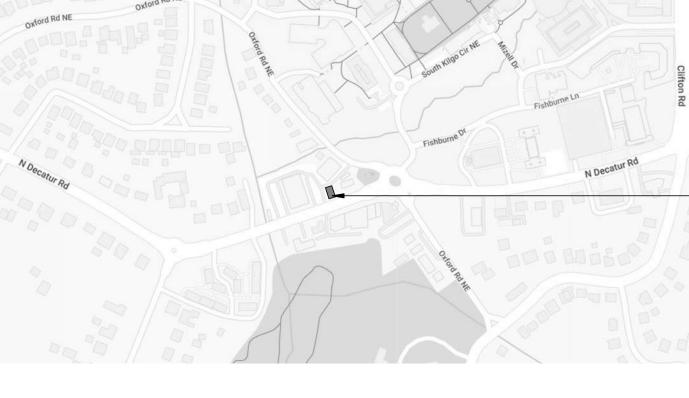



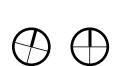

NORTH NORTH



View Title

1/4" = 1'-0" NORTH NORTH

SECTION MARKER

SECTION / DETAIL

LAYOUT POINT

**KEY NOTE TAG** 

**ROOM** XXX

**ROOM** 

XXX

PT-X

RB-X

CPT-X

## **ACCESSIBILITY NOTES**

ACCESSIBILITY & USABILITY FOR THE PHYSICAL HANDICAPPED SHALL BE PROVIDED IN PUBLIC AREAS. THE PROVISIONS SHALL COMPLY WITH THE REQUIREMENTS OF THE AMERICAN NATIONAL STANDARDS INSTITUTE, INC. (ANSI A 117.1) 2009 AND TITLE III OF THE 2010 AMERICANS WITH DISABILITIES ACT AS REQUIRED BY THE CODE, SHOWN GRAPHICALLY ON THIS SHEET AND IN NOTES BELOW.

### TENANT IS RESPONSIBLE FOR ALL SITE VERIFICATIONS.

TENANT'S LEASED PREMISES MUST COMPLY WITH TITLE III OF THE AMERICANS WITH DISABILITIES ACT (ADA). COMPLIANCE WILL INCLUDE, BUT NOT BE LIMITED TO, THE DESIGN, CONSTRUCTION AND / OR ALTERATION OF THE LEASED PREMISES.

### DOORS AND HARDWARE:

- 1. EXIT DOORS SHALL BE OPERABLE FROM THE INSIDE WITHOUT THE USE OF KEY OR SPECIAL KNOWLEDGE OF EFFORT. HANDLES, PULLS, LATCHES, LOCKS AND OTHER OPERABLE PARTS ON ACCESSIBLE DOORS SHALL HAVE A SHAPE THAT IS EASY TO GRASP WITH ONE HAND AND DOES NOT REQUIRE TIGHT GRASPING. PINCHING. OR TWISTING OF THE WRIST TO OPERATE. OPERABLE PARTS OF SUCH HARDWARE SHALL BE 34 INCHES MINIMUM AND 48 INCHES MAXIMUM ABOVE THE FLOOR.
- 2. ALL ENTRANCES AND EXIT DOORS TO BUILDING SHALL BE MADE ACCESSIBLE TO THE DISABLED. WHERE BUILDING CODE PERMITS, PROVIDE SIGNAGE TO ACCESSIBLE ENTRY/EXIT IF ALL LOCATIONS ARE NOT ACCESSIBLE.
- 3. EVERY REQUIRED EXIT DOORWAY SHALL BE OF A SIZE AS TO PERMIT THE INSTALLATION OF A DOOR NOT LESS THAN 3 FEET IN WIDTH AND NOT LESS THEN 6"-8" IN HEIGHT. WHEN INSTALLED IN EXIT DOORWAYS, EXIT DOORS SHALL BE CAPABLE OF OPERATING AT LEAST 90 DEGREES AND SHALL BE MOUNTED SO THAT THE CLEAR WIDTH OF THE
- 4. PER ADA SECTION 404.2, MAXIMUM EFFORT TO OPERATE DOORS SHALL NOT EXCEED 5 POUNDS FOR EXTERIOR DOORS AND 5 POUNDS FOR INTERIOR DOORS, SUCH PULL OR PUSH EFFORT BEING APPLIED AT RIGHT ANGLES TO HINGED DOORS AND AT THE CENTER PLANE OF SLIDING OR FOLDING DOORS. COMPENSATING DEVICES OR AUTOMATIC DOOR OPENERS MAY BE UTILIZED TO MEET THE ABOVE STANDARDS. DOOR CLOSERS TO BE SET TO TAKE AT LEAST 5 SECONDS TO CLOSE FROM AN OPEN POSITION OF 70 DEGREES TO WITHIN 3" OF THE LATCH. WHEN FIRE DOORS ARE REQUIRED, THE MAXIMUM EFFOR TO OPERATE THE DOOR MAY BE INCREASED NOT TO EXCEED 15 POUNDS.
- 5. THE BOTTOM 10" OF ALL DOORS, EXCEPT AUTOMATIC AND SLIDING, SHALL HAVE A SMOOTH UNINTERRUPTED SURFACE TO ALLOW THE DOOR TO BE OPENED BY A WHEELCHAIR FOOTREST WITHOUT CREATING A TRAP OR HAZARDOUS CONDITION. WHERE NARROW FRAME DOORS ARE USED, 1" HIGH SMOOTH PANEL SHALL BE INSTALLED ON THE PUSH SIDE OF THE DOOR, WHICH WILL ALLOW THE DOOR TO BE OPENED BY A WHEELCHAIR FOOTREST WITHOUT CREATING A TRAP OR HAZARDOUS CONDITION.
- 6. THRESHOLDS SHALL NOT EXCEED 1/2" IN HIEGHT.
- 7. THE FLOOR OR LANDING ON EACH SIDE OF AN EXIT DOOR SHALL BE LEVEL. THE LEVEL AREA SHALL HAVE A LENGTH IN THE DIRECTION OF DOOR SWING OF AT LEAST 60" AND A LENGTH OPPOSITE THE DIRECTION OF THE DOOR SWING OF 44"-48" IN LENGTH, DEPENDENT UPON DIRECTION OF APPROACH AND EXISTENCE OF LATCH AND CLOSER.
- 8. THE SPACE BETWEEN TWO CONSECTUIVE DOOR OPENINGS IN A VESTIBULE, SERVING OTHER THAN A REQUIRED EXIT STAIRWAY, SHALL PROVIDE A MINIMUM OF 48" OF CLEAR SPACE FROM ANY DOOR OPENING INTO SUCH VESTIBULE WHEN THE DOOR IS POSITIONED TO AN ANGLE OF 90 DEGREES FROM ITS CLOSED POSITION. DOORS IN A SERIES SHALL SWING EITHER IN THE SAME DIRECTION OR AWAY FROM THE SPACE BETWEEN THE DOORS.

### SIGNS AND IDENTIFICATIONS:

- 1. LETTERS AND NUMBERS ON SIGNS SHALL HAVE A WIDTH-TO-HEIGHT RATIO BETWEEN 3:5 AND 1:1 AND A STROKE-WIDTH-TO-HEIGHT RATIO BETWEEN 1:5 AND1:10, UTILIZING AN UPPERCASE "I" FOR MEASUREMENT. (703.2)
- 2. CHARACTERS, SYMBOLS, OR PICTOGRAPHS ON TACTILE SIGNS SHALL BE RAISED 1/32" (0,8 MM) MINIMUM. RAISED LETTERS AND NUMBERS SHALL BE SANS SERIF UPPERCASE CHARACTERS. RAISED CHARACTERS OR SYMBOLS SHALL BE AT LEAST 5/8" (16 MM) HIGH, BUT NO HIGHER THAN A NOMINAL 2" (51 MM). (703.3)

### AUDIBLE ALARMS:

. AUDIBLE EMERGENCY ALARMS SHALL PRODUCE A SOUND THAT EXCEEDS THE PREVAILING EQUIVALENT SOUND LEVEL IN THE ROOM OR SPACE BY AT LEAST 15 DECIBELS OR EXCEEDS ANY MAXIMUM SOUND LEVEL WITH A DURATION OF 30 SECONDS BY 5 DECIBELS, WHICHEVER IS LOUDER. SOUND LEVELS FOR ALARM SIGNALS SHALL NOT EXCEED 120 DECIBALS.


### VISUAL ALARMS:

1. VISUAL ALARMS SHALL BE FLASHING LIGHTS ARRANGED TO FLASH IN CONJUNCTION WITH THE AUDIBLE EMERGENCY ALARMS. THE FLASHING FREQUENCY OF VISUAL ALARMS SHALL BE APPROXIMATELY 1 HZ. SPECIALIZED SYSTEMS USING ADVANCED TECHNOLOGY MAY BE SUBSTITUTED IF EQUIVALENT PROTECTION IS AFFORDED HANDICAPPED USERS OF THE BUILDING OR FACILITY.

### **AUXILIARY ALARMS:**

SENSORY ALARMS PROVIDED FOR PERSONS WITH HEARING IMPAIRMENTS SHALL BE CONNECTED TO THE BUILDING EMERGENCY SYTEM OR THERE SHALL BE A STANDARD 1100-VOLT ELECTRICAL RECEPTACLE INTO WHICH AN ALARM UNIT CAN BE CONNECTED TO BE ACTIVATED BY THE BUILDING ALARM SYSTEM. INSTRUCTIONS FOR USE OF THE AUXILIARY ALARM OR CONNECTIONS SHALL BE PROVIDED.

## **CLEAR FLOOR SPACE & TURNING SPACE**

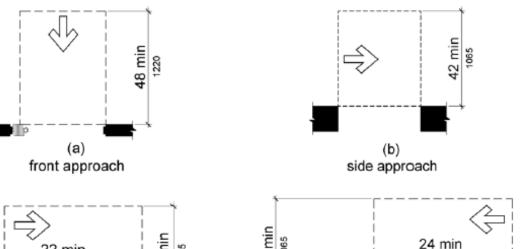

pocket or hinge approach

**INTERNATIONAL SYMBOL** 

**OF ACCESSIBILITY** 

1/4" ROUNDED

EASED EDGE -

INTERNATIONAL SYMBOL

SYMBOL OF ACCESSIBILITY

WHITE FIGURE ON A BLUE

BACKGROUND. THE BLUE


OF ACCESSIBILITY —


THE INTERNATIONAL

SHALL CONSIST OF A

SHALL BE FS 15090 IN FEDERAL STANDARD 595C.

CORNERS —

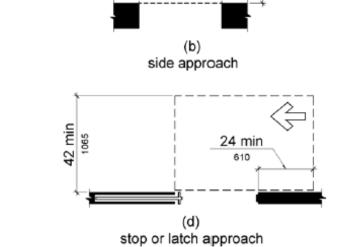

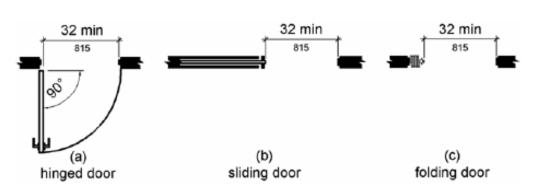

hinge approach, push side, door

provided with both closer and latch

latch approach, pull side,


door provided with closer


latch approach, push side


door provided with closer


latch approach, pull side


latch approach, push side

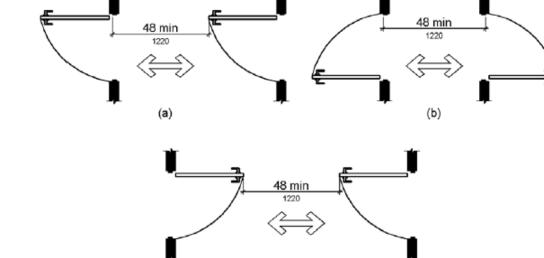


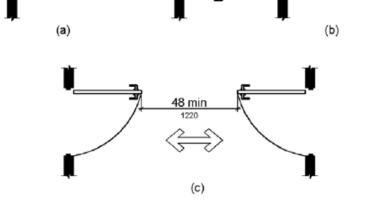

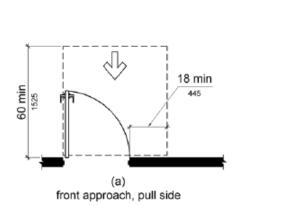


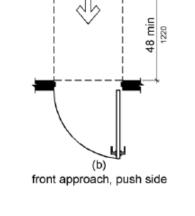

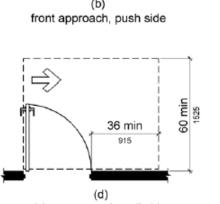

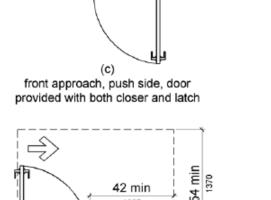

hinge approach, pull side

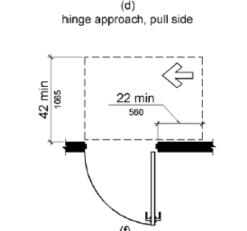

hinge approach, push side



ARCHITECT OF RECORD:

300 N. Lake Ave, 12th Floor Pasadena, Ca. 91101 916.239.4256 Phone 916.239.7245 Fax

sweetgreen

3000 S. ROBERTSON BLVD.

LOS ANGELES, CALIFORNIA 9003

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WRITTEN CONSENT OF SWEETGREEN CORPORATION. THESE DRAWINGS & SPECIFICATIONS ARE INTENDED T

EXPRESS DESIGN INTENT FOR A PROTOTYPICAL SWEETGREEN STORE (WHICH IS SUBJECT TO CHANGE A

ANY TIME) AND MÀY NOT REFLECT ACTUAL SITE

CONDITIONS. NEITHER PARTY SHALL HAVE ANY OBLIGATIO NOR LIABILITY TO THE OTHER (EXCEPT AS STATED ABOVE

UNTIL A WRITTEN AGREEMENT IS FULLY EXECUTED.

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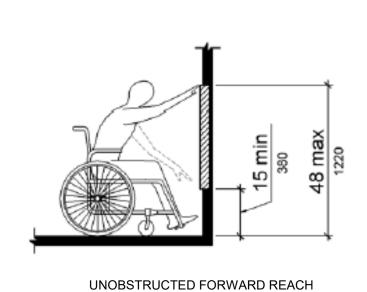
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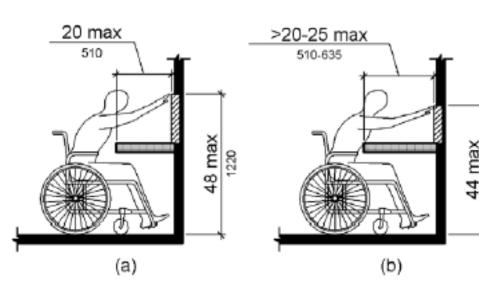
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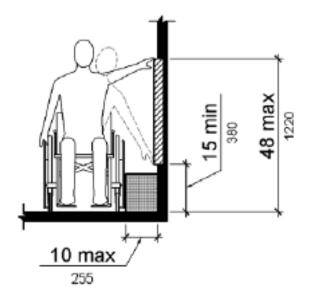
05.06.2022


DESCRIPTION

## **REACH RANGES:**








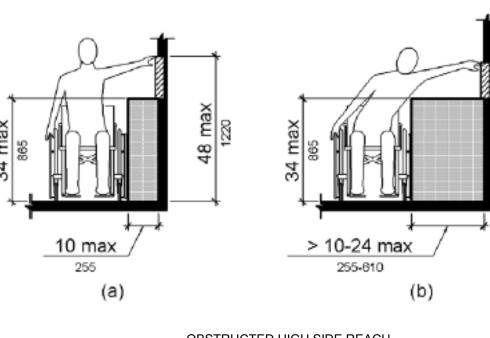

# **CLEAR FLOOR SPACE & TURNING SPACE**

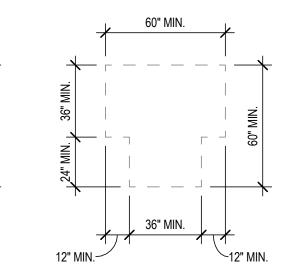


OBSTRUCTED FORWARD REACH







## OBSTRUCTED HIGH SIDE REACH


## **ACCESSIBILITY ROUTE REQUIREMENTS:**

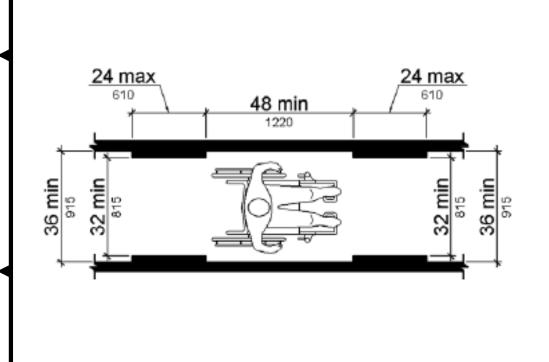


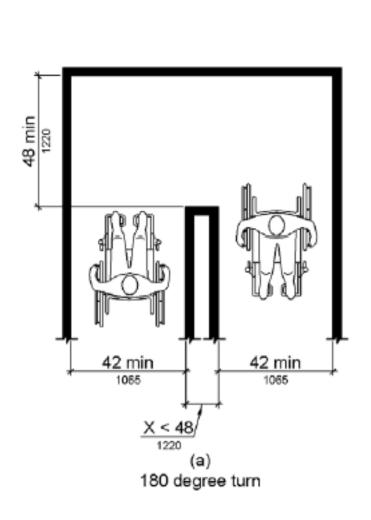


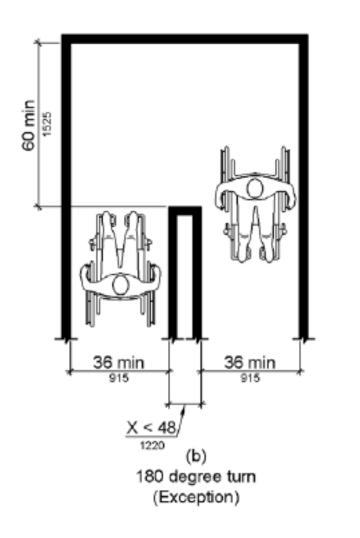


## **TOILET AND PLUMBING FACILITIES:**

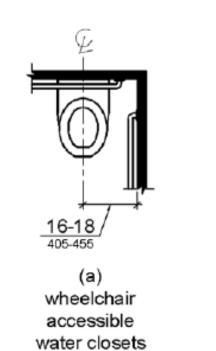


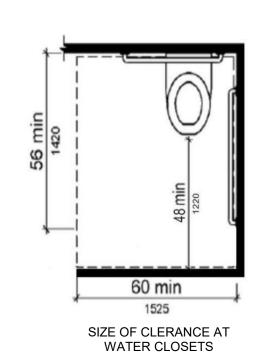


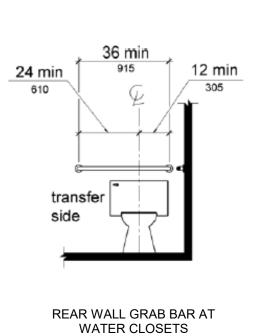

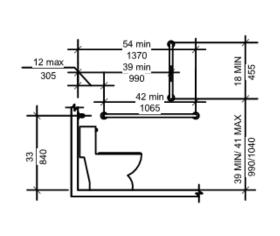

SIDE WALL GRAB BAR AT WATER CLOSETS

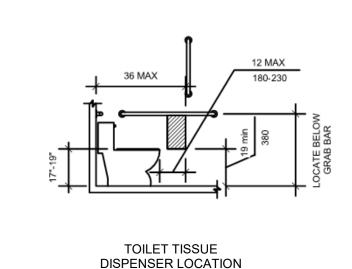

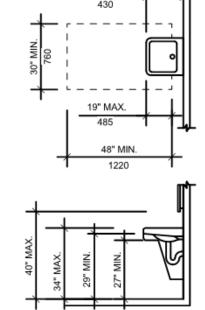

CLEARANCE

REQUIREMENTS AT LAVATORY

**ACCESSIBILITY** 1556 N. DECATUR ROAD EMORY VILLAGE, LLC

DRAWN BY: CHECKED BY:


REVISIONS REV. DATE

SG DESIGN MANAGER: SG CONSTR. MANAGER:

TEMPLATE VERSION:

G-100

856-359-5312

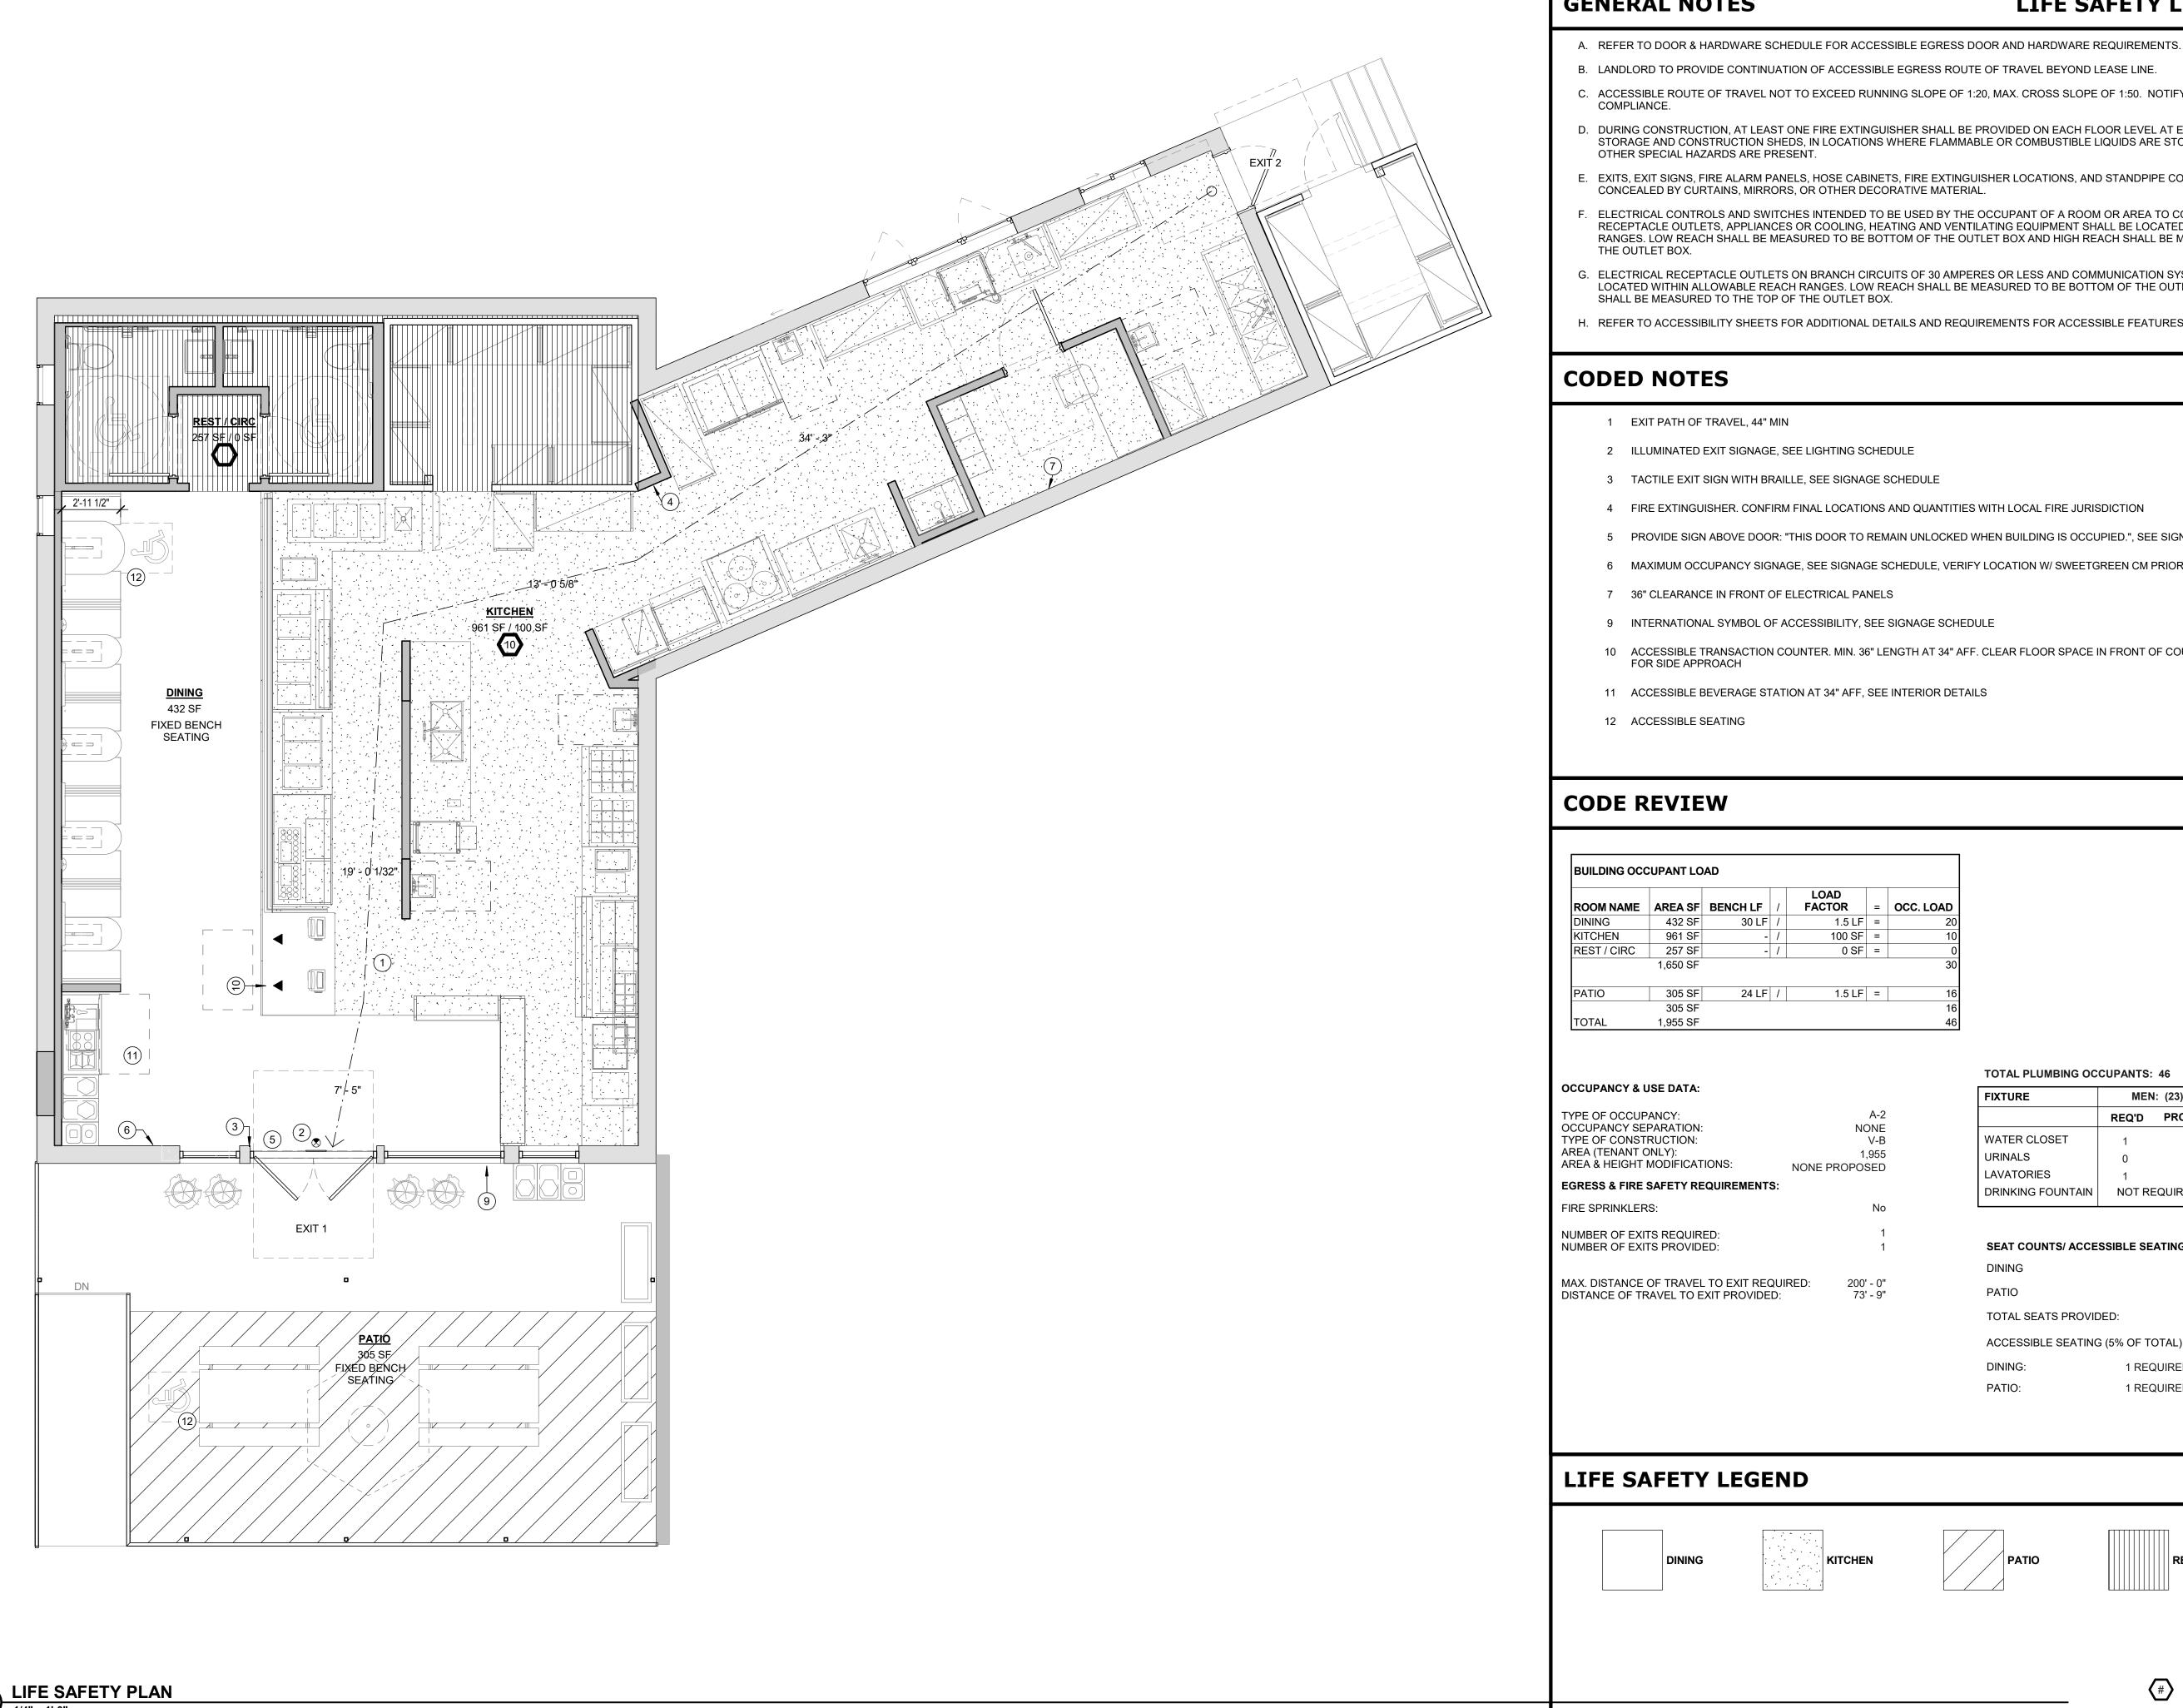

### **GENERAL NOTES** LIFE SAFETY LEGEND

- B. LANDLORD TO PROVIDE CONTINUATION OF ACCESSIBLE EGRESS ROUTE OF TRAVEL BEYOND LEASE LINE.
- C. ACCESSIBLE ROUTE OF TRAVEL NOT TO EXCEED RUNNING SLOPE OF 1:20, MAX. CROSS SLOPE OF 1:50. NOTIFY ARCHITECT OF NON-
- D. DURING CONSTRUCTION, AT LEAST ONE FIRE EXTINGUISHER SHALL BE PROVIDED ON EACH FLOOR LEVEL AT EACH STAIRWAY, IN ALL STORAGE AND CONSTRUCTION SHEDS, IN LOCATIONS WHERE FLAMMABLE OR COMBUSTIBLE LIQUIDS ARE STORED OR USED, AND WHERE
- E. EXITS, EXIT SIGNS, FIRE ALARM PANELS, HOSE CABINETS, FIRE EXTINGUISHER LOCATIONS, AND STANDPIPE CONNECTIONS SHALL NOT BE CONCEALED BY CURTAINS, MIRRORS, OR OTHER DECORATIVE MATERIAL
- F. ELECTRICAL CONTROLS AND SWITCHES INTENDED TO BE USED BY THE OCCUPANT OF A ROOM OR AREA TO CONTROL LIGHTING AND RECEPTACLE OUTLETS, APPLIANCES OR COOLING, HEATING AND VENTILATING EQUIPMENT SHALL BE LOCATED WITHIN ALLOWABLE REACH RANGES. LOW REACH SHALL BE MEASURED TO BE BOTTOM OF THE OUTLET BOX AND HIGH REACH SHALL BE MEASURED TO THE TOP OF
- G. ELECTRICAL RECEPTACLE OUTLETS ON BRANCH CIRCUITS OF 30 AMPERES OR LESS AND COMMUNICATION SYSTEM RECEPTACLES SHALL BE LOCATED WITHIN ALLOWABLE REACH RANGES. LOW REACH SHALL BE MEASURED TO BE BOTTOM OF THE OUTLET BOX AND HIGH REACH SHALL BE MEASURED TO THE TOP OF THE OUTLET BOX.
- H. REFER TO ACCESSIBILITY SHEETS FOR ADDITIONAL DETAILS AND REQUIREMENTS FOR ACCESSIBLE FEATURES.

## **CODED NOTES**

- 1 EXIT PATH OF TRAVEL, 44" MIN
- 2 ILLUMINATED EXIT SIGNAGE, SEE LIGHTING SCHEDULE
- 3 TACTILE EXIT SIGN WITH BRAILLE, SEE SIGNAGE SCHEDULE
- 4 FIRE EXTINGUISHER. CONFIRM FINAL LOCATIONS AND QUANTITIES WITH LOCAL FIRE JURISDICTION
- 5 PROVIDE SIGN ABOVE DOOR: "THIS DOOR TO REMAIN UNLOCKED WHEN BUILDING IS OCCUPIED.", SEE SIGNAGE SCHEDULE
- 6 MAXIMUM OCCUPANCY SIGNAGE, SEE SIGNAGE SCHEDULE, VERIFY LOCATION W/ SWEETGREEN CM PRIOR TO INSTALLATION.
- 7 36" CLEARANCE IN FRONT OF ELECTRICAL PANELS
- 9 INTERNATIONAL SYMBOL OF ACCESSIBILITY, SEE SIGNAGE SCHEDULE
- 10 ACCESSIBLE TRANSACTION COUNTER. MIN. 36" LENGTH AT 34" AFF. CLEAR FLOOR SPACE IN FRONT OF COUNTER TO BE MIN. 30"x48" FOR SIDE APPROACH
- 11 ACCESSIBLE BEVERAGE STATION AT 34" AFF, SEE INTERIOR DETAILS
- 12 ACCESSIBLE SEATING

## **CODE REVIEW**

				LOAD		
ROOM NAME	AREA SF	BENCH LF	/	FACTOR	=	OCC. LOAD
DINING	432 SF	30 LF	/	1.5 LF	=	20
KITCHEN	961 SF	-	/	100 SF	=	10
REST / CIRC	257 SF	-	/	0 SF	=	0
	1,650 SF					30
PATIO	305 SF	24 LF	/	1.5 LF	=	16
	305 SF					16
TOTAL	1,955 SF					46

### OCCUPANCY & USE DATA:

TYPE OF OCCUPANCY: OCCUPANCY SEPARATION:	A- NON
TYPE OF CONSTRUCTION:	V-
AREA (TENANT ONLY):	1,95
AREA & HEIGHT MODIFICATIONS:	NONE PROPOSE
EGRESS & FIRE SAFETY REQUIREMENTS:	

NUMBER OF EXITS REQUIRED: NUMBER OF EXITS PROVIDED:	1
MAX. DISTANCE OF TRAVEL TO EXIT REQUIRED:	200' - 0"
DISTANCE OF TRAVEL TO EXIT PROVIDED:	73' - 9"

### **TOTAL PLUMBING OCCUPANTS: 46**

FIXTURE	MEN	l: (23)	WOME	EN: (23)
	REQ'D	PROVIDE	REQ'D	PROVIDE
WATER CLOSET	1	1	1	1
URINALS	0	0	N/A	N/A
LAVATORIES	1	1	1	1
DRINKING FOUNTAIN	NOT RE	EQUIRED	NOT RE	EQUIRED

### SEAT COUNTS/ ACCESSIBLE SEATING REQUIREMENTS:

		20
PATIO		16
TOTAL SEATS PROVIDED:		36
ACCESSIBLE SEATING (5%	of TOTAL)	
DINING:	1 REQUIRED	1 PROVIDED

	DRAWN BY:	TF
	CHECKED BY:	JW
	PROJECT MANAGER:	ZM
	SG DESIGN MANAGER:	LG
	SG CONSTR. MANAGER:	JD
D	PROJECT NO:	501391
:D	TEMPLATE VERSION:	05.06.20

REV. DATE

sweetgreen

3000 S. ROBERTSON BLVD.

LOS ANGELES, CALIFORNIA 90034

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UNTIL A WRITTEN AGREEMENT IS FULLY EXECUTED.

**Dewberry** 

Dewberry Architects Inc.

Pasadena, Ca. 91101 916.239.4256 Phone

916.239.7245 Fax

300 N. Lake Ave, 12th Floor

XX.XX.XXXX

ARCHITECT OF RECORD:

## LIFE SAFETY LEGEND







PATIO:



**LIFE SAFETY PLAN** 

1556 N. DECATUR ROAD EMORY VILLAGE, LLC 856-359-5312

DESCRIPTION

G-200

NORTH NORTH

TYPE OF OCCUPANCY: OCCUPANCY SEPARATION: TYPE OF CONSTRUCTION: AREA (TENANT ONLY): AREA & HEIGHT MODIFICATIONS:	NOI V 1,9 NONE PROPOSI
EGRESS & FIRE SAFETY REQUIREMENTS:	
FIRE SPRINKLERS:	I

OCCUPANCY LOAD

1 REQUIRED 1 PROVIDE

- - - -  $\rightarrow$  PATH OF TRAVEL

ITEM		FURN	NISH	INST	LL REMARKS	ITEM		T <sub>F</sub>	URNISI	H   II	NSTALI	L REMARKS	
	<del></del>	/	/ /					<del>/</del>	/ /	7	/ /		GENE
			/ /						/ /	/ /	/ /	RED P	1. GC TO
	(IST)	:/\\\\\\\\\\\\\\\\\\\\\\\\\\\\\\\\\\\\	(187	CONTR				187	& / <b>/</b>	187	œ'/ <b>/</b>		KNOW! APPLIC
		\ <u>\disp</u>		00/								문 <b>/</b> 근	2. GC SH
	10 / V	# H	10 / F	4				1. P.	F. C.	.RAL		<b>:</b> /	PENET INSTAL
	SENIE		SENI	MO			L'ANG						WALL F PROJE
GENERAL CONDITIONS	14/0/	, 0,	<del>7</del> / 0	/ O <b>/</b> 0.		SPECIALTY ITEMS AND EQUIPMENT	<b></b> /~/	/ 0 / (	<i>5</i> <b>7</b> ~ /	<u> </u>	<i>5</i>   <i>6</i>		CONST
ALL OTHER PERMITS		Т		Т		ALL FURNITURE	$\Box$				П	REFER TO EQUIPMENT SCHEDULE FOR RESPONSIBILITIES	1
BUILDING & HEALTH PERMITS			0		GC TO OBTAIN & PAY FOR ALL PERMITS; DO NOT INCLUDE THESE IN BID	ALL KITCHEN EQUIPMENT						REFER TO EQUIPMENT SCHEDULE FOR RESPONSIBILITIES	3. GC RE WATER
DUMPSTERS / TOILETS	0	_	0	4		BLOCKING OR CARRIER SYSTEM FOR WALL MOUNTED RR SINK	$\perp$	0				PROVIDE & INSTALL PER SINK MFR. REQUIREMENTS	FIXTU
GC TO UNLOAD ALL MATERIALS PURCHASED DIRECTLY BY OWNER  NSPECTIONS, CERTIFICATIONS AND CERTIFICATE OF OCCUPANCY		-			GC TO CALL-IN/SCHEDULE ALL REQUIRED INSPECTIONS, INCLUDING HEALTH	BOOTHS/BANQUETTES  CHEMICAL DISPENSERS						OWNER TO PROVIDE CONTROL SAMPLE OF MATERIAL OWNER VENDOR INSTALLS AND PROVIDES	4. GC SH WATE
LANDLORD SUBCONTRACTORS					GC TO PAY FOR ALL OTHERS	CONDUIT WITH PULLSTRING FOR PHONE						OWNER VENDOR INSTALLS AND I ROVIDES	5. GC TC
PROTECTION OF SITE WORK AND ADJACENT CONSTRUCTION					GC TO PATCH & REPAIR DAMAGED AREAS DUE TO DEMO & NEW WORK	DATA WIRING IN PREMISES				0		GC TO PROVIDE AND PULL, SG VENDOR TO TERMINATE	SPECI
PROJECT PROCEDURES, FIELD ENGINEERING	0		0			DECOR PACKAGE/ARTWORK						GC TO ASSEMBLE & INSTALL	6. GC TC
PROJECT PROCEDURES		_		_		DOOR CHIME W/TRANSFORMER AND PUSH BUTTON		0		) )	++	GC TO VERIFY LOCATIONS & QUANTITIES PER FIRE MARSHALL	7. GC TC
PUNCH LIST PRIOR TO CONSTRUCTION TURNOVER REDLINED AS-BUILT PLANS					GC TO PROVIDE DIGITAL & ONE HARD COPY	FIRE EXTINGUISHERS  INTERIOR MENU BOARDS						GC COORDINATE INSTALL W/OWNER	8. ALL FI
EMPORARY BARRICADES					COORDINATE CONSTRUCTION BARRICADE WITH LL	INTERIOR RAILINGS							MATE
PEMOLITION						INTERIOR SIGNAGE - RESTROOM				0		ELEC. ATTACHMENT, BLOCKING & ANY ACCESS PANELS BY GC.	9. LAND
ALL CONSTRUCTION DEBRIS REMOVAL		_			INCLUDING DISPOSAL OF CRATING & PACKING	INTERIOR SIGNAGE - EGRESS REQUIRED  INTERIOR SIGNAGE - DECORATIVE					+	ELEC. ATTACHMENT, BLOCKING & ANY ACCESS PANELS BY GC.	10. OWN
ALL EXTERIOR BUILDING DEMO ALL EXTERIOR SITE DEMO		-			SEE WORK LETTER AND DRAWINGS SEE WORK LETTER AND DRAWINGS	INTERIOR SIGNAGE - DECORATIVE  INTERIOR SIGNAGE - ILLUMINATED HANGING SIGN					1	ELEC. ATTACHMENT & BLOCKING BY GC	11. GC RE
LL INTERIOR DEMO			0		SEE WORK LETTER AND DRAWINGS	INTERNET LINES TO SPACE		00				GC DOES FINAL HOOK-UP	12. GC SI
LL ROOFTOP UNITS/CURBS/EXHAUSTS/ OTHER ROOF EQUIPMENT	0		0		SEE WORK LETTER AND DRAWINGS	LOW-E FILM							CONS
SBESTOS, MOLD, PESTS BACTERIAL CONDITIONS	0		0		TO BE REMOVED IF ANYTHING FOUND ON SITE	MOSAICS	$\bot$	0				OO COODDINATE INICTALL MUCHANIES	FIRE S
FFENSIVE SMELLS  NTERIOR WORK					TO BE CLEANSED AND ELIMINATED ENTIRELY	ORDER/PICK-UP SIGNAGE PATIO FURNITURE	+			) )	++	GC COORDINATE INSTALL W/OWNER	13. ANY I INST <i>A</i>
CCESSIBLE RESTROOMS						PATIO PORNITORE  PATIO RAILING & SHOP DRAWINGS	+				++	GC TO PROVIDE QUART OF TOUCH UP PAINT	1
LL FLOOR TRANSITION STRIPS			0		COOLER BASE BY COOLER MANUFACTURER SEE PLAN FOR LOCATIONS	POS EQUIPMENT AND CABLES							TUR
LL METAL CORNER GUARDS AND PLATES	0	1	0		ALL TILED AND FRP WALLS TO HAVE OUTSIDE CORNER GUARDS	PRIVACY FILM		0		)			
EILING TILE RACK SUPPRESSION MEMBRANE		+	0	+		SAFE SNEEZE GUARD GLASS W/FRAME	$\dashv$				-	GC TO PROVIDE POWER AS REQUIRED GC TO PROVIDE BLOCKING/SHIMS AS REQUIRED	1. PRIOF REMO
EMISING WALLS FRAMING/OTHER CONSTRUCT WALL PER CODE		+		+	N/A	SECURITY CONDUIT AND J-BOXES AND COVER PLATES	+				++	OO TO LINOVIDE DEOCKING/ONING AS REQUIRED	SCOPI
NAL CLEANING					KES TO REMOVE PROTECTIVE VINYL FILM FROM ALL EQUIPMENT	SECURITY WIRING AND EQUIPMENT		0 0				PROVIDED AND INSTALLED BY SSS	2. THE G FURNI
OORING AND BASE		丁	0		AS SCHEDULED, REFER TO FINISH PLAN AND SCHEDULES	SOUND SYSTEM AND SPEAKERS							A LIST
YP. BD. AT DEMISING WALL PER CODE GYP. BD. READY TO PAINT		_		_	N/A	SOUND SYSTEM CONDUITS - J-BOXES AND COVER PLATES		0			+		ITEMS GC SH
YP. BD. AT PERIMETER WALLS GYP. BD. READY TO PAINT ITERIOR CONCRETE SLAB				-	EXISTING; GC TO REPAIR/REPLACE WHERE DAMAGED OR MISSING REFER TO PLANS FOR SCOPE	SOUND SYSTEM WIRING  TELEPHONE SYSTEMS - J-BOXES AND COVER PLATES						GC PROVIDE NEEDED CONDUIT	3. THE G
ITERIOR LIGHTING AND WAYFINDING					SEE LIGHTING SCHEDULE, ELECTRICAL DRAWINGS	TOILET ROOM ACCESSORIES						AS SHOWN ON PLAN	GC TC EACH
ITERIOR PARTITIONS FRAMING, SUBSTRATE AND BLOCKING			0			TOILET ROOM PARTITIONS							
NTELS/HM FRAMES, DOORS & HARDWARE	0		0			UMBRELLAS							4. UPON TURN
EW CONCRETE FLOOR; PATCH/REPAIR AS REQ'D PERATIONAL SIGNAGE			0	+	CUTTING, PATCHING, REPAIR AND FOR ALL UNDERGROUND NEW WORK CONFIRM ALL LOCATIONS WITH DESIGN MANAGER PRIOR TO INSTALL	WINDOW GRAPHICS  ELECTRICAL					)	AT WINDOWS, PROVIDED BY OWNER SIGNAGE CO.	THOR FINISH
INTING		$\dashv$			CONTINUIALE ECCATIONS WITH BESIGN MANAGENT MONTO INSTALE	BRANCH CIRCUIT BREAKERS	Т				ТТ		ALL DI
ERIMETER WALLS FRAMING/OTHER CONSTRUCT WALL PER CODE			0		EXISTING; GC TO REPLACE WHERE NEEDED	DISTRIBUTION CONDUIT AND WIRING				0		EXISTING SERVICE	5. UPON COORI
OFFIT FRAMING AND GYP. BD.			0			ELECTRICAL SERVICE						EXISTING SERVICE. GC TO COORD. LOCATION OF ALL RECEPT.	
DLID SURFACE COUNTERTOPS PECIALTY CEILINGS AND SOUNDPROOFING					KES TO PROVIDE & INSTALL ALL SOLID-SURFACE COUNTERTOPS UNISTRUT BY GC. GC TO PAINT CLOUDS AND RODS	FIRE ALARM SYSTEM  GENERAL CONDUIT, J-BOXES AND WIRING		0				GC COORD INSTALL W/ALARM PROVIDER & LL REQ FA VENDORS	6. UPON
PRINKLER SYSTEM		+		$\dashv$	N/A	KITCHEN EQUIPMENT UTILITY CONNECTIONS					+		7. SUPER AFTER
TAINLESS STEEL WALL FINISHES					CAULK ALL EDGES WITH STAINLESS STEEL COLORED CAULK	LOW VOLTAGE WIRING		0	0			OWNER PROVIDE CABLES, GC PULLS, OWNER TO FINAL CONNX	8. GC TO
UBSTRATE, INSULATION, SOUNDPROOFING, VAPOR BARRIER AT PERIMETE	R O		0		GC TO EXTEND FINISHES IF EXISTING ARE NOT CONTINUOUS TO DECK	PANELS	0	0		0			ARE C WORK
VALL FINISHES, FRP, TRIM AND SEALERS			0		GC TO PROVIDE 1-GAL. LABELED TOUCH-UP PAINT FOR ALL AREAS	SITE LIGHTING						AC MOTED IN ELECTRICAL DIVIOS	TO TH
VATERPROOFING MEMBRANE ON FLOOR AND UP WALLS  " STAINLESS STEEL BASE AT ALL MILLWORK			0		REFER TO A-121 FINISH SCHEDULE, B2 STAINLESS STEEL WALL BASE	SERVICE CONDUIT AND WIRING TRANSFORMERS						AS NOTED IN ELECTRICAL DWGS  LL TO PROVIDE CONDUIT & WIRING FROM MAIN PANEL TO SPACE	SECUF
XTERIOR WORK					THE ENTIRE STREET SOLVED SEE, BE STREET WHEE BRISE	WIRING DEVICES, RECEPTACLES, SWITCHES, CONTACTORS AND TIMES	s					22 / 0 / 1/0 / 1/2 / 0 / 1/2 / 1/2 /	9. ALL FI PRIOF
LL STRUCTURAL CONCRETE WORK, FOUNDATIONS	00		0		EXIST.; GC TO PATCH AND REPAIR DUE TO DEMO AND NEW WORK	PLUMBING							GC.
LL STRUCTURAL STEEL		_	0		EXIST.; GC TO PROVIDE PER PLANS	DISH TABLES						GC SHALL RECEIVE, UNCRATE & INSTALL	10. THE G
LL STRUCTURAL STEEL FOR INTERIOR AND EXTERIOR/LINTELS  ACK DOOR AND HARDWARE		-	0	+	EXIST. BY LL. PER OWNER SPEC. AS SHOWN ON PLANS, INSULATED	EXTERIOR GREASE INTERCEPTOR  FAUCETS						FIELD VERIFY EXISTING LOCATION PER OWNER SPECIFICATIONS LEVER TYPE, TYP.	OF TH
EM. BD./EXTERIOR GRADE GYP. BD. AT EXTERIOR WALLS/SOFFITS					EXIST. BY LL.; GC TO PROVIDE AS REQ'D	GAS LINE SIZE						FIELD VERIFY EXISTING LOCATION	11. THE S
XTERIOR CONCRETE WORK AND FINISHES (FROST WALLS/SIDEWALK)			0			GAS SERVICE TO SPACE	0		0			FIELD VERIFY EXISTING LOCATION	AS INI
XTERIOR FRAMING, BARRIERS, INSULATION, FLASHING & SEALERS	00	_	0		EXIST.; GC TO PATCH AND REPAIR DUE TO DEMO AND NEW WORK	GREASE WASTE LINE TO SPACE						FIELD VERIFY EXISTING LOCATION & INVERT	12. GC TC
CTERIOR LIGHTING CTERIOR PATIO FOUNDATION & BASE	0				AS SCHEDULED, REFER TO LIGHTING PLAN AND SCHEDULE	INTERIOR GREASE TRAP  KITCHEN EQUIPMENT UTILITY CONNECTIONS							13. GC TC
KTERIOR WALL					EXIST. BY LL. GC CUT/REPAIR/REPLACE AS REQ'D	KITCHEN SINKS						KITCHEN SINKS BY OWNER, INSTALLED BY GC	14. GC TC
CTERIOR WALL FINISHES	00		0			HAND SINKS				0		HAND SINKS FURNISHED BY OWNER, INSTALLED BY GC	AND A
RONT DOOR AND HARDWARE			0		AS REQUIRED DUE TO NEW WORK	MOP SINK		0		0		PER OWNER SPECIFICATIONS	
SULATION, VAPOR BARRIER, FLASHING AT EXTERIOR DEMISING WALLS NTELS/HM FRAMES	0 0	_	0	_	EXISTING	PLUMBING VENT TO SPACE PRESSURE BOOSTER PUMP					+	PROVIDE ONLY IF PRESSURE IS LOWER THAN 60 PSI.	
ODIFIED EXTERIOR PATIO STRUCTURE						RESTROOM LAVATORIES, WATER CLOSETS AND URINALS						PER OWNER SPECIFICATIONS	SHOP
EPAIRS TO CONC. JOINTS LOCATED AT FRONT OR SIDE ENTRY DOORS			0		GC TO PROVIDE AS NEEDED FOR CONCRETE SLAB	SANITARY SEWER TO SPACE						FIELD VERIFY EXISTING LOCATION & INVERT	ITEM CUSTOM KIT
EPAIRS TO EXTERIOR WALL(S)	0		0		GC TO PROVIDE AS NEEDED FOR HOODS	WATER FILTERS AND EQUIPMENT				0		FURNISHED BY KES	
OOF LADDER		_	0		5//07 00 TO PROVIDE 40 PEOID	WATER HEATER, HEATER ALARM AND INTAKE/EXHAUST FLUE PIPE		0				PER OWNER SPECIFICATIONS	DOOR HARD
DE DOOR AND HARDWARE PANDREL GLASS		+		-	EXIST.; GC TO PROVIDE AS REQ'D.  EXISTING	WATER SERVICE TO SPACE  MECHANICAL					1 1	FIELD VERIFY EXISTING LOCATION	EXTERIOR S
FOREFRONT AND GLAZING		+			EXISTING	CAPTURE SHROUDS	П				ТТ		FIRE ALARM
CK UP WINDOW						DUCTWORK AND AIR DISTRIBUTION		0				PER OWNER SPECIFICATIONS	FIRE SPRIN
BSTRATE MESH OPENING						EXHAUST FANS AND CURBS		0					LIGHTING PA
OOF WORK OSING ALL EXISTING NON-USED ROOF PENETRATIONS		T		T	GC TO CAP & COORDINATE WORK	EXHAUST DUCTWORK  KITCHEN EQUIPMENT UTILITY CONNECTIONS	+			) )		PER OWNER SPECIFICATIONS PER OWNER SPECIFICATIONS	MECHANICA MILLWORK I
JRB ADAPTERS		+		+	IF REQUIRED, AT TENANTS EXPENSE	MAIN SPRINKLER SERVICE	$\dashv$	0			++		-
TERIOR ROOF HATCH AND LADDER WITH LOCK					·	MAKE-UP AIR UNIT AND CURB		0					PLUMBING STOREFRO
EW ADDITIONAL AND ALTERATIONS TO EXISTING ROOF PENETRATIONS	0		0		AT TENANTS EXPENSE	ROOFTOP UNITS AND CURBS		0				PER OWNER SPECIFICATIONS	STRUCTUR
W ROOF PENETRATIONS/CURB CUTS			0		COORDINATE WITH LL REQUIRED SUBS	SPRINKLER SYSTEM DISTRIBUTION MODIFICATIONS		0		0	11	DED OWNED ODEOLEIED BY VENDOD	WALKIN CC
DOF DECK, INSULATION, ROOFING JOINTS AND FLASHING DOF DRAINS/GUTTERS			10	$\perp$	EXISTING	TEST, BALANCE AND REPORT THERMOSTATS AND TEMPERATURE SENSORS	+			) )		PER OWNER SPECIFIED BY VENDOR PER OWNER SPECIFICATIONS	
OOFTOP SCREENING FOR ROOF EQUIPMENT		$\dashv$		+	GC TO COORDINATE W/ LL. & OWNER CM. IF SCREENING REQ'D.	UTILITIES TO RTU UNITS	+				++	LECTIVITE OF EATHORIUM	1
RUCTURAL DESIGN, STEEL AND CONSTRUCTION FOR ALL ROOF WORK					EXIST.; WHERE REQ'D DUE TO NEW WORK AT TENANTS EXPENSE	UNIT HEATERS							1
TRUCTURAL DRAWINGS FOR RTU'S/FANS/CONDENSERS ON ROOF		0			BY OWNER AT OWNER EXPENSE	TYPE II EXHAUST HOOD						PER OWNER SPECIFICATIONS	4
													1
													1
													1
													1
						Ī							4

- GC TO DISCLOSE TO OWNER ANY DEFICIENCIES IN THE PLANS AND SPECIFICATIONS OF WHICH HE/SHE HAS KNOWLEDGE AND WHICH WOULD PREVENT CONSTRUCTION OF THE PROJECT IN CONFORMANCE WITH ANY APPLICABLE LAWS, REGULATIONS OR CODES, OR IN A GOOD WORKMANLIKE MANNER.
- GC SHALL PROVIDE ALL LABOR & MATERIALS FOR FINAL ELECTRICAL CONNECTION FOR SIGNAGE. ALL ROOF PENETRATIONS AND RE-ROOF WORK (IF REQUIRED FOR SIGNAGE INSTALLATION) SHALL BE BY GC. GC SHALL INSTALL AND HAVE COMPLETED AND IN PLACE ALL BLOCKING, BACKING, SUPPORTS, ELECTRICAL AND EIFS WALL FINISHES, ETC. ELEMENTS FOR ALL EXTERIOR SIGNAGE NO LATER THAN 15 CALENDAR DAYS AFTER PROJECT COMMENCEMENT AND ALL INTERIOR SIGNAGE NO LATER THAN 10 CALENDAR DAYS PRIOR TO CONSTRUCTION TURNOVER TO OWNER OPERATIONS. GC TO COORDINATE W/ OWNER SIGN COMPANY TO ACCOMMODATE SIGN INSTALLS
- 3. GC RESPONSIBLE FOR ALL EQUIPMENT/WALK-IN-COOLER/HOODS/FIXTURE/SIGNAGE. FINAL CONNECTIONS ON WATER, GAS, ELECTRICAL, PHONES, CONDENSATE, FLOOR/HUB DRAINS-FLOOR SINKS (FOR ALL FIXTURES/EQUIPMENT AND OPENINGS), & ALL ROOFTOP EQUIPMENT (RTU'S).
- 4. GC SHALL INCLUDE AND PROVIDE ALL ELECTRICAL, ELECTRICAL WIRING, GAS, GAS PIPING, DEVICES, HOSES, WATER, WATER PIPING, ETC. ALL INCLUSIVE FOR ALL OWNER SUPPLIED EQUIP.
- 5. GC TO PROVIDE ALL TEMPORARY UTILITY SERVICES DURING CONSTRUCTION. AOR TO COORDINATE W/ SPECIFICATIONS; SWEETGREEN TO VERIFY SPECIFICATIONS.
- CC TO INCLUDE IN DID AND LICE ANY LANDLORD DECICNATED CONTRACTORS
- 6. GC TO INCLUDE IN BID AND USE ANY LANDLORD DESIGNATED CONTRACTORS.
- GC TO CONTACT LL REGARDING LL REQUIRED SUBS.
- ALL FLOORS, WALLS, CEILINGS AND FIXTURES IN KITCHEN OR SERVICE AREAS SHALL BE CONSTRUCTED FROM MATERIALS THAT ARE SMOOTH, DURABLE, EASILY CLEANABLE AND NON-ABSORBENT.
- LANDLORD (LL) REFERS TO THE PROPERTY OWNER OR PROPERTY MANAGER.
- OWNER OR TENANT REFERS TO SWEETGREEN.
- GC REFERS TO OWNER CONTRACTED GENERAL CONTRACTOR.
- GC SHALL CONFIRM WITH OWNER/LANDLORD IF FIRE ALARM SYSTEM IS REQUIRED PRIOR TO START OF CONSTRUCTION. SPECIFIC QUESTIONS/COORDINATION WITH OWNER REQUIREMENTS SHALL BE DIRECTED TO FIRE SYSTEM ENGINEER.
- ANY ITEMS LISTED IN THE DRAWINGS BUT NOT IDENTIFIED IN THIS SCHEDULE ARE TO BE FURNISHED AND INSTALLED BY GC.

## **TURNOVER REQUIREMENTS**

- PRIOR TO THE STORE OPENING, THE GC SHALL PROVIDE (1) ONE (10) YARD RECYCLING CONTAINER FOR REMOVAL OF ALL PACKING MATERIALS RELATED TO TENANT FURNISHINGS. QUANTITY MAY VARY BASED ON SCOPE AND SIZE OF PROJECT, COORDINATE WITH PROJECT MANAGER.
- 2. THE GC SHALL COMPLETE ALL REQUIRED INSPECTIONS BY CONSTRUCTION COMPLETION DATE AND WILL FURNISH THE STORE MANAGER WITH THE CERTIFICATE OF OCCUPANCY. IN ADDITION, THE GC SHALL PROVIDE A LIST OF THE NAMES, ADDRESSES AND TELEPHONE NUMBERS OF ALL SUBCONTRACTORS. BOTH OF THESE ITEMS SHALL BE MOUNTED IN SEPARATE LETTER SIZED PICTURE FRAMES, WITHIN THE MANAGERS OFFICE. THE GC SHALL SEND A COPY OF BOTH OF THESE ITEMS TO THE PROJECT MANAGER.
- 3. THE GC SHALL TURN OVER (10) TEN COPIES OF ALL KEYS TO THE PROJECT MANAGER PRIOR TO PUNCH WALK. GC TO COORDINATE EXACT TIME TO SURRENDER POSSESSION OF PREMISES TO THE PROJECT MANAGER. EACH KEY SHALL BE CLEARLY MARKED FOR IDENTIFICATION.
- 4. UPON COMPLETION OF THE WORK, THE GC SHALL PROVIDE TWO (2) FINAL CLEANINGS PRIOR TO PUNCH AND TURNOVER TO BE PERFORMED BY A PROFESSIONAL CLEANING SERVICE. THE ENTIRE STORE SHALL BE THOROUGHLY CLEANED BEFORE TURNOVER. CLEANING TO INCLUDE ALL FLOORS, GLAZING, STOREFRONT, FINISHED SURFACES, KITCHEN EQUIPMENT, LIGHT FIXTURES AND MECHANICAL SUPPLY AND RETURN GRILLES. ALL DRAINS SHOULD ALSO BE FLUSHED.
- 5. UPON COMPLETION OF THE WORK, THE GC SHALL WATER JET AND CAMERA ALL WASTE LINES. GC TO COORDINATE AND PROVIDE RESULTS TO SG CPM.
- 6. UPON COMPLETION OF THE WORK, THE GC SHALL PROVIDE NEW AIR FILTERS IN ALL HVAC UNITS.
- 7. SUPERINTENDENT MUST REMAIN ON JOB SITE THROUGH COMPLETION OF THE PUNCH LIST AND ONE (1) WEEK AFTER TURNOVER.
- 8. GC TO SCHEDULE, COORDINATE, AND SUPERVISE ALL SG VENDORS TO ENSURE SG VENDOR SCOPE OF WORK ARE COMPLETED PER PLAN AND SUPPORT THE CONSTRUCTION SCHEDULE. UPON COMPLETION OF THE WORK, THE GC TO COORDINATE WITH ALL SG VENDORS AND DEMONSTRATE THE OPERATION OF ALL SYSTEMS TO THE STORE AND FACILITY MANAGERS. THIS INCLUDES ELECTRICAL, MECHANICAL, PLUMBING, SOUND, AND SECURITY ITEMS
- . ALL FLOOR FIXTURES, FURNITURE, EQUIPMENT AND HARDWARE TO BE UNBOXED AND POSITIONED PER PLANS PRIOR TO PUNCH LIST WALKTHROUGH. FIXTURES WHICH REQUIRE ASSEMBLY ARE TO BE COMPLETED BY THE GC
- 10. THE GC SHALL COORDINATE A WALK THROUGH WITH THE LANDLORD REPRESENTATIVE AND OBTAIN A SIGNATURE INDICATING COMPLETION AND ACCEPTANCE. SIGNED DOCUMENT SHALL BE SUBMITTED AS PART OF THE PROJECT CLOSEOUT PACKAGE, IF REQUIRED BY LEASE.
- 11. THE SITE SUPERINTENDENT IS TO TAKE COMPREHENSIVE PHOTOS OF STORE PRIOR TO LEAVING THE JOBSITE AS INDICATED IN THE GC PROJECT MANUAL.
- 12. GC TO PROVIDE RED LINE AS-BUILTS IN CONFORMANCE WITH CLOSE OUT REQUIREMENTS.
- GC TO COORDINATE 11 MONTH WARRANTY WALK.
- I. GC TO PROVIDE TURNOVER BINDER AT TURNOVER DATE. ONE (1) HARDCOPY LEFT ON SITE TO OPERATIONS AND AN ELECTRONIC COPY SENT TO THE CM/CC.

## HOP DRAWING SUBMITTAL & RESPONSIBILITY

	ITEM	TO SUBMIT	TO REVIEW	TO APPROVE	NOTES
	CUSTOM KITCHEN EQUIPMENT	KES	ARCH	DESIGN	SINGER/EVI TO PROVIDE SHOP DRAWINGS FOR REVIEW
	DOOR HARDWARE	GC	ARCH	ARCH	
	ELECTRICAL PANEL	GC	ARCH	ENG	
	EXTERIOR SIGNAGE	SIGNAGE VENDOR	ARCH	DESIGN	UNDER SEPARATE PERMIT BY VENDOR
	FIRE ALARM	GC	ENG	-	GC TO SUBMIT UNDER SEPARATE PERMIT
	FIRE SPRINKLER	GC	ENG	-	GC TO SUBMIT UNDER SEPARATE PERMIT
	LIGHTING PACKAGE	LIGHTING VENDOR	CONST	CONST	CAPITOL LIGHTING TO PROVIDE SHOP DRAWINGS FOR FIXTURES AND CONTROL
	MECHANICAL PACKAGE	GC	ARCH	ENG	
	MILLWORK PACKAGE	MILLWORK VENDOR	DESIGN	ARCH	DIGIFAB TO PROVIDE SHOP DRAWINGS FOR REVIEW
_	PLUMBING	GC	ARCH	ENG	
_	STOREFRONT	GC	DESIGN	ARCH	
	STRUCTURAL STEEL	GC	ARCH	ARCH	
	WALKIN COOLER	KES	DESIGN	ARCH	SINGER/EVI TO PROVIDE SHOP DRAWINGS FOR REVIEW



## sweetgreen

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ARCHITECT OF RECORD:



NOR LIABILITY TO THE OTHER (EXCEPT AS STATED ABOVE)

UNTIL A WRITTEN AGREEMENT IS FULLY EXECUTED.

Dewberry Architects Inc.

300 N. Lake Ave, 12th Floor Pasadena, Ca. 91101 916.239.4256 Phone 916.239.7245 Fax

MP:

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ROJECT INFORMATION:
556 N DECATUR RD,

DRAWN BY: TF
CHECKED BY: JW
PROJECT MANAGER: ZM
SG DESIGN MANAGER: LG
SG CONSTR. MANAGER: JD
PROJECT NO: 50139167

05.06.2022

REVISIONS
REV. DATE DESCRIPTION

TEMPLATE VERSION:

RESPONSIBILITY MATRIX

1556 N. DECATUR ROAD EMORY VILLAGE, LLC 856-359-5312

G-300

## EXISTING STOREFRONT TO BE DEMOLISHED T.O. ROOF EL. = 13' - 3" - FABRIC TO BE REPLACED ON EXISTING AWNING. T.O. DOOR EL. = 7' - 0" EXISTING RAILING TO BE REMOVED DEMO EXTERIOR ELEVATION - SOUTH

## **GENERAL NOTES**

- . DEMOLISHED MATERIALS SHALL BECOME THE GENERAL CONTRACTOR'S PROPERTY AND SHALL BE REMOVED FROM THE SITE WITH FURTHER DISPOSITION AND RECYCLED BY THE GENERAL CONTRACTOR'S OPTION AND AS PER THE GOVERNING AGENCY REQUIREMENTS, UNLESS OTHERWISE INSTRUCTED BY TENANT.
- SURVEY THE CONDITION OF THE BUILDING TO DETERMINE WHETHER REMOVING ANY ELEMENT MIGHT RESULT IN STRUCTURAL OR ACOUSTICAL DEFICIENCY; CONTACT PROJECT MANAGER BEFORE PROCEEDING AT THESE
- MAINTAIN EXISTING UTILITIES TO REMAIN IN SERVICE AND PROTECT THEM AGAINST DAMAGE DURING SELECTIVE DEMOLITION OPERATIONS. CAP UNUSED UTILITIES AND CONCEAL BEHIND FINISHED SURFACES.
- PROVIDE TEMPORARY WEATHER PROTECTION, DURING INTERVAL BETWEEN DEMOLITION, REMOVAL OF EXISTING EXTERIOR CONSTRUCTION AND NEW CONSTRUCTION TO ENSURE THAT NO WATER DAMAGE OCCURS TO STRUCTURE OR INTERIOR AREAS.
- E. TOTAL SCOPE OF DEMOLITION MAY NOT BE COVERED ON THIS SHEET. REVIEW ALL SHEETS IN THIS DRAWING SET TO DETERMINE TOTAL SCOPE OF DEMOLITION.
- IN INSTANCES WHERE EXISTING EQUIPMENT, MILLWORK, PIPING, DUCTS, ETC. ARE REQUIRED TO BE REMOVED, SUCH REMOVAL IS TO INVOLVE ALL ASSOCIATED HANGERS, ANCHORS AND BLOCKING.
- G. ALL DEMOLITION ITEMS ON THIS SHEET TO BE PERFORMED BY TENANT'S GENERAL CONTRACTOR, U.N.O.
- H. COORDINATE ALL DEMOLITION ACTIVITY WITH BUILDING OWNER'S REPRESENTATIVE. SOME DEMOLITION ACTIVITIES MAY BE REQUIRED TO BE PERFORMED ON PREMIUM TIME.

MAINTAIN EXISTING SPRAY-ON FIREPROOFING OF EXISTING STRUCTURE AND FIRE RATED ASSEMBLIES. ANY COMPROMISE OF EXISTING FIRE RATING SHALL BE PATCHED AND REPAIRED TO ORIGINAL CONDITION.

ANY EXISTING FINISHED SURFACES TO REMAIN THAT ARE AFFECTED BY SELECTIVE DEMOLITION SHALL BE PATCHED TO MATCH EXISTING ADJACENT SURFACES UNLESS CONCEALED BY NEW CONSTRUCTION.

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STAMP:

XX.XX.XXXX

## **LEGEND**

**CODED NOTES** 

EXISTING CONSTRUCTION TO REMAIN

EXISTING CONSTRUCTION TO BE DEMOLISHED

EXISTING CASEWORK / FURNITURE/STOREFRONT TO BE DEMOLISHED

EXISTING DUCTS TO BE DEMOLISHED

DEC/ Z 556 DRAWN BY:

ATUR RD,

CHECKED BY: PROJECT MANAGER: SG DESIGN MANAGER: SG CONSTR. MANAGER: PROJECT NO: TEMPLATE VERSION:

REVISIONS REV. DATE


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05.06.2022

**DEMO STOREFRONT ELEVATIONS** 

> 1556 N. DECATUR ROAD EMORY VILLAGE, LLC 856-359-5312

> > **D-010**

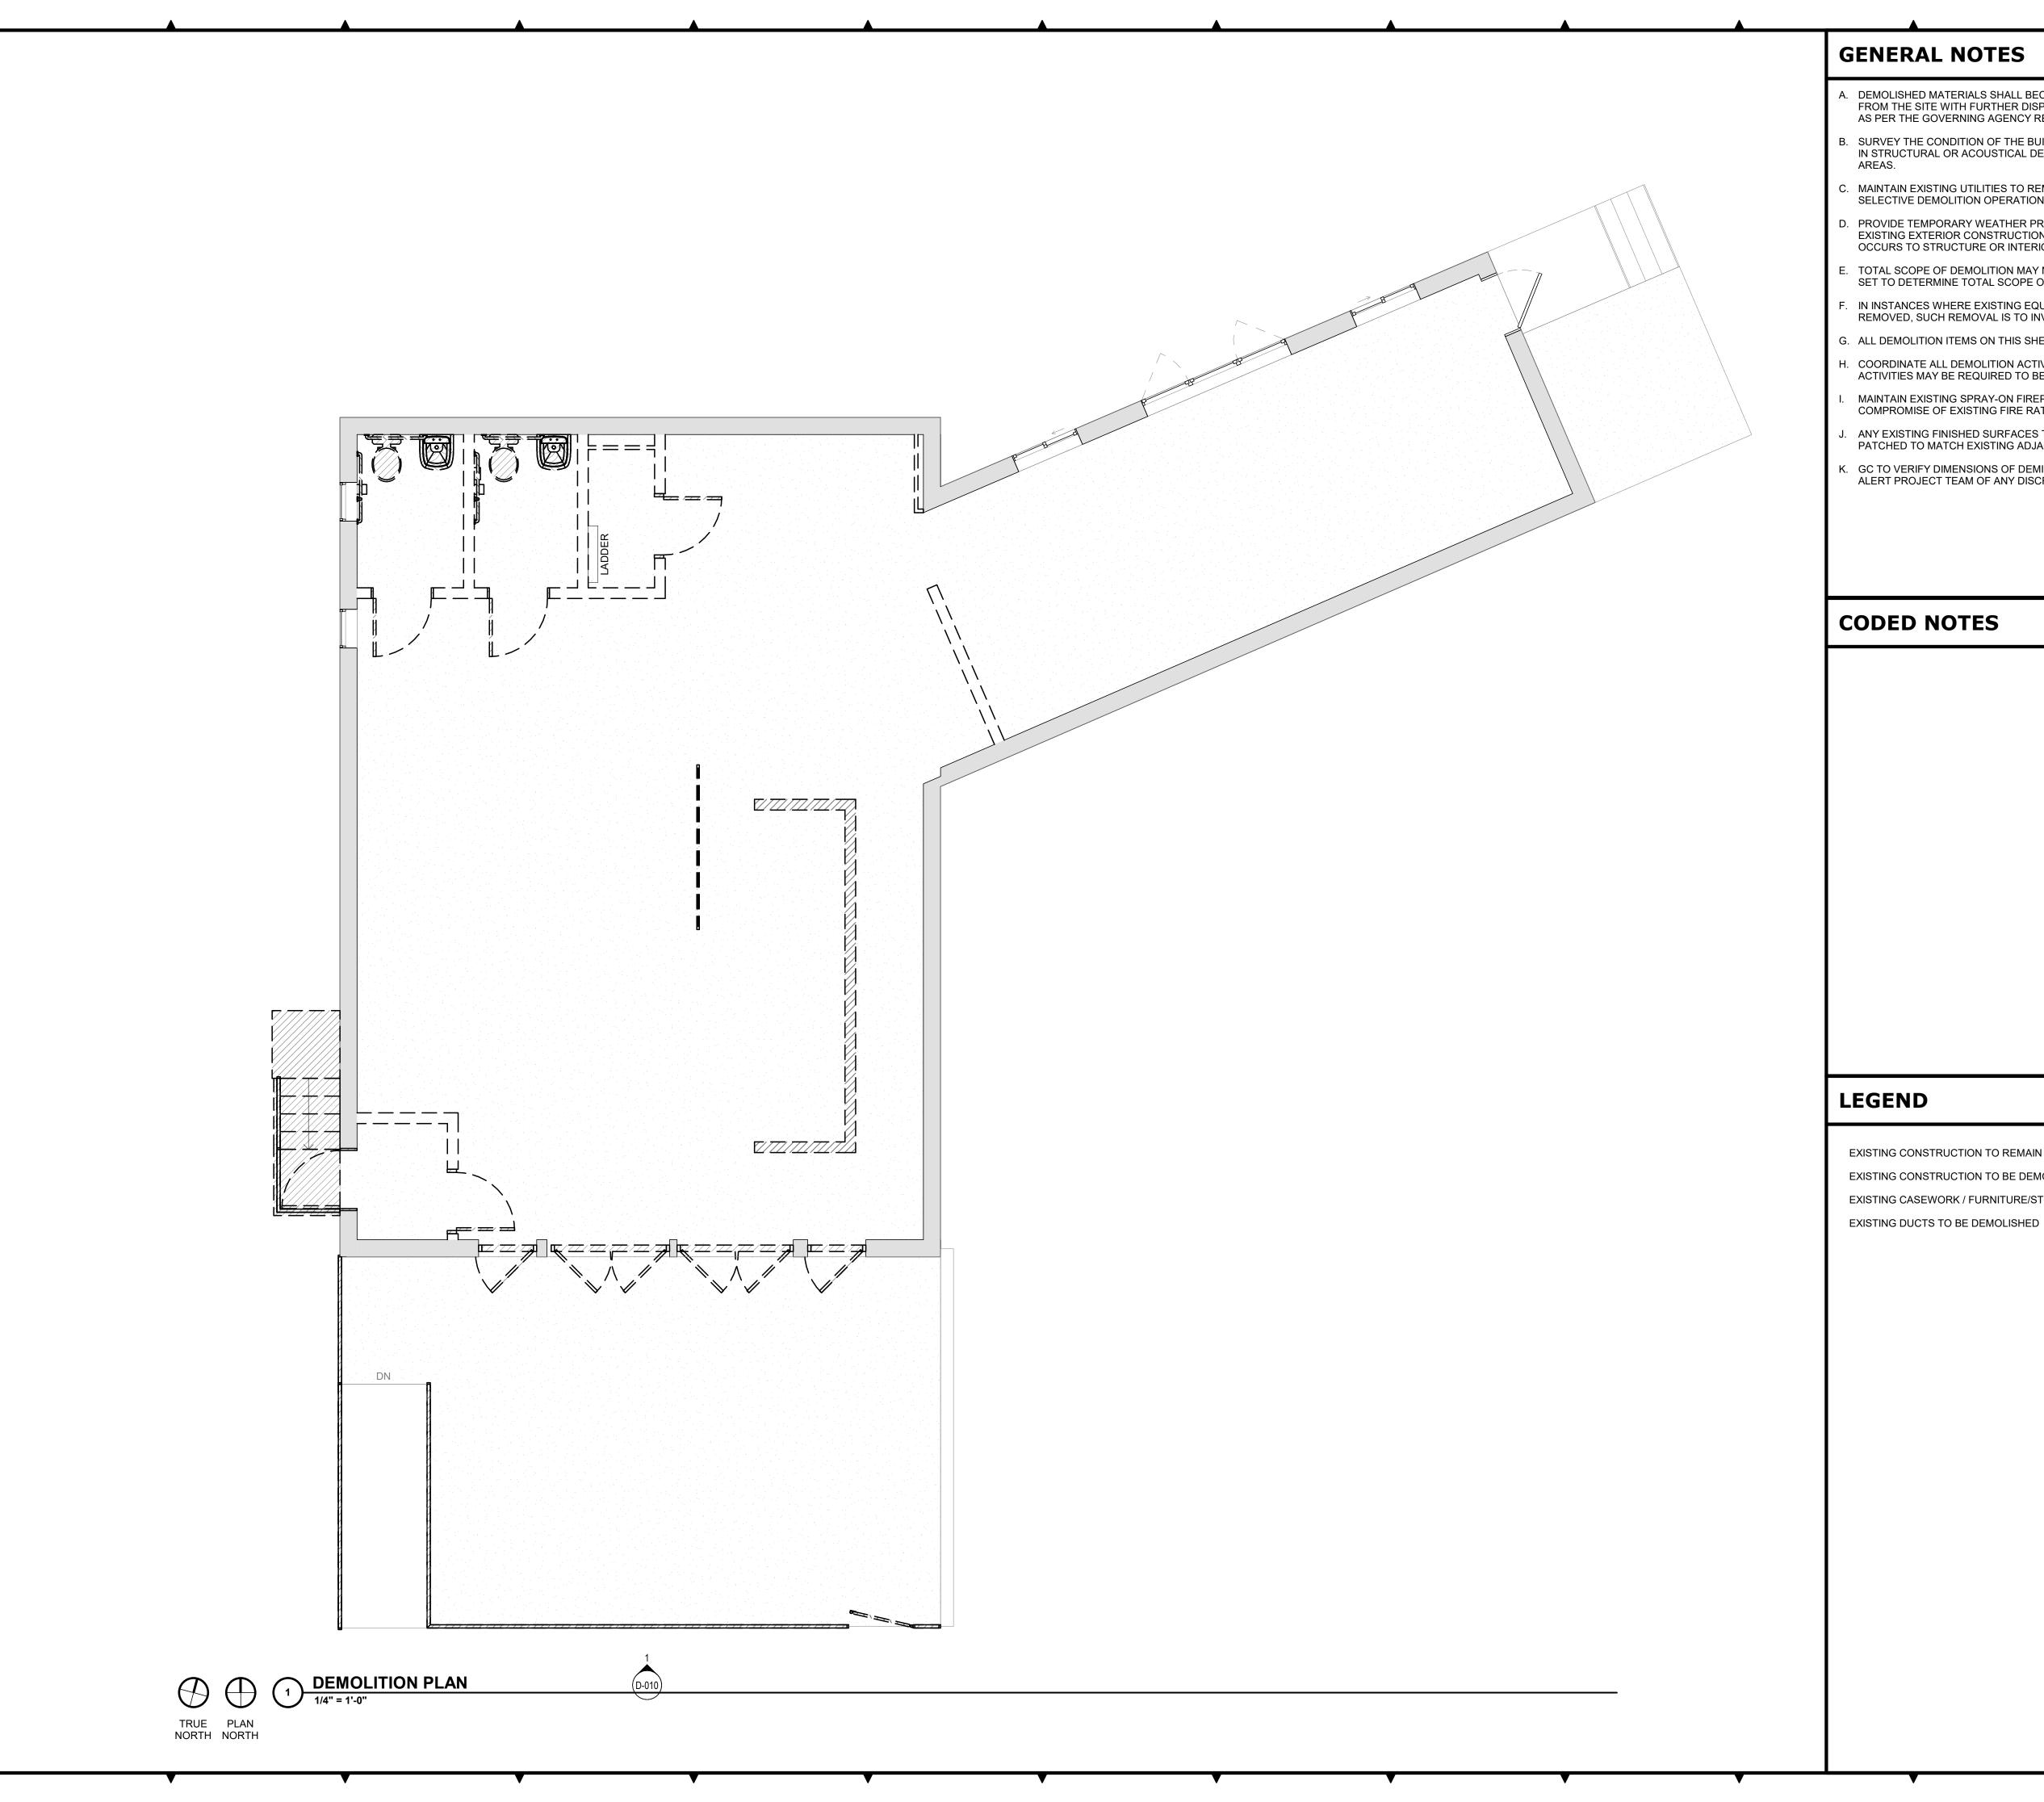

- A. DEMOLISHED MATERIALS SHALL BECOME THE GENERAL CONTRACTOR'S PROPERTY AND SHALL BE REMOVED FROM THE SITE WITH FURTHER DISPOSITION AND RECYCLED BY THE GENERAL CONTRACTOR'S OPTION AND AS PER THE GOVERNING AGENCY REQUIREMENTS, UNLESS OTHERWISE INSTRUCTED BY TENANT.
- B. SURVEY THE CONDITION OF THE BUILDING TO DETERMINE WHETHER REMOVING ANY ELEMENT MIGHT RESULT IN STRUCTURAL OR ACOUSTICAL DEFICIENCY; CONTACT PROJECT MANAGER BEFORE PROCEEDING AT THESE
- MAINTAIN EXISTING UTILITIES TO REMAIN IN SERVICE AND PROTECT THEM AGAINST DAMAGE DURING SELECTIVE DEMOLITION OPERATIONS. CAP UNUSED UTILITIES AND CONCEAL BEHIND FINISHED SURFACES.
- PROVIDE TEMPORARY WEATHER PROTECTION, DURING INTERVAL BETWEEN DEMOLITION, REMOVAL OF EXISTING EXTERIOR CONSTRUCTION AND NEW CONSTRUCTION TO ENSURE THAT NO WATER DAMAGE OCCURS TO STRUCTURE OR INTERIOR AREAS.
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- ANY EXISTING FINISHED SURFACES TO REMAIN THAT ARE AFFECTED BY SELECTIVE DEMOLITION SHALL BE
- PATCHED TO MATCH EXISTING ADJACENT SURFACES UNLESS CONCEALED BY NEW CONSTRUCTION.
- GC TO VERIFY DIMENSIONS OF DEMISED PREMISES, INCLUDING LOCATIONS OF ALL EXISTING CONDITIONS. ALERT PROJECT TEAM OF ANY DISCREPANCIES PRIOR TO LAYOUT.

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XX.XX.XXXX

EXISTING CONSTRUCTION TO REMAIN EXISTING CONSTRUCTION TO BE DEMOLISHED EXISTING CASEWORK / FURNITURE/STOREFRONT TO BE DEMOLISHED 

> DRAWN BY: PROJECT MANAGER: SG DESIGN MANAGER: SG CONSTR. MANAGER:

TEMPLATE VERSION: 05.06.2022

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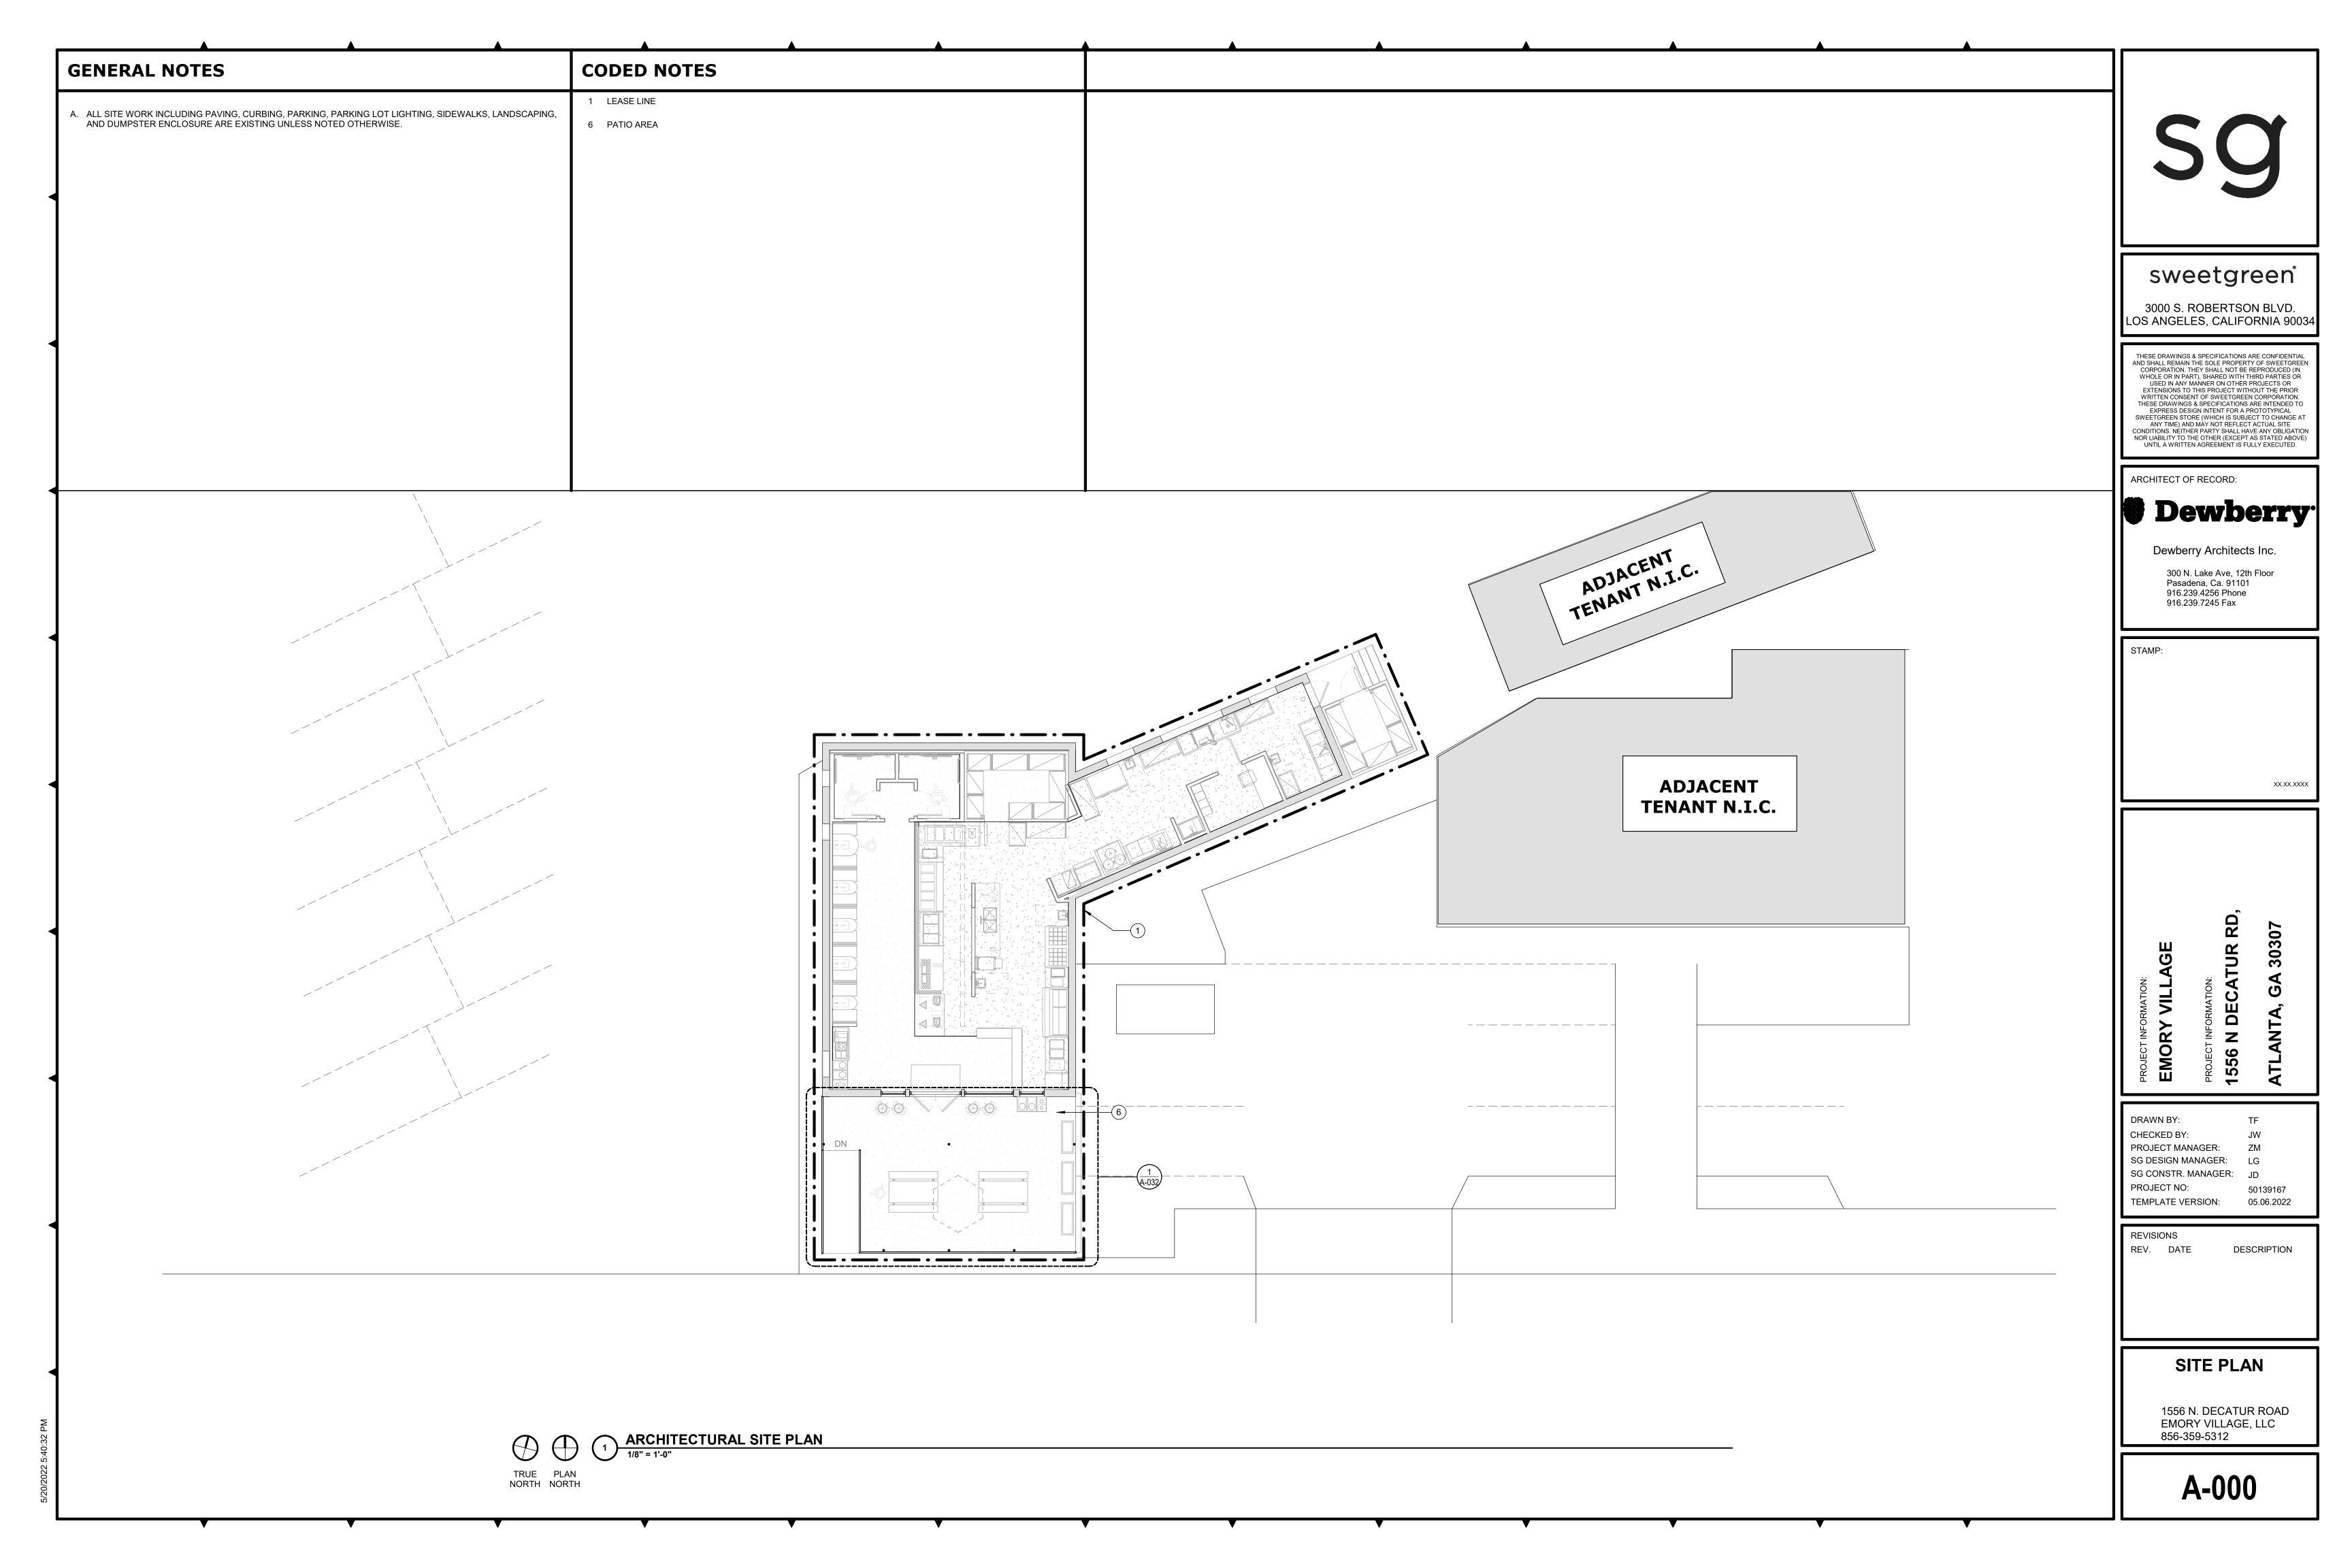
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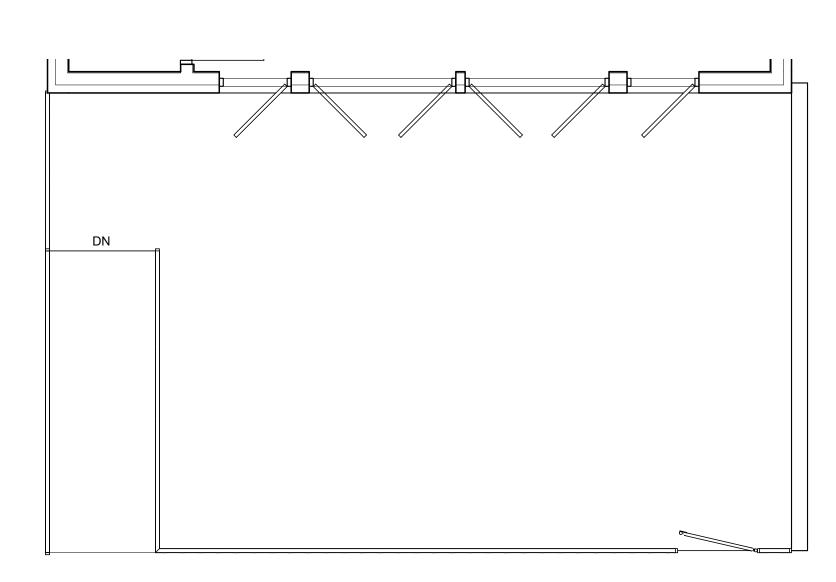
## **DEMOLITION PLAN**

1556 N. DECATUR ROAD EMORY VILLAGE, LLC 856-359-5312

**D-100** 



UPDATE BULKHEAD SECTION TO MATCH SITE CONDITIONS. CONSULT WITH — EXISTING BULKHEAD STRUCTURAL ENGINEER REGARDING ATTACHMENTS AND EXISTING BUILKHEAD CONDITIONS. - HEAD ANCHORAGE: MASONARY: 3/8" DIA. HILTI SLEEVE ANCHOR @ 16" O.C. STEEL LINTEL: TACK WELD OR 0.205" DIA. PAF @ 16" O.C. EXTERIOR (2) 1/4" DIA. TEK SCREWS @ 16" O.C. MTL. STUDS )(2) 1/4" DIA. TEK SCREWS @ 16" O.C. - GC TO PROVIDE AND INSTALL EXTERIOR GRADE PLYWOOD LID OVER METAL STUDS (SIZE AND SPACING TO MATCH BARRICADE WALLS). SECURE EXISTING BULKHEAD. AFTER REMOVAL OF SUPPORTS PATCH EXISTING BUILKHEAD TO MATCH EXISTING (3) #10 SCREWS — 3 5/8" X 18 GA. METAL STUDS AT 16" O.C. (USE 6" X 18 GA. METAL STUDS IF BARRICADE IS TALLER THAN 12'-6") WITH 1/2" TYP A/B EXTERIOR GRADE PLYWOOD (SMOOTH SIDE ON EXTERIOR) — LEASE LINE - PROVIDE INSULATION AS NECESSARY PER LOCAL CLIMATE CONDITIONS — 3 5/8" X 18 GA. METAL STUD BRACE AT 48" O.C. WITH (4) #8 SCREWS AT EACH END — CONT. 3 5/8" X 18 GA. STUD W/ (2) #10 SCREWS EACH LEG - ATTACH PLYWOOD TO BOTTOM TRACK OF BARRICADE AND USE BALLAST (100 PSF WEIGHT) ON PLYWOOD BASE TO ANCHOR BARRICADE TO SIDEWALK. G.C. TO ENSURE PROTECTIVE MATERIAL BETWEEN BOTTOM OF BARRICADE AND SIDEWALK TO PREVENT DAMAGE DURING CONSTRUCTION FROM PROPERTY LINE 3 5/8" X 18 GA. METAL STUDS AT 16" O.C. WITH 1/2" PLYWOOD 3 STOREFRONT BARRICADE - EXTERIOR NTS



CONSTRUCTION BARRICADE PLAN

1/4" = 1'-0"

Sg

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PROJECT INFORMATION:

556 N DECATUR RD,

DRAWN BY: Author
CHECKED BY: Checker
PROJECT MANAGER: ZM
SG DESIGN MANAGER: LG
SG CONSTR. MANAGER: JD
PROJECT NO: 50139167
TEMPLATE VERSION: 05.06.2022


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DESCRIPTION

BARRICADE PLANS, ELEVATIONS & DETAILS

Δ\_020

1556 N. DECATUR ROAD EMORY VILLAGE, LLC 856-359-5312

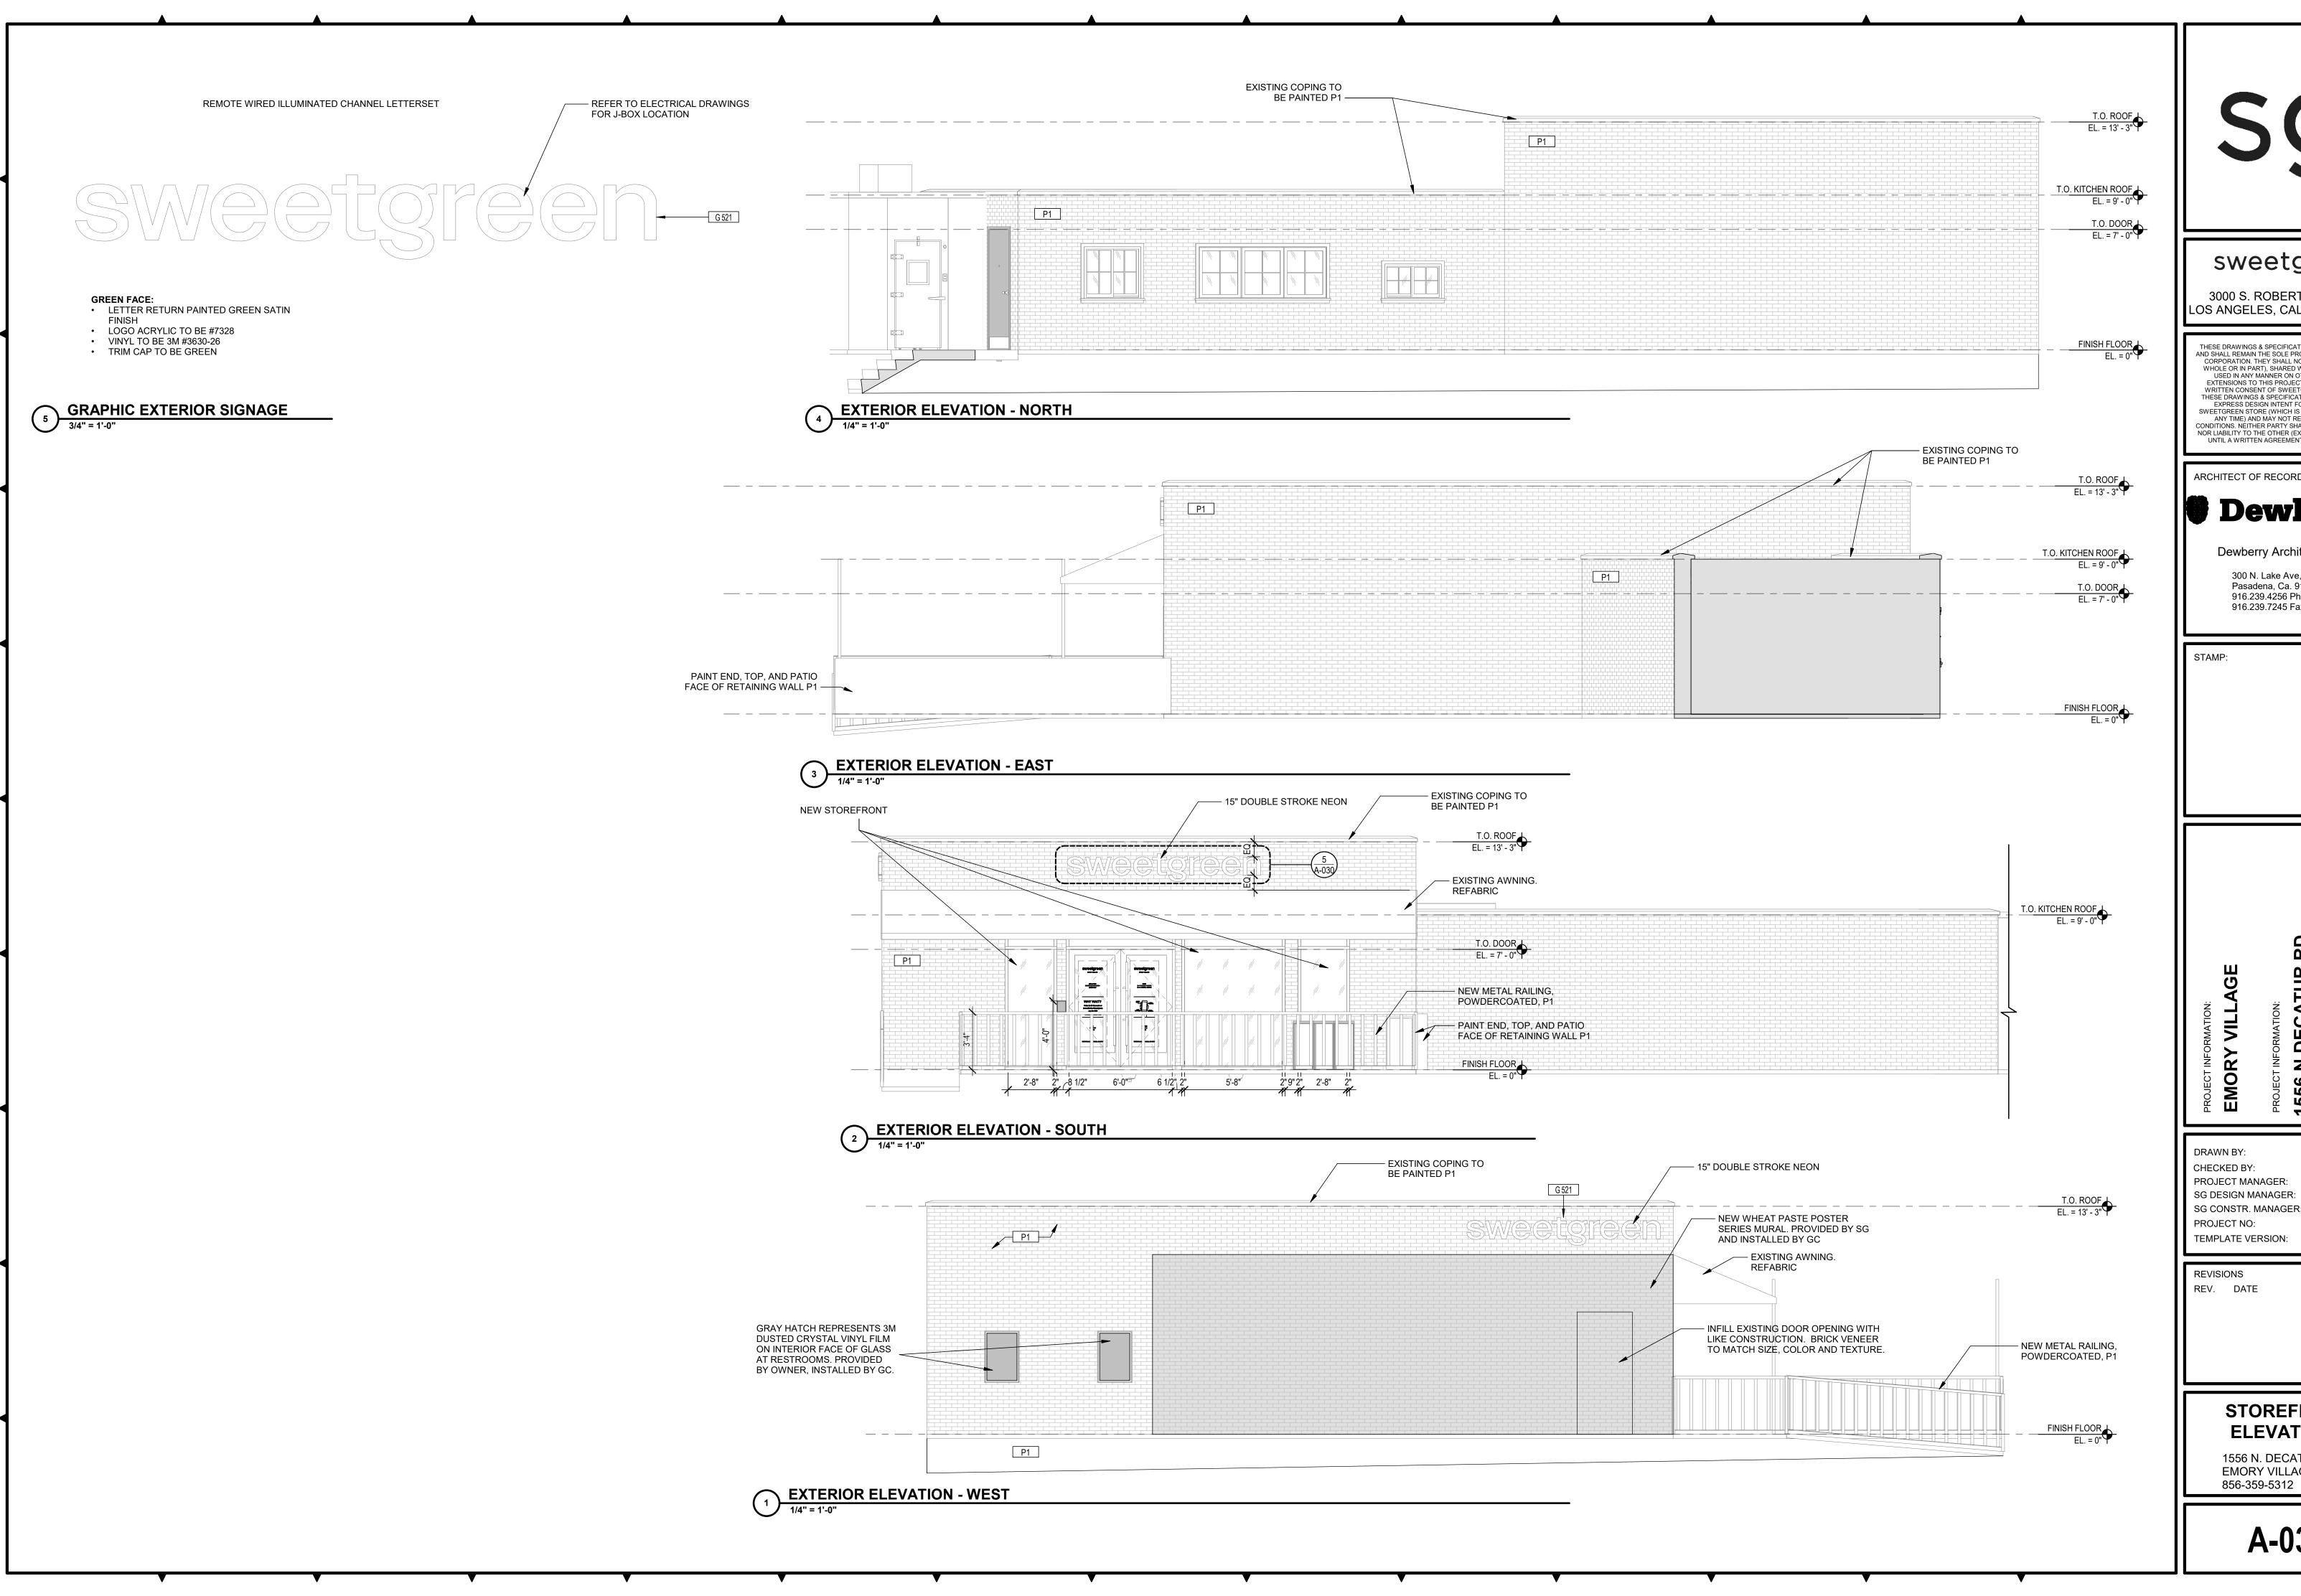

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ARCHITECT OF RECORD:

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300 N. Lake Ave, 12th Floor Pasadena, Ca. 91101 916.239.4256 Phone 916.239.7245 Fax

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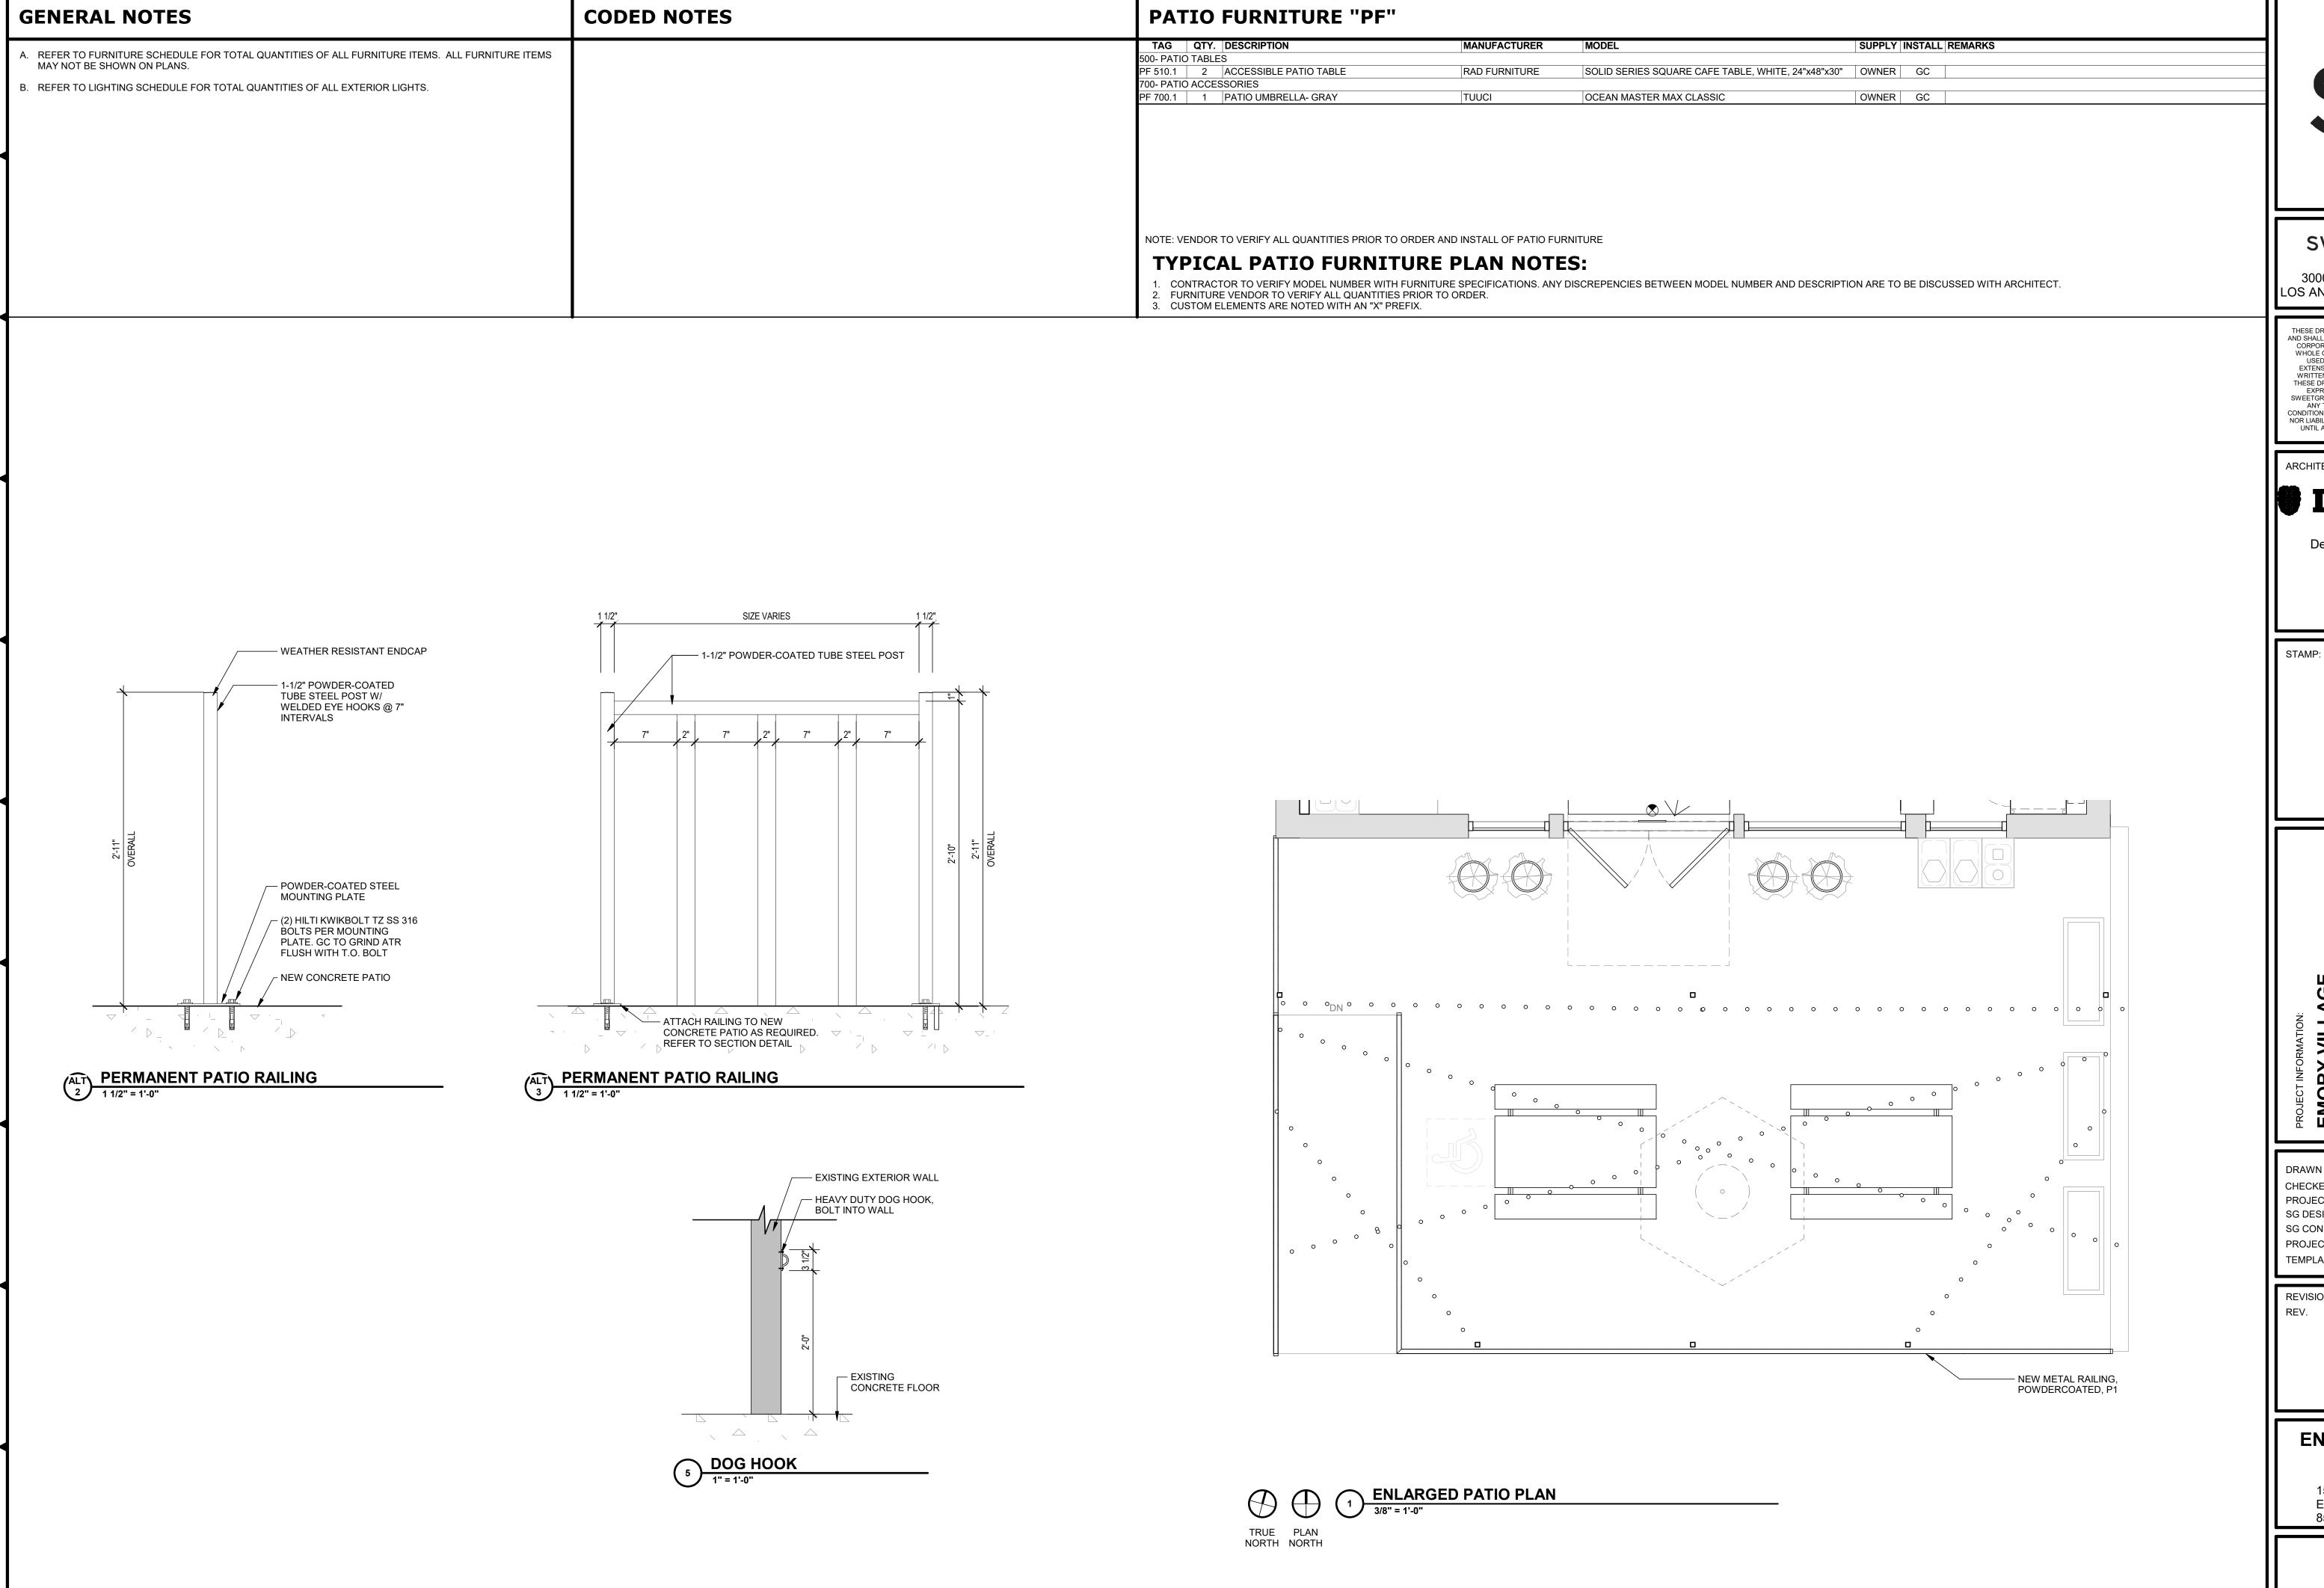
PROJECT MANAGER: SG DESIGN MANAGER: SG CONSTR. MANAGER: PROJECT NO: 50139167 05.06.2022

REVISIONS

DESCRIPTION

STOREFRONT **ELEVATIONS** 

1556 N. DECATUR ROAD EMORY VILLAGE, LLC 856-359-5312



## sweetgreen

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XX.XX.XXXX

DEC/ 556

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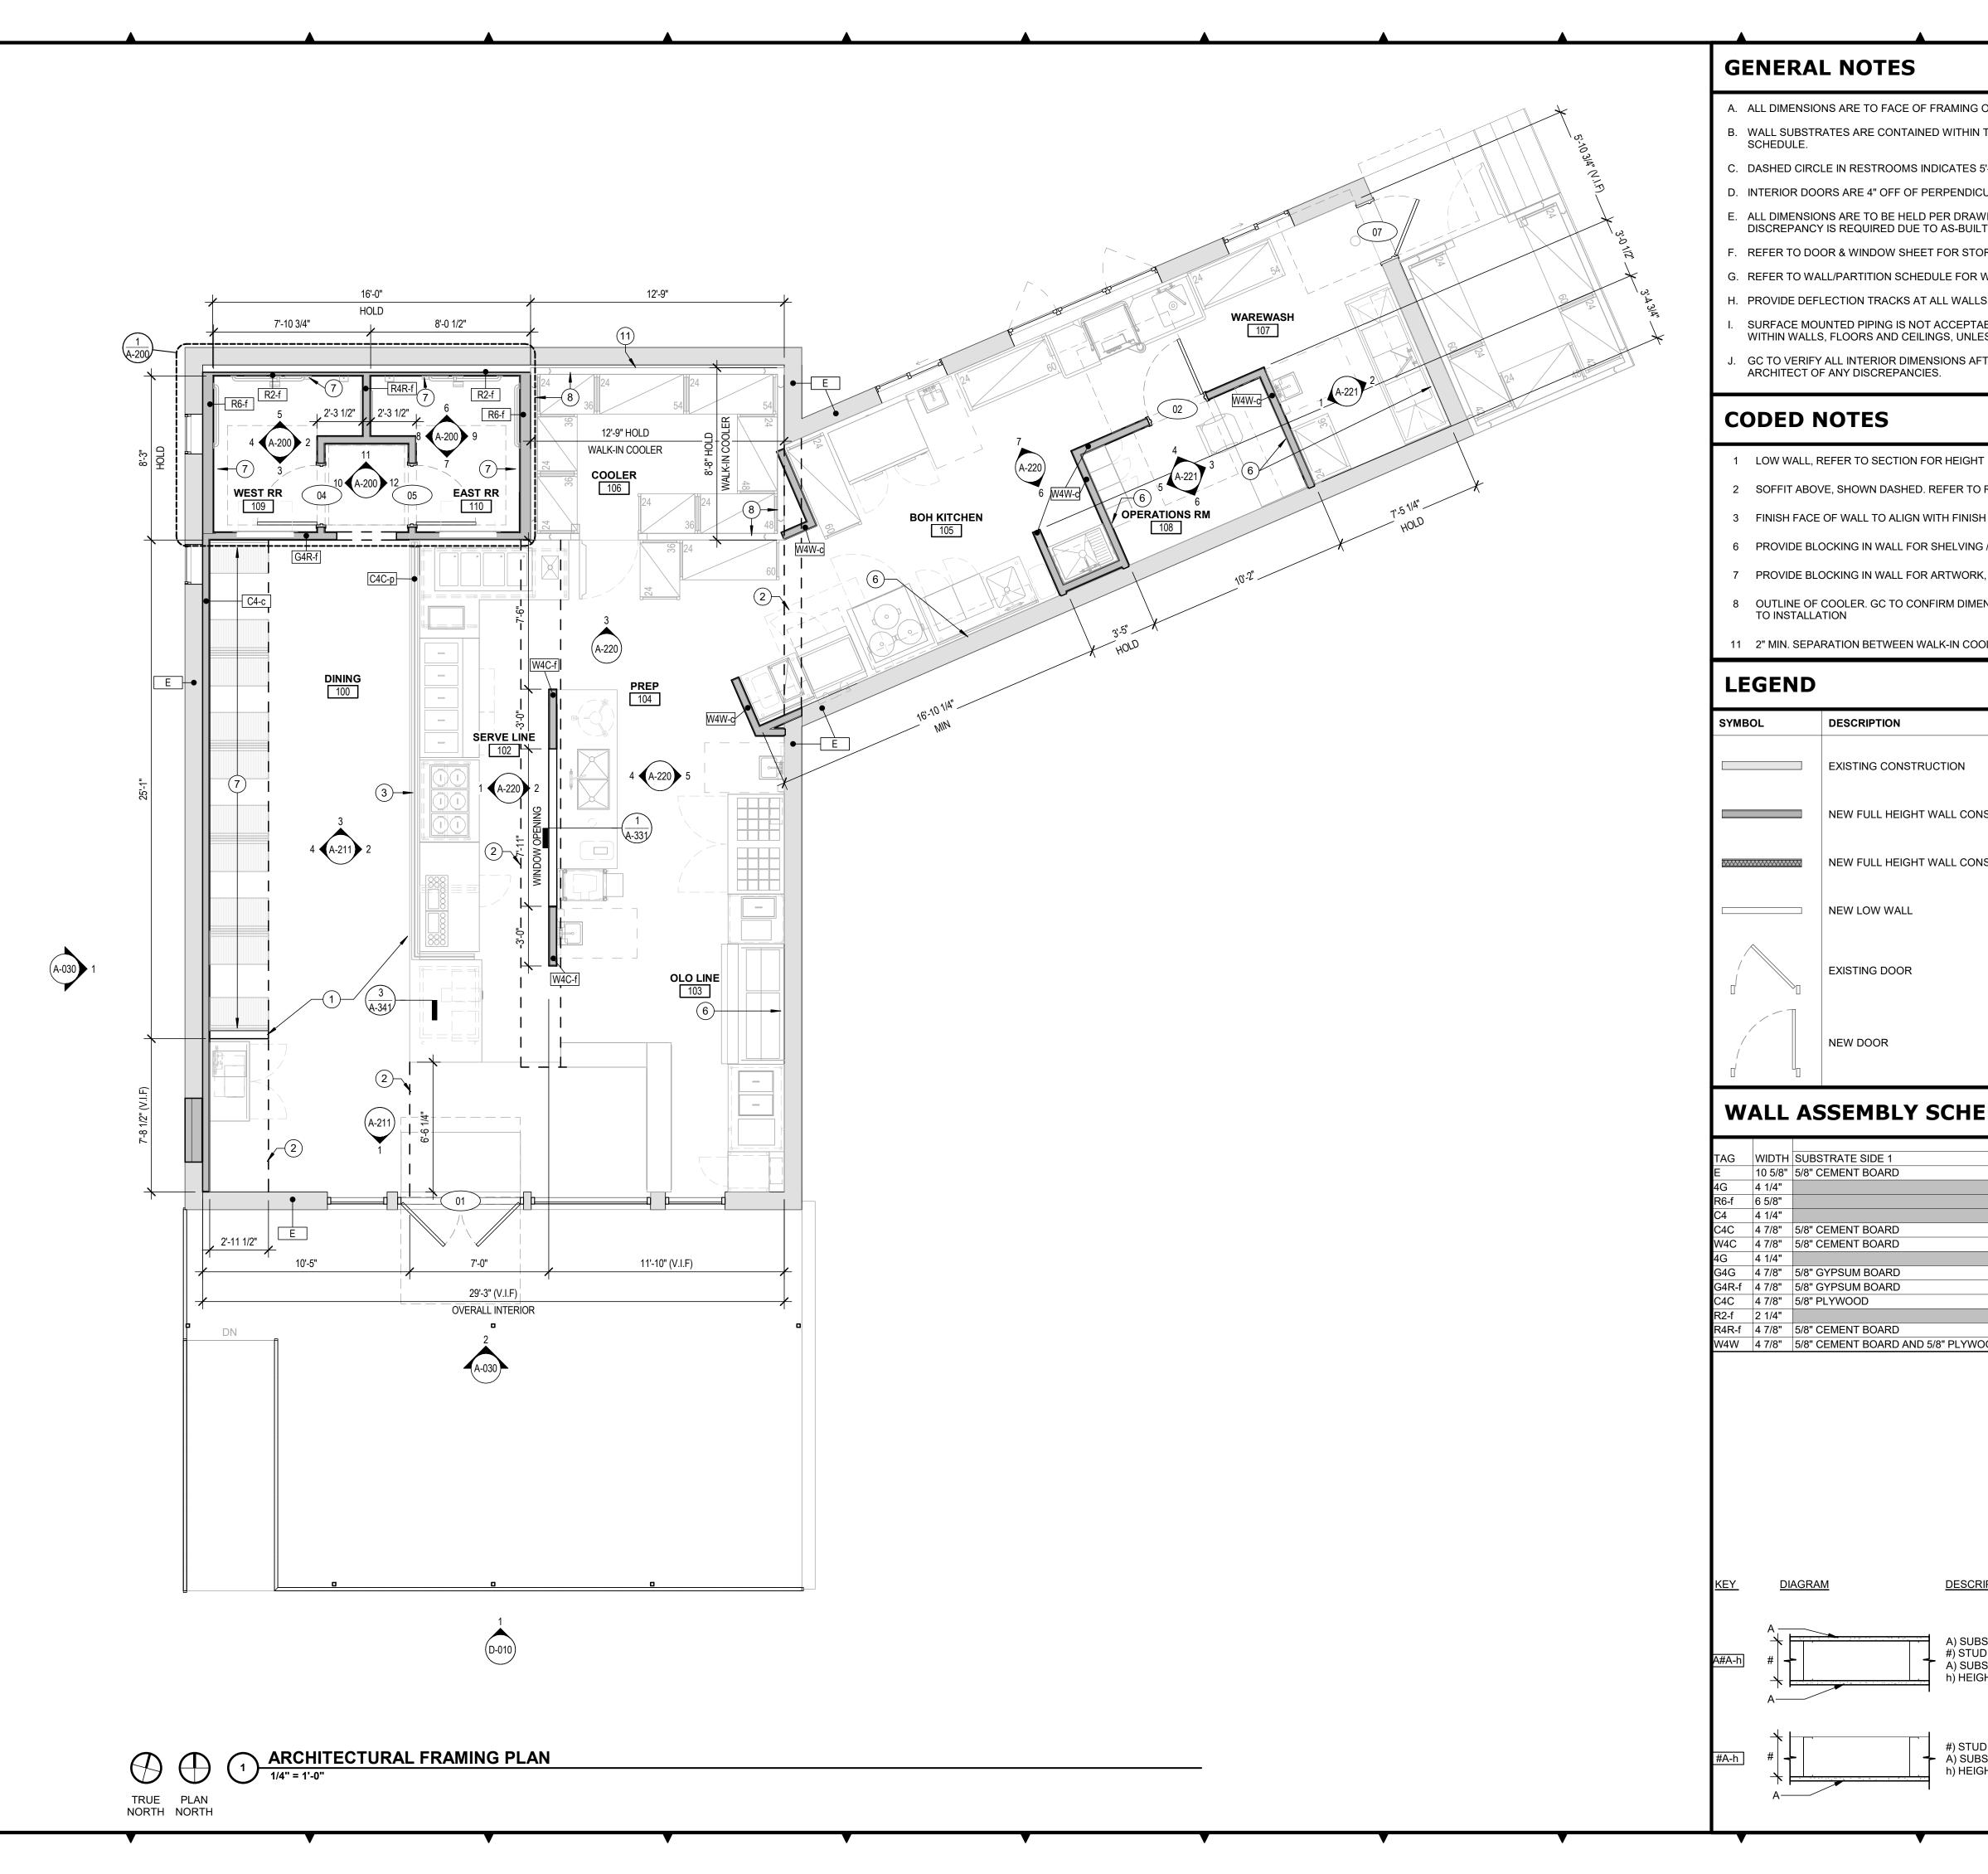
PROJECT NO: 50139167 TEMPLATE VERSION: 05.06.2022

REVISIONS REV. DATE

DESCRIPTION

**ENLARGED PATIO PLAN** 

1556 N. DECATUR ROAD EMORY VILLAGE, LLC 856-359-5312



- A. ALL DIMENSIONS ARE TO FACE OF FRAMING OR CENTERLINE OF STRUCTURE U.N.O.
- B. WALL SUBSTRATES ARE CONTAINED WITHIN THE WALL TAG INFORMATION. REFER TO PARTITION WALL
- C. DASHED CIRCLE IN RESTROOMS INDICATES 5'-0" TURNING DIAMETER PER CODE.
- D. INTERIOR DOORS ARE 4" OFF OF PERPENDICULAR WALL UNLESS NOTED OTHERWISE.
- ALL DIMENSIONS ARE TO BE HELD PER DRAWING UNLESS NOTED OTHERWISE. CONTACT ARCHITECT IF DISCREPANCY IS REQUIRED DUE TO AS-BUILT CONDITIONS.
- REFER TO DOOR & WINDOW SHEET FOR STOREFRONT RESPONSIBILITY AND DOOR TYPES.
- G. REFER TO WALL/PARTITION SCHEDULE FOR WALL TYPES.
- PROVIDE DEFLECTION TRACKS AT ALL WALLS THAT CONNECT TO THE UNDERSIDE OF STRUCTURE.
- SURFACE MOUNTED PIPING IS NOT ACCEPTABLE. PIPING AND CONDUITS OF ALL TYPES MUST BE CONCEALED WITHIN WALLS, FLOORS AND CEILINGS, UNLESS OTHERWISE NOTED.
- GC TO VERIFY ALL INTERIOR DIMENSIONS AFTER DEMO, PRIOR TO LAYOUT START. ALERT SWEETGREEN AND


### **CODED NOTES**

- 2 SOFFIT ABOVE, SHOWN DASHED. REFER TO REFLECTED CEILING PLAN.
- 3 FINISH FACE OF WALL TO ALIGN WITH FINISH FACE OF SOFFIT ABOVE
- 6 PROVIDE BLOCKING IN WALL FOR SHELVING / AV RACK, REFER TO ELEVATIONS FOR LOCATIONS
- 7 PROVIDE BLOCKING IN WALL FOR ARTWORK, REFER TO ELEVATIONS FOR LOCATIONS
- 8 OUTLINE OF COOLER. GC TO CONFIRM DIMENSIONS OF WALK-IN COOLER WITH EQUIPMENT SUPPLIER PRIOR
- 11 2" MIN. SEPARATION BETWEEN WALK-IN COOLER WALL AND ANY ADJACENT WALL, TYP.

L		
	SYMBOL	DESCRIPTION
		EXISTING CONSTRUCTION
		NEW FULL HEIGHT WALL CONSTRUCTION
	***************************************	NEW FULL HEIGHT WALL CONSTRUCTION W/ SOUND BATT INSULATION
		NEW LOW WALL
		EXISTING DOOR
		NEW DOOR

## WALL ASSEMBLY SCHEDULE

			CC	NSTRUCTION
TAG	WIDTH	SUBSTRATE SIDE 1	STUD	SUBSTRATE SIDE 2
E	10 5/8"	5/8" CEMENT BOARD	6"	5/8" GYPSUM BOARD
4G	4 1/4"		3-5/8"	5/8" GYPSUM BOARD
R6-f	6 5/8"		6"	5/8" CEMENT BOARD AND 5/8" GYPSUM BOARD
C4	4 1/4"		3-5/8"	5/8" CEMENT BOARD
C4C	4 7/8"	5/8" CEMENT BOARD	3-5/8"	5/8" CEMENT BOARD
N4C	4 7/8"	5/8" CEMENT BOARD	3-5/8"	5/8" CEMENT BOARD AND 5/8" PLYWOOD
4G	4 1/4"		3-5/8"	5/8" GYPSUM BOARD
G4G	4 7/8"	5/8" GYPSUM BOARD	3-5/8"	5/8" GYPSUM BOARD
G4R-f	4 7/8"	5/8" GYPSUM BOARD	3-5/8"	5/8" CEMENT BOARD
C4C	4 7/8"	5/8" PLYWOOD	3-5/8"	5/8" CEMENT BOARD AND 5/8" PLYWOOD
R2-f	2 1/4"		1-5/8"	5/8" GYPSUM BOARD
R4R-f	4 7/8"	5/8" CEMENT BOARD	3-5/8"	5/8" CEMENT BOARD
W4W	4 7/8"	5/8" CEMENT BOARD AND 5/8" PLYWOOD	3-5/8"	5/8" CEMENT BOARD AND 5/8" PLYWOOD

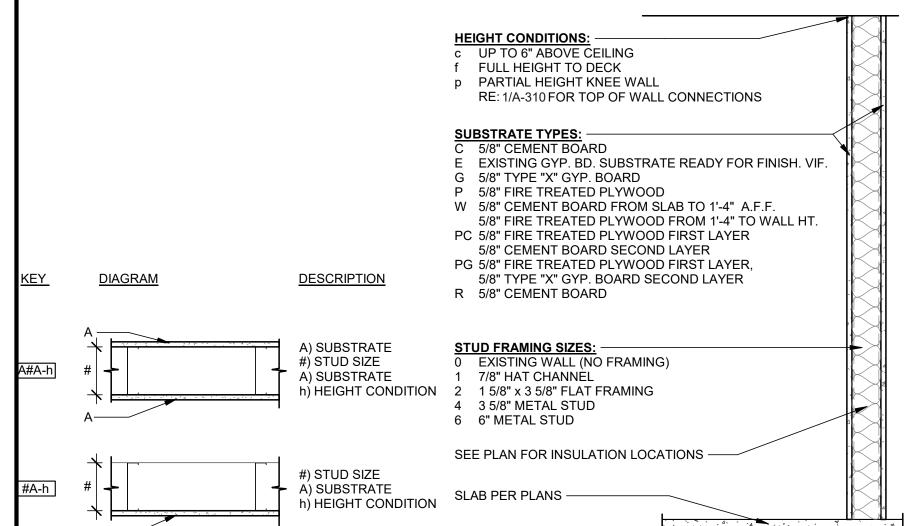

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ARCHITECT OF RECORD:



Dewberry Architects Inc.

300 N. Lake Ave, 12th Floor Pasadena, Ca. 91101 916.239.4256 Phone 916.239.7245 Fax

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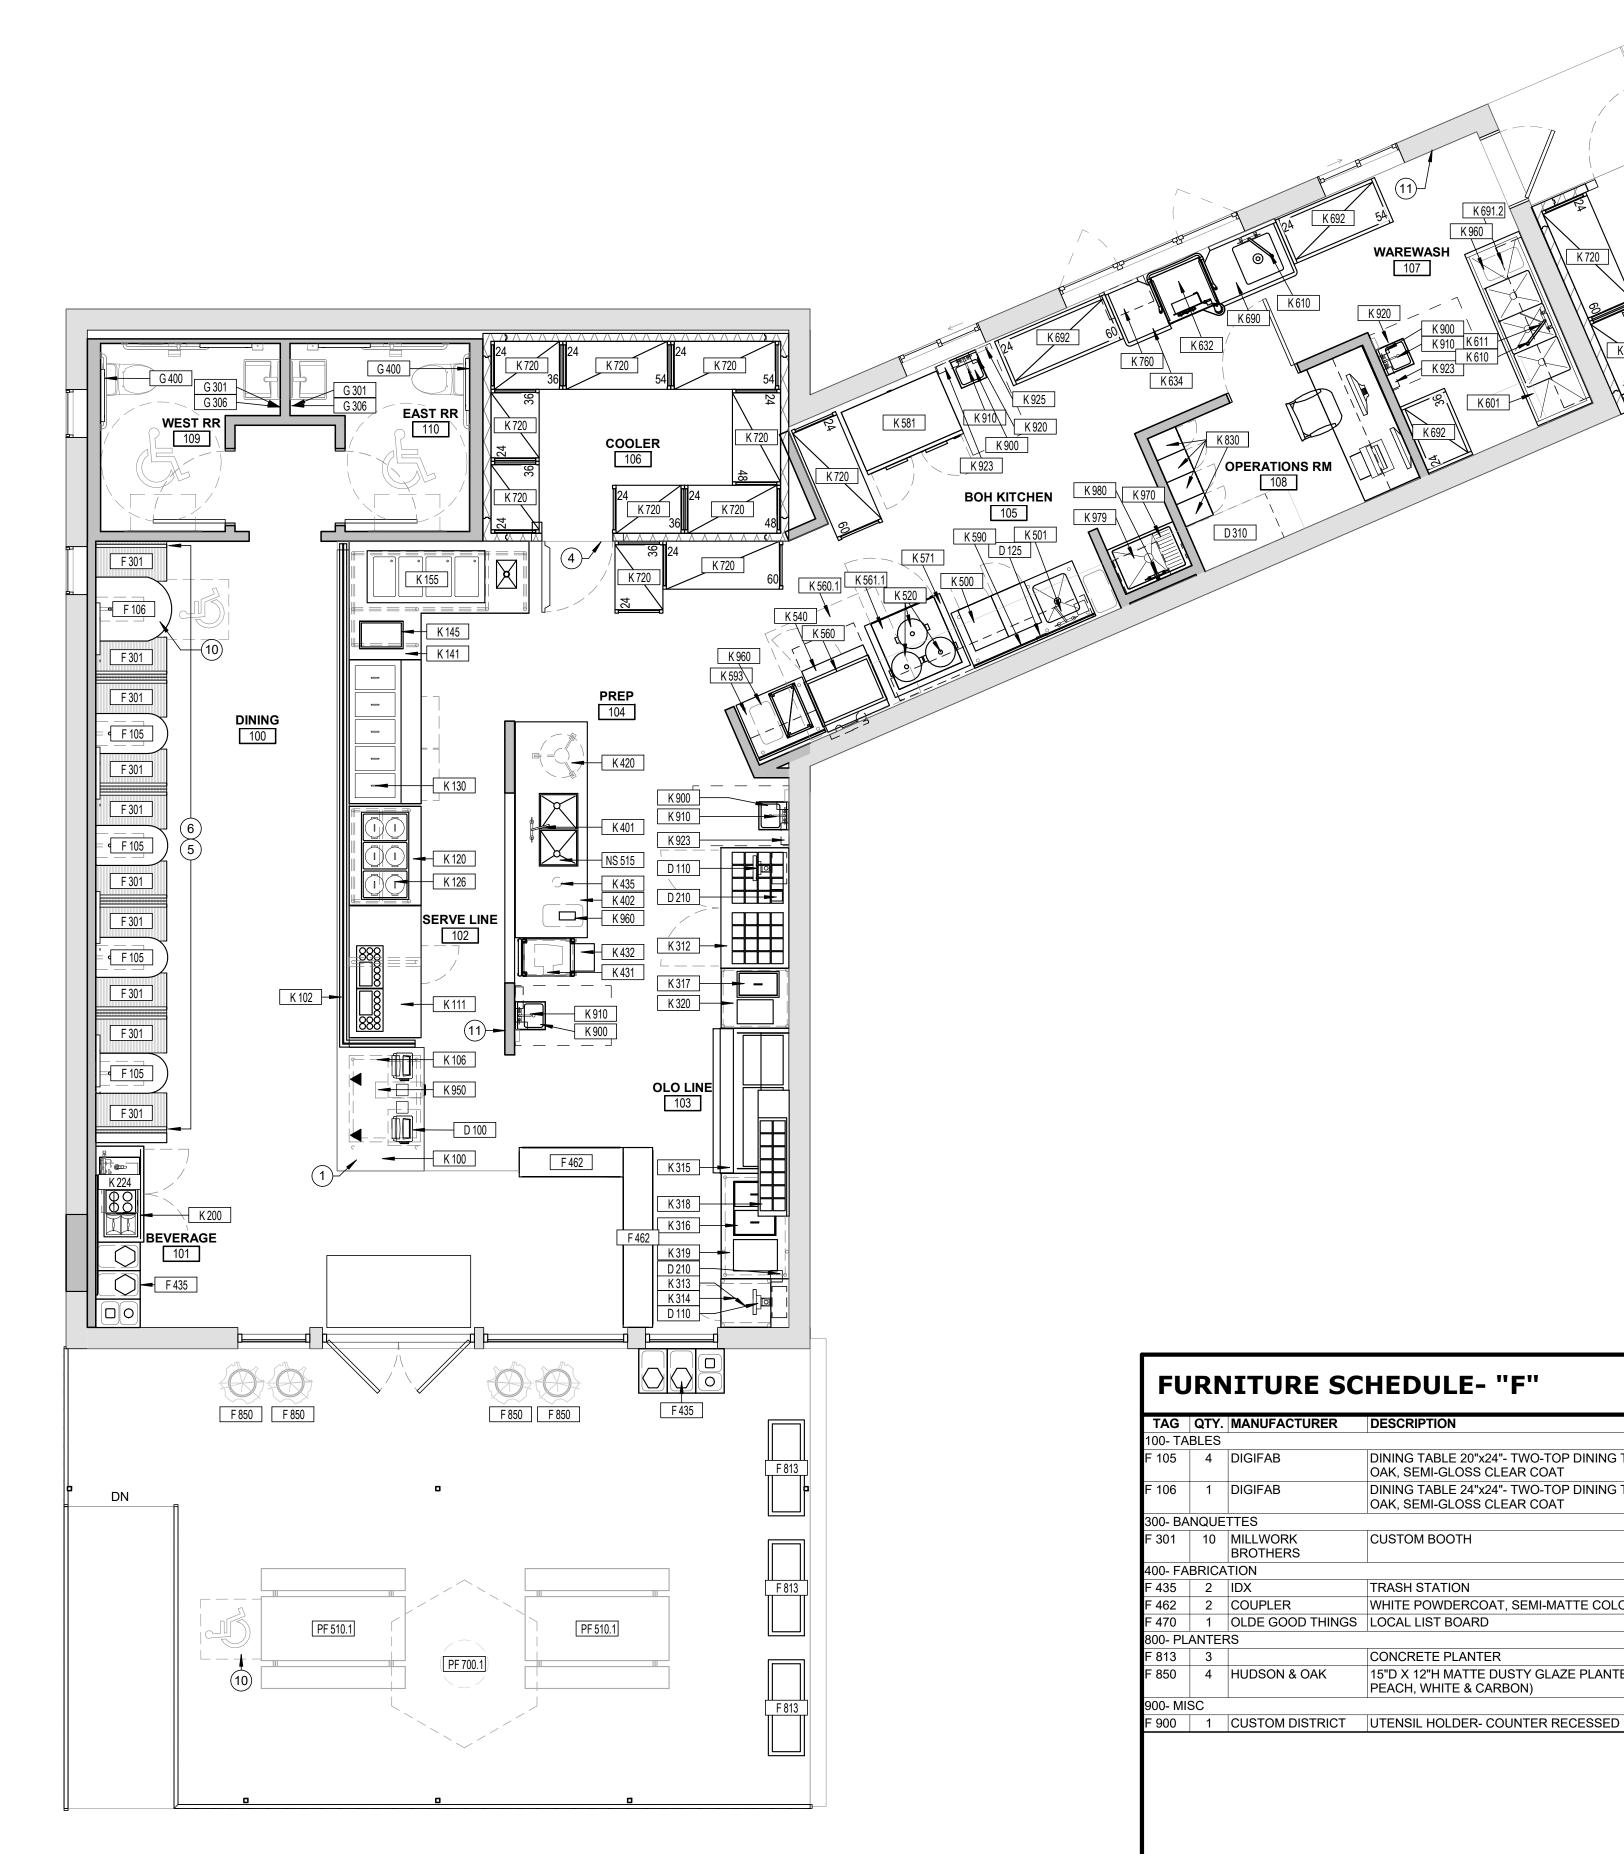
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DESCRIPTION

**ANNOTATION & DIMENSION FLOOR** 

**PLAN** 1556 N. DECATUR ROAD EMORY VILLAGE, LLC 856-359-5312



- A. GC TO COORDINATE EQUIPMENT WITH UNDERGROUND PLUMBING, GC TO NOTIFY ARCHITECT AND SWEETGREEN OF ANY DISCREPANCIES OR CONFLICTS.
- B. REFER TO KITCHEN EQUIPMENT SCHEDULE FOR EQUIPMENT SPECIFICATIONS.
- . REFER TO FURNITURE SCHEDULE FOR FINAL FURNITURE PIECE COUNTS. NOT ALL UNITS MAY BE REFLECTED
- D. GC TO PROVIDE CAULKING AT EQUIPMENT.
- REFER TO ENLARGED RESTROOM PLAN SHEET FOR EQUIPMENT AND ACCESSORY SCHEDULE FOR RESTROOM ITEMS.
- F. KES TO INSTALL COOLER MANUFACTURER SUPPLIED AIR CURTAIN INSIDE COOLER DOOR.
- G. GC TO SUPERVISE INSTALLATION OF VENDOR INSTALLED ITEMS FOR PROPER INSTALLATION PER EQUIPMENT
- H. ALL EQUIPMENT MUST BE CERTIFIED OR CLASSIFIED FOR SANITATION BY AN AMERICAN NATIONAL STANDARDS INSTITUTE (ANSI) ACCREDITED CERTIFICATION PROGRAM OR AN ACCREDITED TESTING AGENCY.

ACCESSIBLE TRANSACTION COUNTER. MIN. 36" LENGTH AT 34" AFF. CLEAR FLOOR SPACE IN FRONT

BOOTH SEATING, SUPPLIED BY OWNER, INSTALLED BY GC. GC TO PROVIDE BLOCKING IN WALL FOR

REFER TO ELECTRICAL DRAWINGS FOR POWER REQUIREMENTS AT BOOTHS; ALIGN WITH THE

PROVIDE ADT PANEL LOCATION 4'-6" A.F.F. O.C. REFER TO ELECTRICAL DRAWINGS

- REFER TO PATIO PLAN AND FURNITURE FOR DETAILS.
- REFER TO KITCHEN EQUIPMENT SCHEDULE FOR DETAILS.
- K. REFER TO SIGNAGE SCHEDULE FOR DETAILS.
- REFER TO DATA DEVICE SCHEDULE FOR DETAILS.

**CODED NOTES** 

MODEL

CUSTOM

CUSTOM

CUSTOM

CUSTOM

ROUND PLANTER

CUSTOM, LOCAL 5'X3' - LANDSCAPE

DINING TABLE 20"x24"- TWO-TOP DINING TABLE WITH WHITE CUSTOM

DINING TABLE 24"x24"- TWO-TOP DINING TABLE WITH WHITE CUSTOM OAK, SEMI-GLOSS CLEAR COAT

WHITE POWDERCOAT, SEMI-MATTE COLOR RAL XXX

15"D X 12"H MATTE DUSTY GLAZE PLANTER (COLORS:

OAK, SEMI-GLOSS CLEAR COAT

CUSTOM BOOTH

TRASH STATION

CONCRETE PLANTER

PEACH, WHITE & CARBON)

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## TYPICAL FURNITURE PLAN NOTES

OF COUNTER TO BE MIN. 30"x48" FOR SIDE APPROACH

AIR CURTAIN CENTERED ABOVE DOOR

CENTER OF THE TABLES, 14" A.F.F.

ACCESSIBLE DINING TABLE

CONTRACTOR TO VERIFY MODEL NUMBER WITH FURNITURE SPECIFICATIONS. ANY DISCREPENCIES BETWEEN MODEL NUMBER AND DESCRIPTION ARE TO BE DISCUSSED WITH ARCHITECT.

NOTE: VENDOR TO VERIFY ALL QUANTITIES PRIOR TO ORDER AND INSTALL OF FURNITURE

INSTALL REMARKS

GC CONTACT: ZENON GARNCARZ 416.428.8642

GC CONTACT: ZENON GARNCARZ 416.428.8642

COVER PLATES (WHITE OR S/S)

GC REFER TO DETAILS FOR CONSTRUCTION.

GC 1" STEEL TUBE & SHEET METAL

GC GC TO ASSEMBLE AND INSTALL

GC OWNER TO PROVIDE PLANTING

GC GC TO PROVIDE BLOCKING

GC GC TO ASSEMBLE AND INSTALL; GC TO PROVIDE ELECTRICAL

GC REFER TO SHOP DRAWINGS FOR CUTOUT DIMENSIONS

SUPPLY

OWNER

OWNER

OWNER

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DRAWN BY: CHECKED BY: PROJECT MANAGER: SG DESIGN MANAGER:

SG CONSTR. MANAGER: PROJECT NO: 50139167 TEMPLATE VERSION: 05.06.2022

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DESCRIPTION

**EQUIPMENT & FURNITURE PLAN** 


1556 N. DECATUR ROAD EMORY VILLAGE, LLC 856-359-5312

A-130

EQUIPMENT & FURNITURE PLAN

1/4" = 1'-0"

TRUE PLAN NORTH NORTH

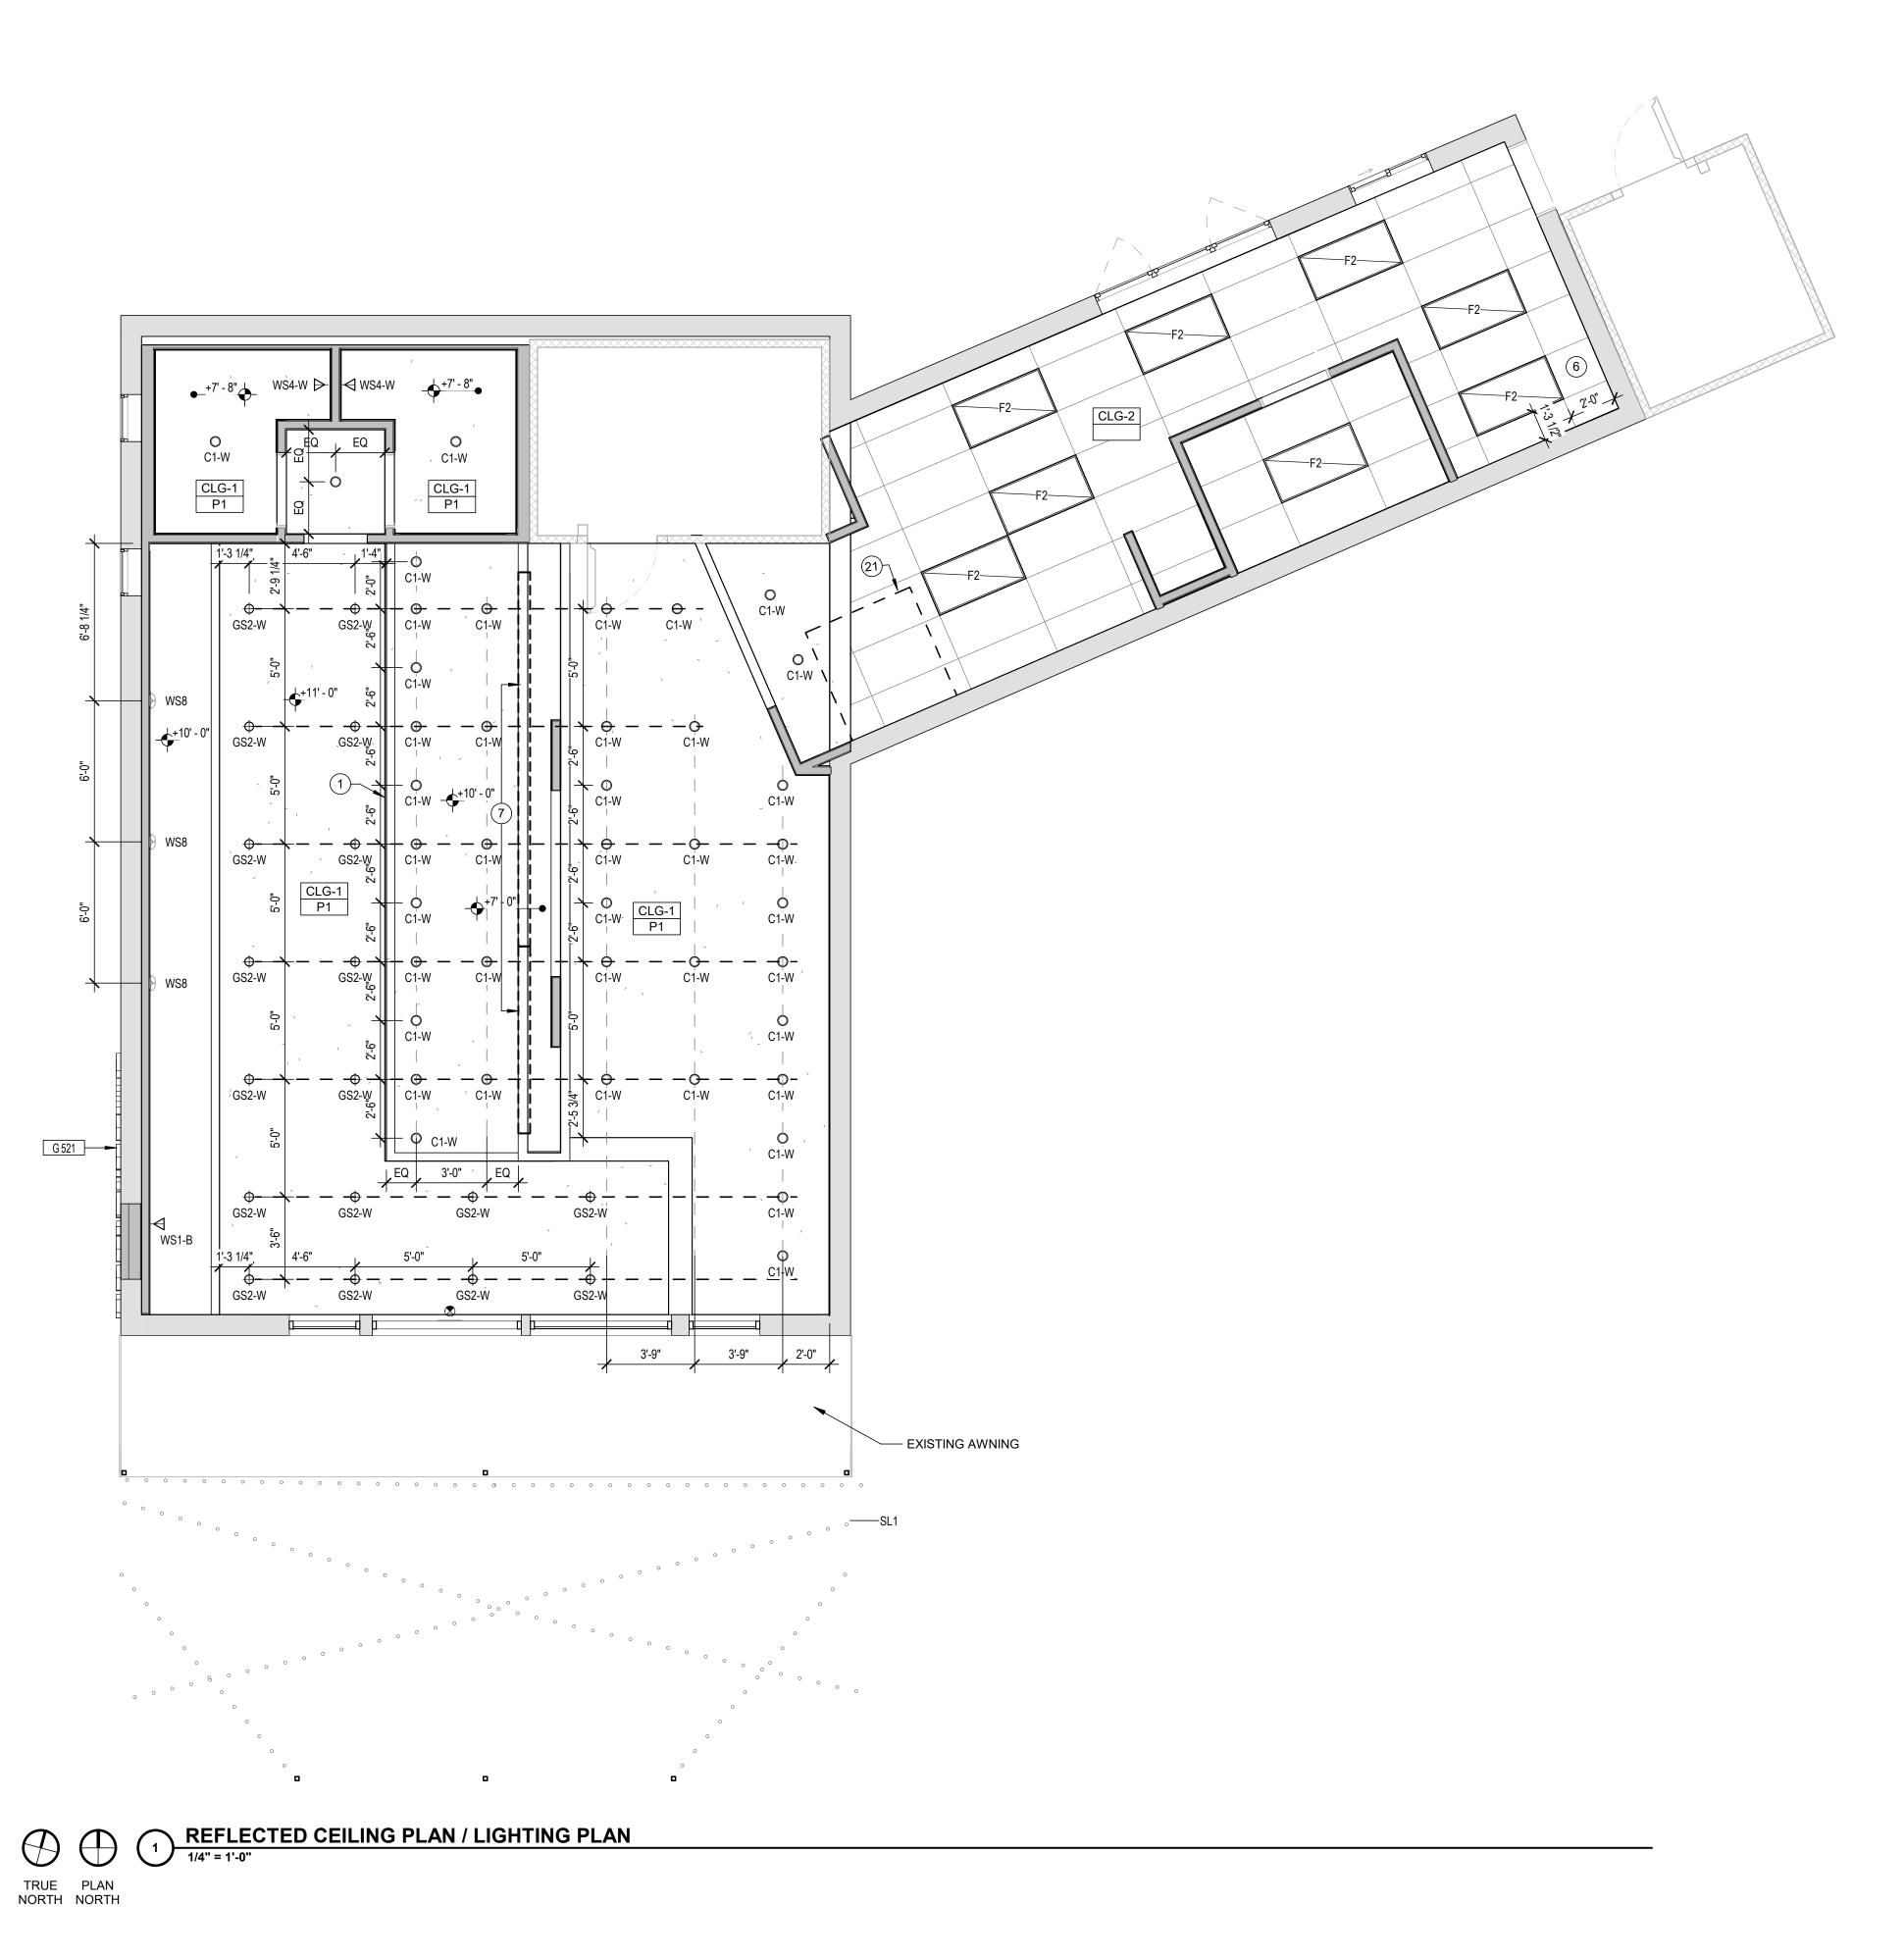

- A. CEILING HEIGHT DIMENSIONS ARE FROM DESIGNATED FINISH FLOOR SURFACES TO THE FINISHED CEILING SURFACE UNLESS NOTED OTHERWISE.
- B. REFER TO FINISH LIST FOR FINISHES AT EXPOSED CEILING AREAS IN ADDITION TO NOTES LISTED ON THIS SHEET
- C. ALL UNISTRUT SUPPORTING CEILING ELEMENTS AND / OR DUCT WORK SHALL NOT CONTAIN ANY ELECTRICAL CONDUIT. ALL ELECTRICAL CONDUIT MUST RUN IN SEPARATE UNISTRUT.
- D. ALL DIMENSIONS ARE TO FACE OF WALL, SOFFIT, OR CENTERLINE OF FIXTURE UNLESS NOTED OTHERWISE.
- E. FULL CERAMIC TILE COURSING SHALL TAKE PRECEDENT OVER ANY CEILING/HEADER DIMENSION INDICATED IN THE PLAN.
- F. SOUND BATT INSULATION TO BE INSTALLED ABOVE THE RESTROOM CEILING.
- G. SUB-CONTRACTOR TO COORDINATE FINAL SPRINKLER HEAD LOCATIONS WITH ARCHITECT VIA SHOP DRAWINGS, SPRINKLER HEADS TO BE CENTERED BETWEEN LIGHTS IN ALL LOCATIONS. FOR SPRINKLER HEADS ABOVE STORAGE SHELVING, A PROTECTIVE CAGE MUST BE PROVIDED.
- H. ALL CEILING ACCESS PANELS LARGER THAN 12"x 12" TO BE MUD-IN STYLE INTEXFORMS APS24X24. ALL CEILING ACCESS PANELS SMALLER THAN 12"x 12" TO BE FLANGED STEEL TYPE.
- I. ALL CEILING FIXTURES AND ACCESSORIES TO ALIGN WITH CENTER OF LIGHTING FIXTURES, CEILING TILES OR OTHER CEILING ELEMENTS WHERE POSSIBLE.
- PHOTOMETRIC VALUES IN ALL AREAS TO MEET OR EXCEED LOCAL CODE REQUIREMENTS.
- . NO LIGHT TO BE LESS THAN 18" FROM FACE OF FINISHED WALL SURFACE.
- M. SEE FINISH SCHEDULE FOR CEILING MATERIAL & FINISH.
- N. SEE ELECTRICAL DRAWINGS FOR LIGHTING FIXTURE SCHEDULE

## CODED NOTES D

- 1 FACE OF SOFFIT TO ALIGN WITH FACE OF WALL BELOW
- 6 BEGIN LAY-IN CEILING TILES AT THIS LOCATION
- 7 DIGITAL MENUBOARD. GC TO SUPPLY BLOCKING IN CEILING/SOFFIT. EXTEND BLOCKING 36" PAST LENGTH OF
- MENUBOARD ON BOTH SIDES.
- 21 CAPTIVEAIRE HOOD, REFER TO EQUIPMENT PLAN

## **TYPICAL LIGHTING PLAN NOTES:**

- 1. CONTRACTOR TO VERIFY MODEL NUMBER WITH LIGHTING VENDOR. ANY DISCREPENCIES BETWEEN MODEL NUMBER AND DESCRIPTION ARE TO BE DISCUSSED WITH ARCHITECT.
- LIGHTING VENDOR TO VERIFY ALL QUANTITIES PRIOR TO ORDER.
   CUSTOM ELEMENTS ARE NOTED WITH AN "X" PREFIX.
- 4. SWEETGREEN LIGHTING VENDOR TO PROVIDE SPECIFIED FIXTURES AND CONTROLS.

## LEGEND

SYMBOL	DESCRIPTION	SYMBOL	DESCRIPTION
$\boxtimes$	SUPPLY / RETURN DIFFUSERS RE: MECHANICAL PLANS		24"x48" LAY-IN CEILING
	CEILING ACCESS PANELS RE: GENERAL NOTES FOR TYPE		21 X10 2 X1 W 02.2
8	SECURITY CAMERA		
	WIRELESS ACCESS POINT		GYPSUM BOARD CEILING
(d)	RECESSED MOUNT SPEAKER - BOH	0	RECESSED CAN LIGHT
Ф	WALL MOUNT SPEAKER - FOH	<del>•</del>	SUSPENDED PENDANT LIGH
•	FIRE SPRINKLER HEAD FOR REF. ONLY, SEE FIRE PROTECTION PLAN		2X4 LED LIGHT FIXTURE
	WALL MOUNT SUBWOOFER -	❤	SCONCE LIGHT
	FOH	Δ.	SCONCE LIGHT

# Sg

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ARCHITECT OF RECORD:

## **Dewberry**

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EMORY VILLAGE

PROJECT INFORMATION:

556 N DECATUR RD,


ATLANTA, GA 30307

DRAWN BY: TF
CHECKED BY: JW
PROJECT MANAGER: ZM
SG DESIGN MANAGER: LG
SG CONSTR. MANAGER: JD
PROJECT NO: 50139167
TEMPLATE VERSION: 05.06.2022

REVISIONS
REV. DATE DESCRIPTION

## REFLECTED CEILING AND LIGHTING PLAN

1556 N. DECATUR ROAD EMORY VILLAGE, LLC 856-359-5312

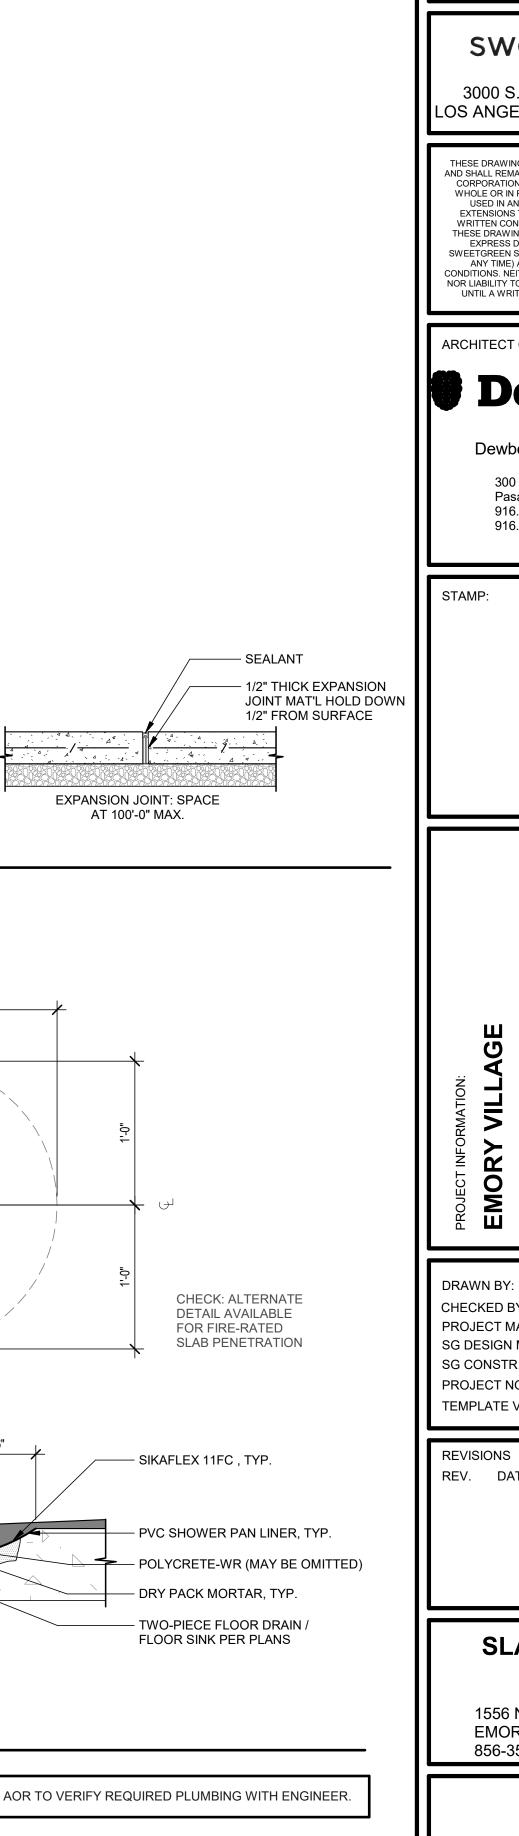

AT 100'-0" MAX.

- SEALANT

CONTROL JOINT: SPACE AT 10'-0" MAX.

IN BOTH DIRECTIONS.

REFER TO -

SCHEDULE FOR DRAIN

IN THIS AREA, — SLOPE FLOOR TO FLOOR DRAIN MAX

POLYCRETE ----

CONCRETE SLAB

DRAIN, AT MAX. 2%

SLOPE, REFER TO

TO SLOPE TO

PLAN, TYP.

EXISTING -

CONCRETE SLAB

1 1/2" = 1'-0"

SLOPE 2%

PLUMBING

5 TYPICAL CONTROL JOINTS
1" = 1'-0"

- TOOLED OR SAWN

DEPTH OF SLAB

**PLAN VIEW** 

V V V

**SECTION VIEW** 

CONTROL JOINT 1/4

1'-0"

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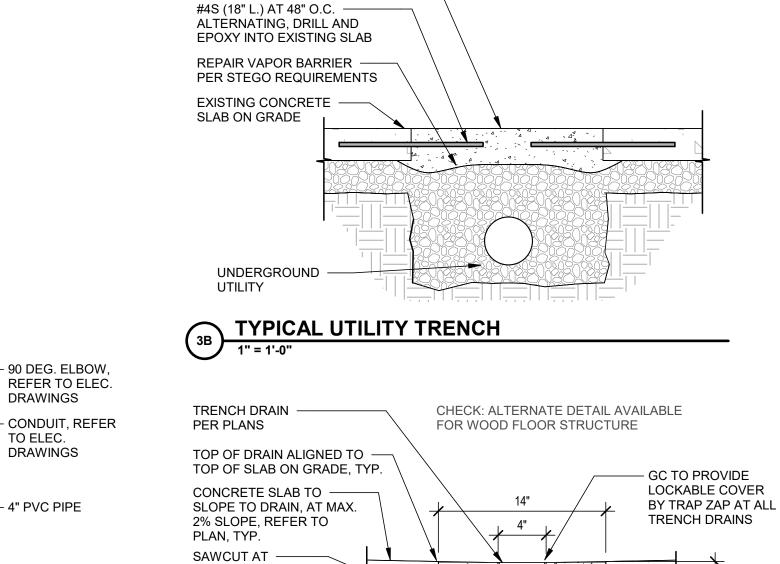
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DESCRIPTION

## **SLAB DETAILS**

1556 N. DECATUR ROAD EMORY VILLAGE, LLC 856-359-5312

A-300



NEW CONCRETE ON GRANULAR ----

FILL TRENCH PER 03300

PERIMETER

4" MINIMUM -

COMPACTED GRAVEL

REPAIR VAPOR ——— BARRIER PER STEGO

TYPICAL TRENCH DRAIN
1 1/2" = 1'-0"

REQUIREMENTS

LOCKABLE COVER BY TRAP ZAP AT ALL FLOOR SINKS GC TO PROVIDE — **PLAN VIEW** LOCKABLE COVER BY TRAP CHECK: USE SQUARE ZAP AT ALL FLOOR SINKS FOR SLAB-FLOOR SINKS ON-GRADE APPLICATIONS, USE ROUND FLOOR SINKS IF NEW SLAB, GC TO -FOR STRUCTURAL PROVIDE BLOCK-OUT SLAB/FLOOR BELOW. FOR LEVEL INSTALLATION ALTERNATE DETAIL OF SINK. IF SLAB IS EXISTING, GC TO SAW AVAILABLE FOR WOOD FLOOR STRUCTURE CUT OPENING AS REQUIRED FLOOR SINK SET -FLUSH WITH FLOOR OR ELEVATED PER LOCAL CODE REMOVABLE DRAIN -BASKET **SECTION VIEW** 

— FLOOR FINISH PER PLANS. T.O. FLOOR SINK TO BE FLUSH WITH T.O. FLOORING

1'-0"

2 TYPICAL FLOOR SINK
1 1/2" = 1'-0"

CONTINUOUS BEAD -

CONTINUE POLYCRETE RADIUS COVE UP AS SHOWN.
REFER TO FINISH DETAILS

4 TYPICAL ELECTRICAL STUB
3" = 1'-0"

OF SEALANT

DRAWINGS

TO ELEC.

DRAWINGS

– 4" PVC PIPE

RIGID METAL


CONDUIT, REFER TO

ELEC. DRAWINGS

1/2 GRATE —

COVER, TYP.

GC TO PROVIDE -

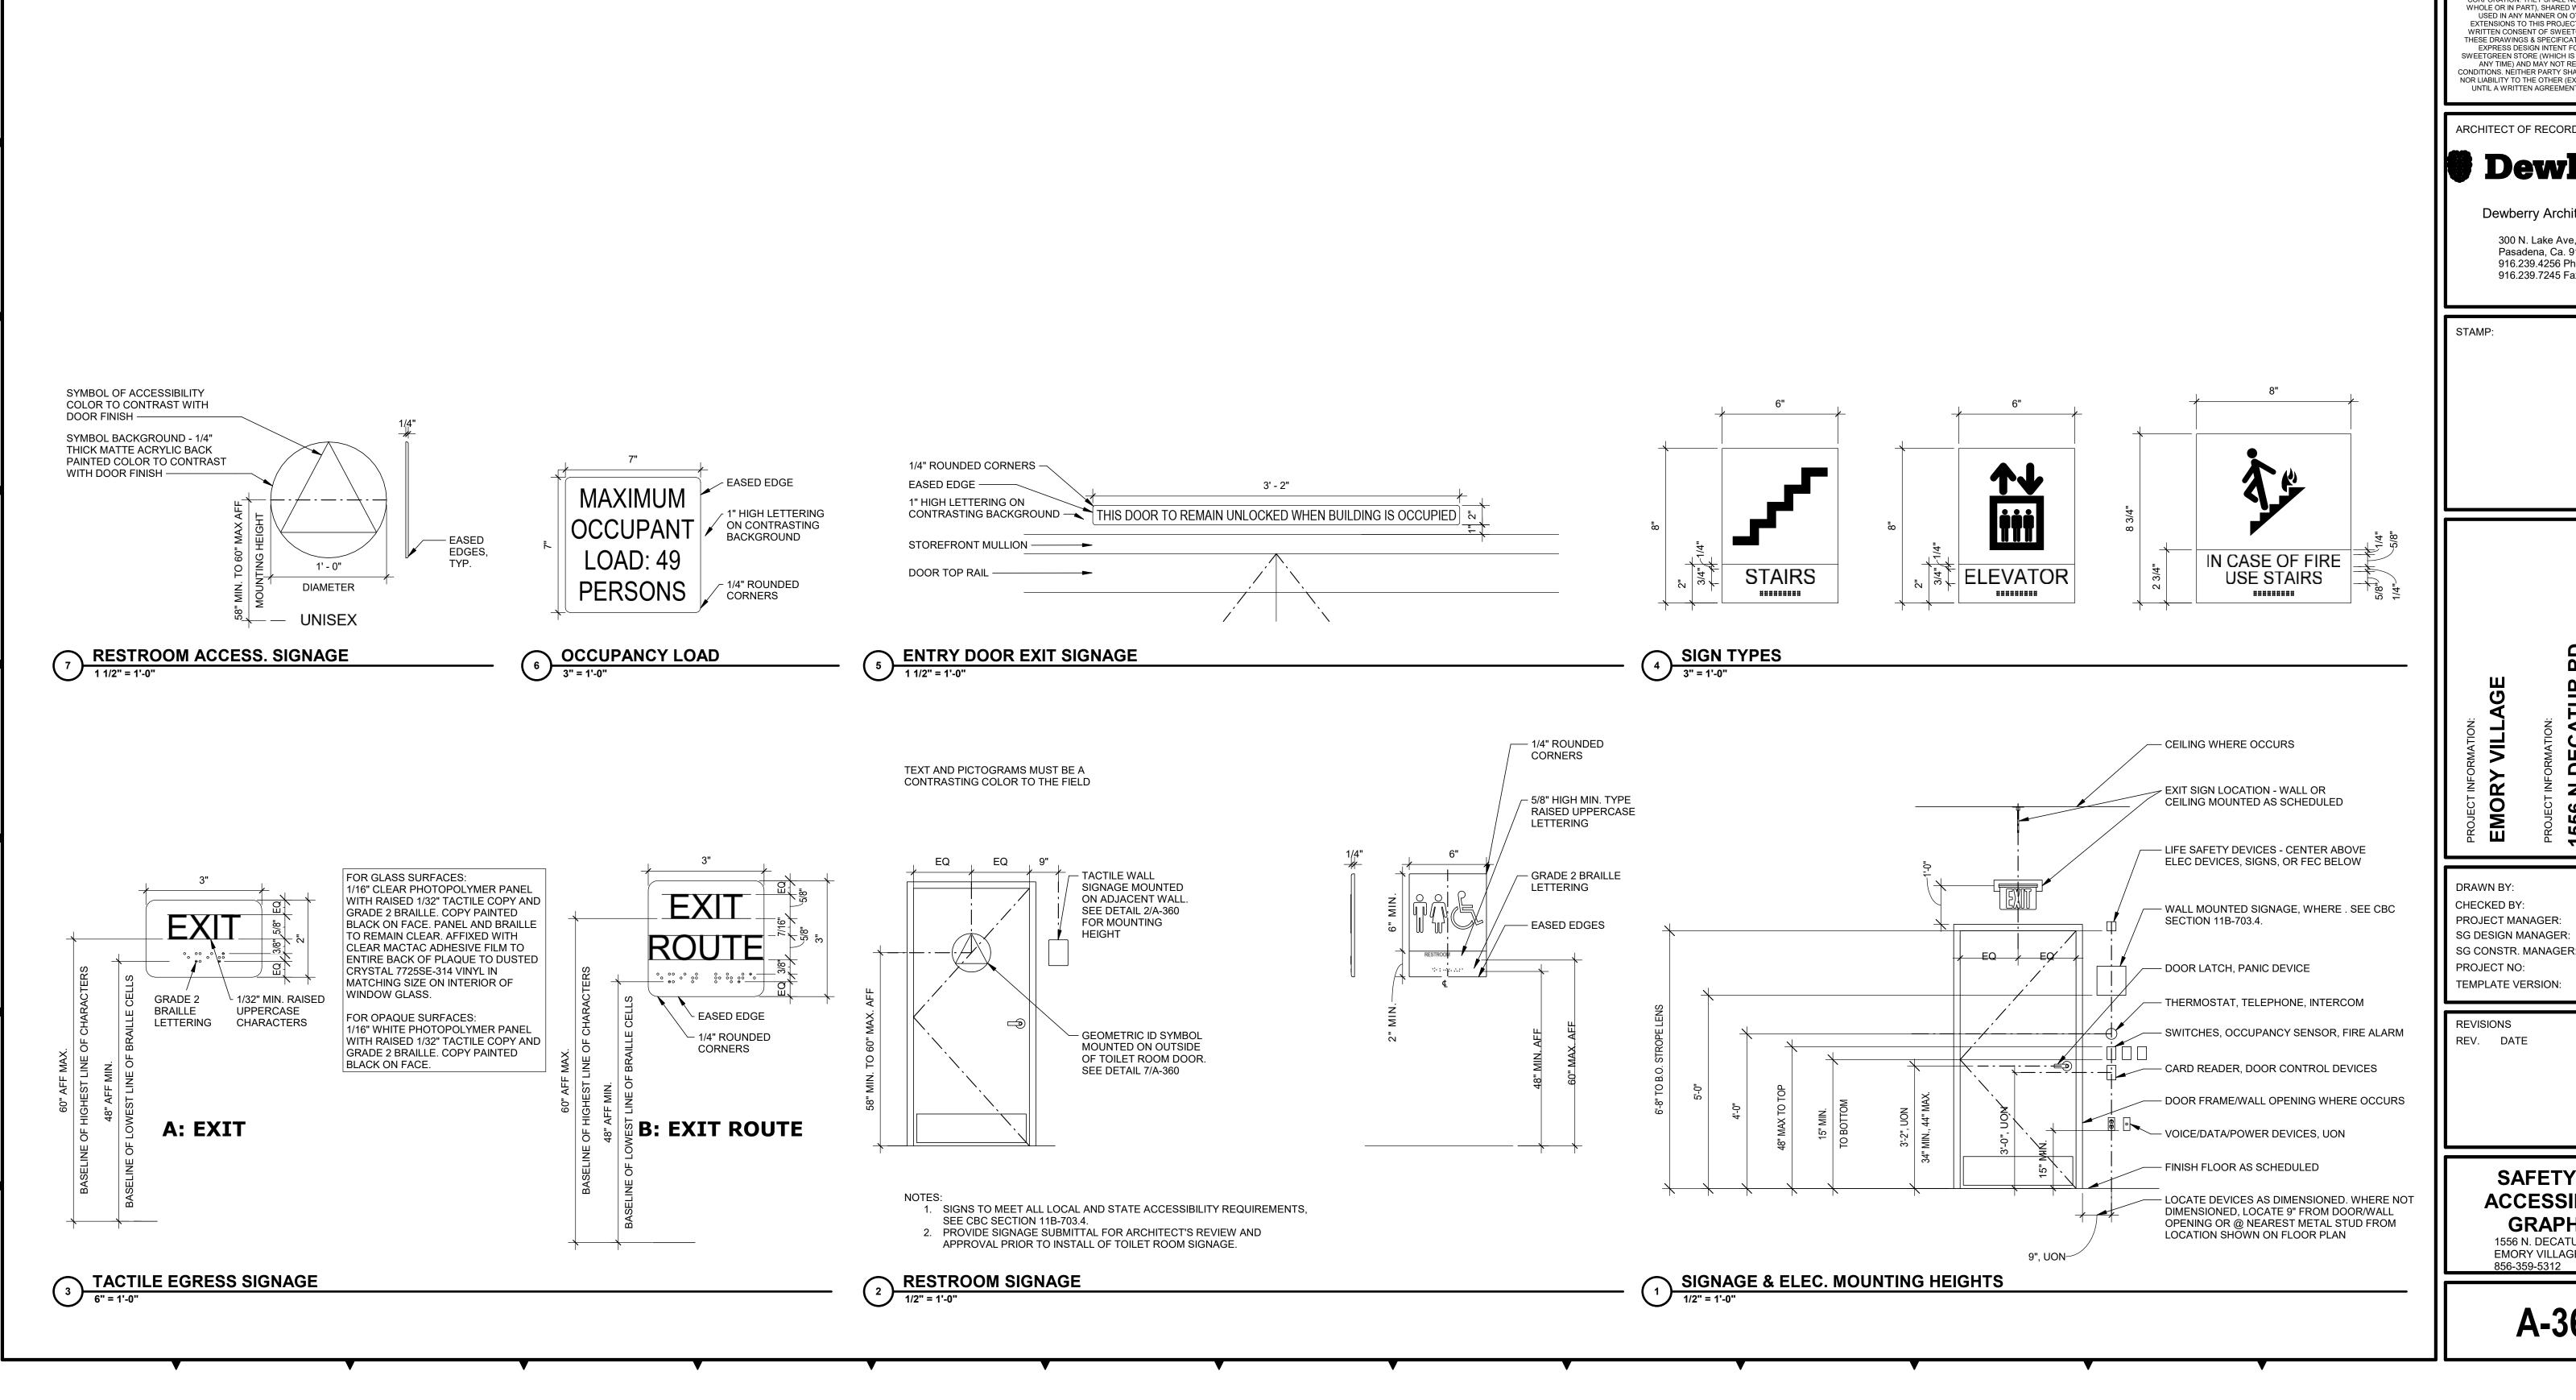

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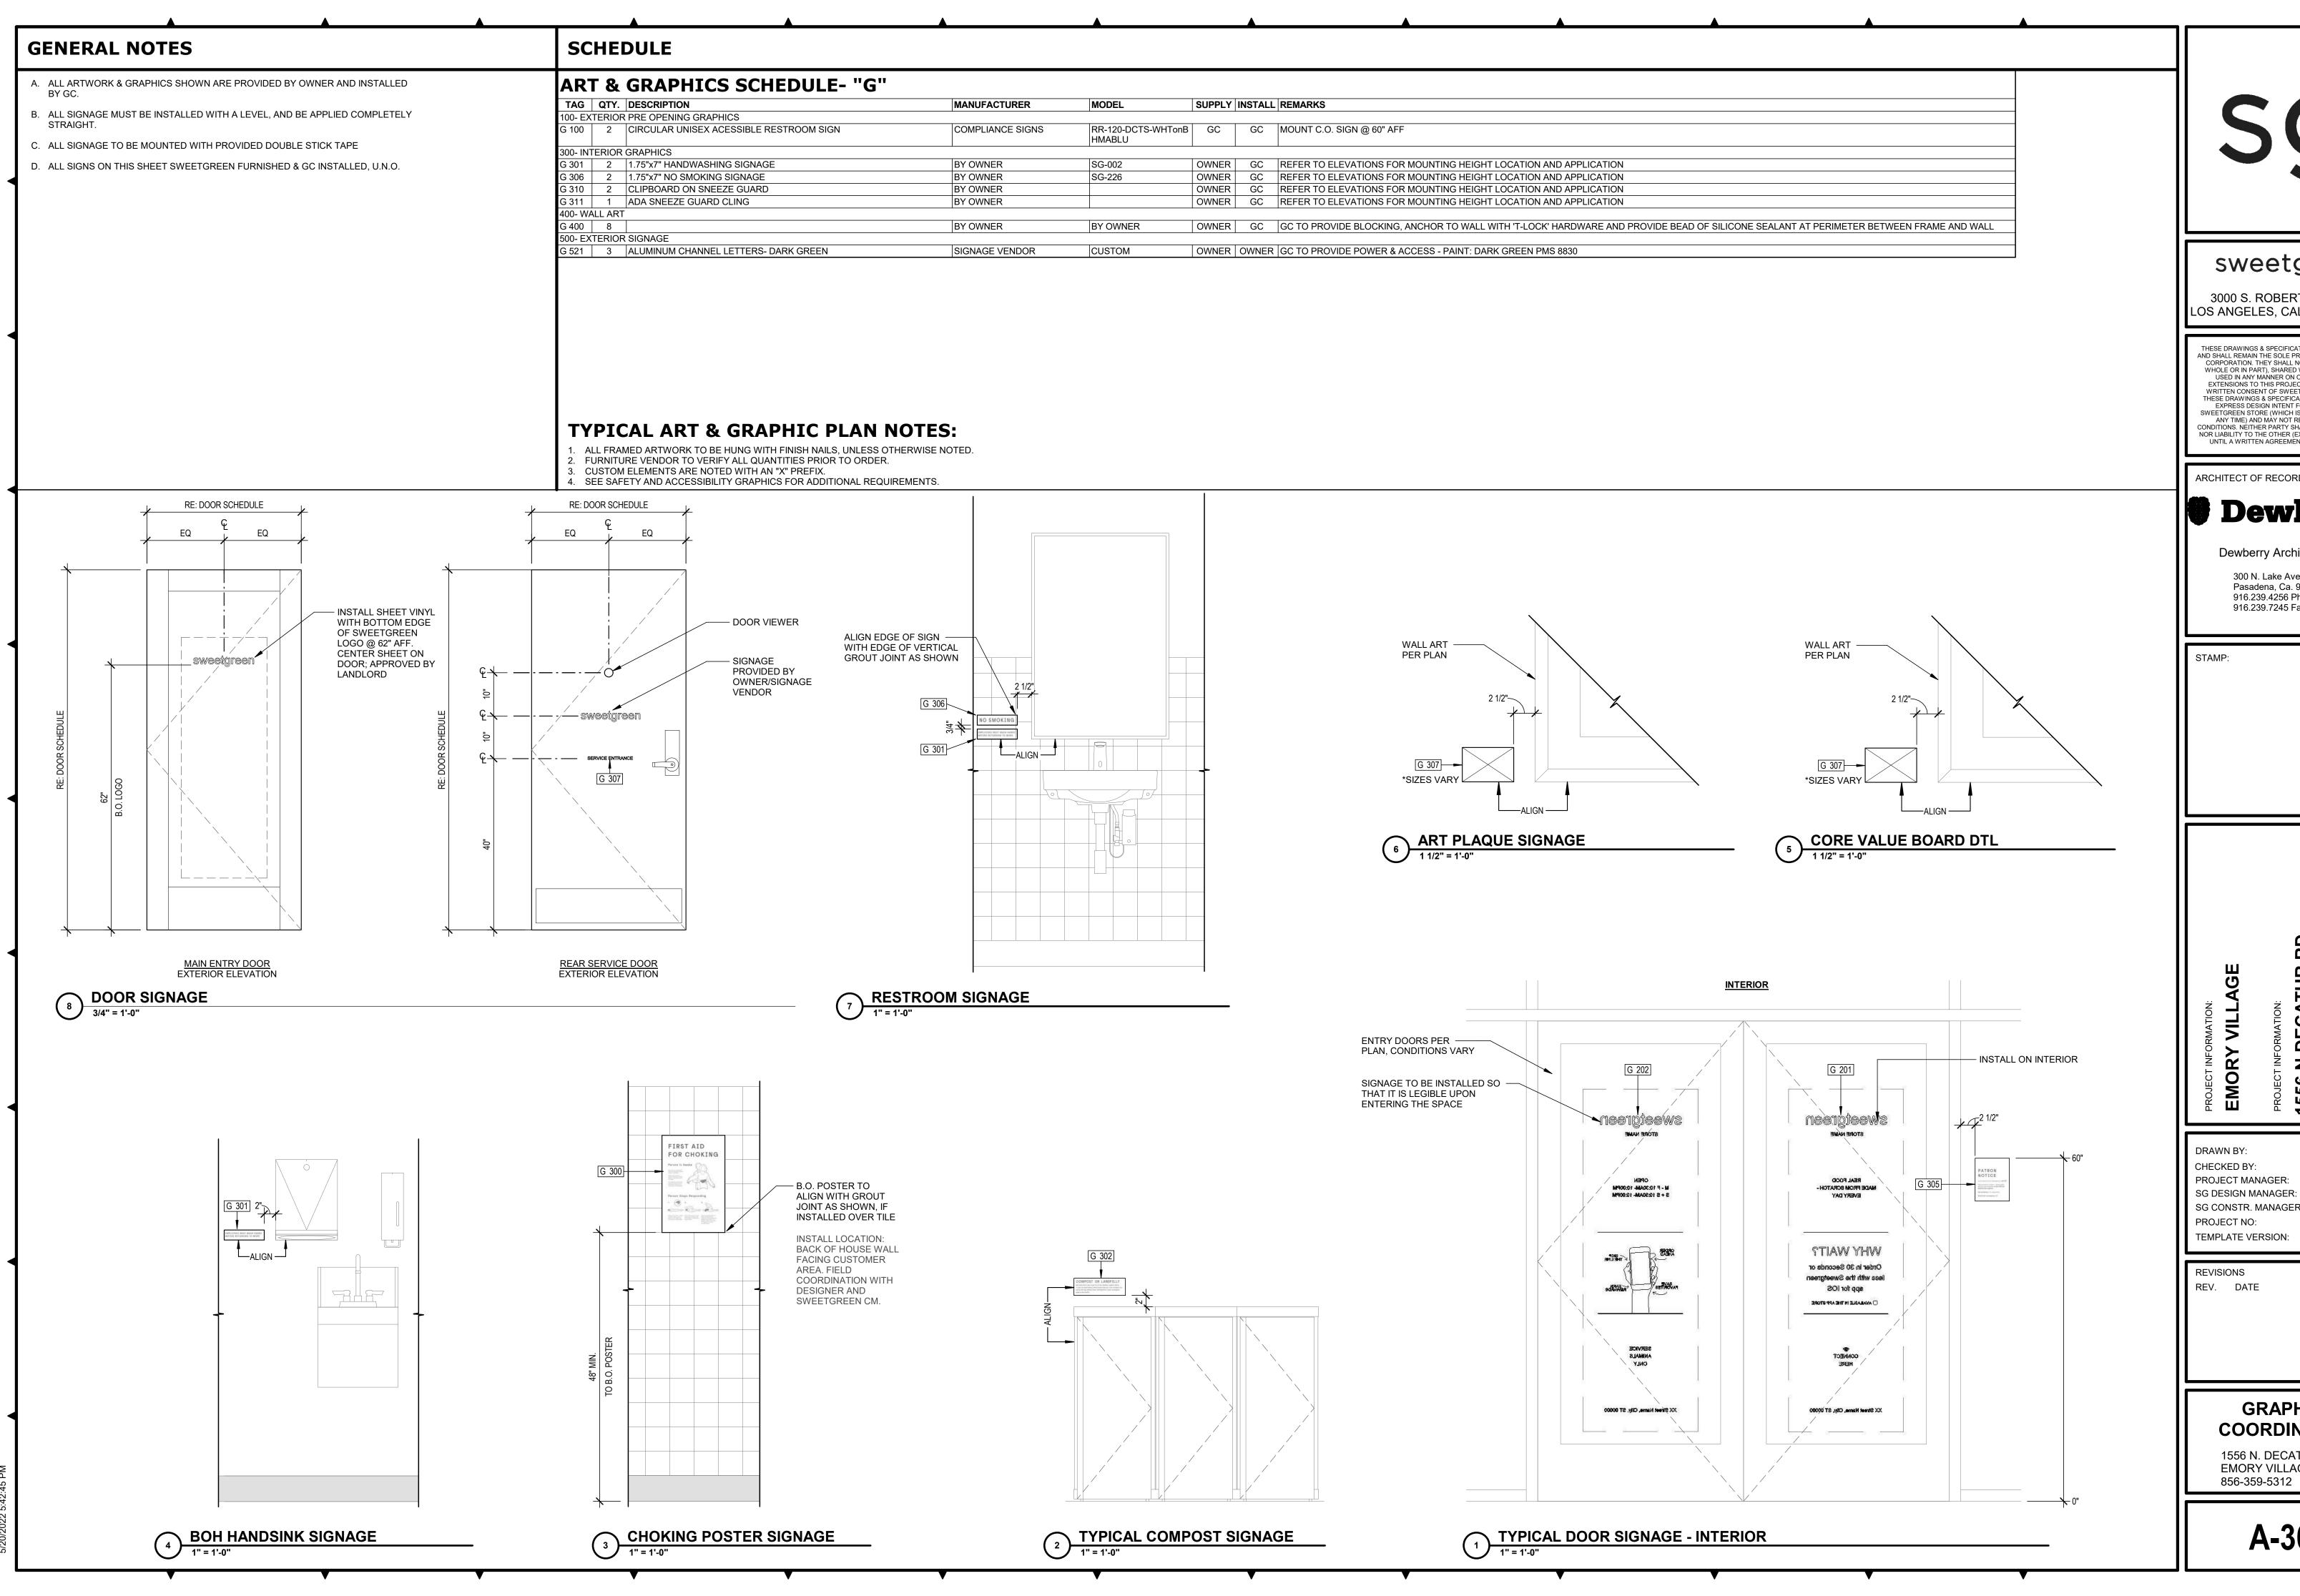
PROJECT MANAGER: SG DESIGN MANAGER: SG CONSTR. MANAGER: 50139167 05.06.2022

REV. DATE

DESCRIPTION

**SAFETY AND ACCESSIBILITY GRAPHICS** 

1556 N. DECATUR ROAD EMORY VILLAGE, LLC 856-359-5312



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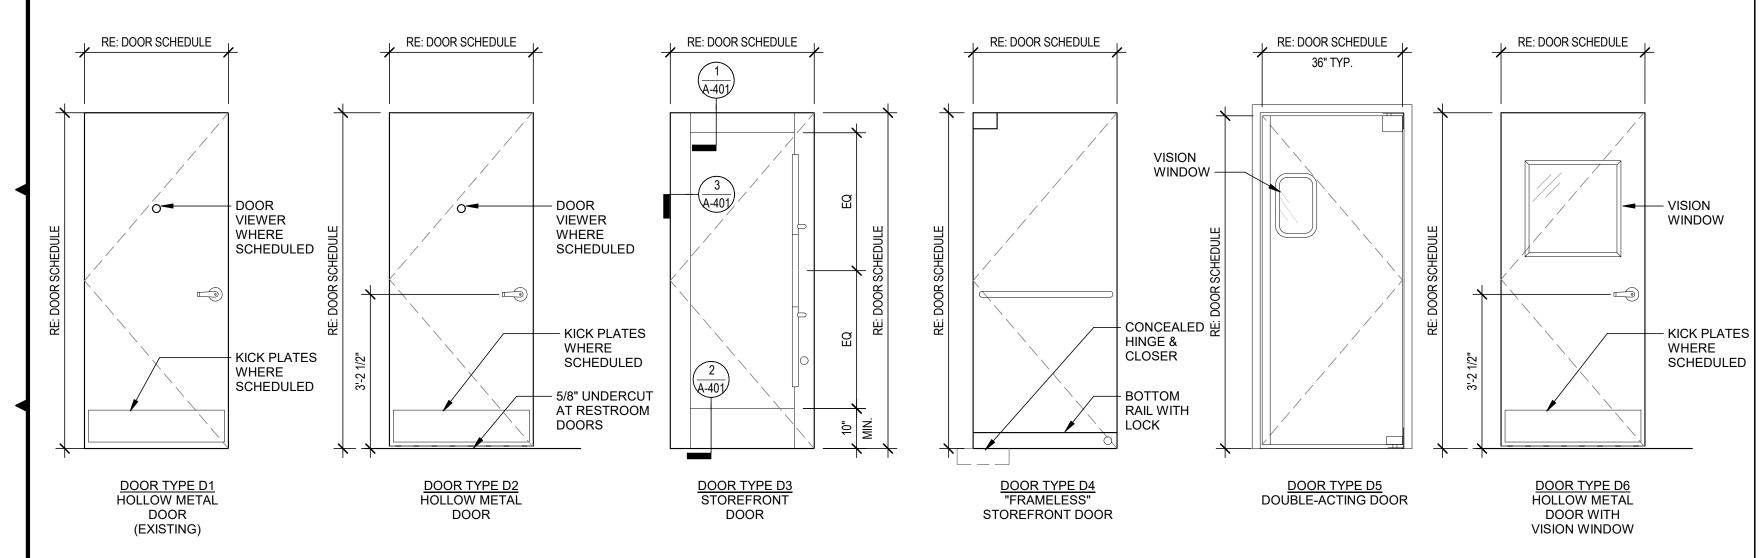
DESCRIPTION

**GRAPHICS** COORDINATION


1556 N. DECATUR ROAD EMORY VILLAGE, LLC 856-359-5312

		7.05		OOR	<b>T</b> 11101/	FRAME		DOOL	R HARDWARE SCHEDULE 1	(STOREFRONT ENTR	Y EXTERIOR)
<b>AG</b> 01	DESCRIPTION	TYPE D3	<b>WIDTH</b> 6' - 0"	<b>HEIGHT</b> 6' - 10"	<b>THICK</b> 1 3/4"	TYPE F2	HW SET NOTES		ITEM	MANUFACTURER	MODEL NO.
2		D2	3' - 0"	7' - 0"	1 3/4"	F1		2	DOOR CLOSER	LCN	CONCEALED CLOSER MODEL 2031
Ļ		D2	3' - 0"	7' - 0"	1 3/4"	F1			MORTISE CYLINDER	SCHLAGE	80-103, C.O. CYLINDER @ 22" FROM B.O. DOOR
5		D2	3' - 0"	7' - 0"	1 3/4"	F1		1	TEMPORARY CORE	SCHLAGE	80-035, INTERCHANGEABLE CORES
7		D2	3' - 0"	7' - 0"	1 3/4"	F1		2	CONTINUOUS HINGE	HAGER	780-224HD
								1	EXIT INDICATOR	ADAMS RITE	MS1850S-210-335
								4	DOOR PULL	BY OWNER	CUSTOM WOOD/METAL OFFSET PULL
								2	DOOR STOP	ROCKWOOD	MODEL 462
								2	DOOR SWEEP	PEMKO	MODEL SFSC-200-36 (36" DOOR)
								DOO	R HARDWARE SCHEDULE 2	(SERVICE DOOR EXTI	ERIOR)
								QTY.	ITEM	MANUFACTURER	MODEL NO.
								1	DOOR CLOSER	DORMA	7414AR
								1	LOCKSET	SCHLAGE	AL70PD, SATURN
								1	DOOR VIEWER	DOOR SCOPE	DS2000 ALS. C.O. VIEWER @ 60" FROM B.O. DOOF
								2	KICKPLATE	HIAWATHA	KP8X34-32D
								1	DOOR STOP	ROCKWOOD	MODEL 462
								1	DOOR SILENCER	IVES	SR64
	NEDAL NA	TEC						DOOI	R HARDWARE SCHEDULE 3	(UTILITY DOOR INTER	RIOR)
JC	NERAL NO	) I E S						QTY.	ITEM	MANUFACTURER	MODEL NO.
								1	DOOR CLOSER	DORMA	7414AR
							OF A KEY, SPECIAL KNOWLEDGE OR EFFORT. FLUSH BOLTS OR SUR OF ANY LEAF SHALL NOT REQUIRE MORE THAN ONE OPERATION. (10		LOCKSET	SCHLAGE	AL70PD, SATURN
							S THE REQUIREMENTS OF SECTION 1003.3.1.9	3	HINGES	STANLEY	FBB179
							1" LETTERING STATING: "THIS DOOR MUST REMAIN UNLOCKED WHE	N 2	KICKPLATE	HIAWATHA	KP8X34-32D
	CCUPIED" MAIN EXIT				/ADE \A/!!	00140174	WITH OF OTION 7.0 OF MEDA 404 DED THE ODEOLEIOATIONS	1	DOOR STOP	DON-JO	1407-630-US26D
							VITH SECTION 7.2 OF NFPA 101 PER THE SPECIFICATIONS. DE IN CASE OF AN EMERGENCY.	1	DOOR SILENCER	IVES	SR64
	L DOORS TO REMAIN AXIMUM EFFORT TO (					VITH CLOS	ERS SHALL NOT EXCEED 5 POUNDS. THIS MAY BE INCREASED TO 15	DOOI	R HARDWARE SCHEDULE 4	(RESTROOM)	
	OUNDS FOR FIRE-RAT							•	ITEM	MANUFACTURER	MODEL NO.
							HALL HAVE A SMOOTH UNINTERRUPTED SURFACE TO ALLOW THE D R HAZARDOUS CONDITION.	OOR 1	DOOR CLOSER	DORMA	7414AR
	L WINDOW AND DOC						N MALANDOUS CONDITION.	1	PUSH/PULL PLATES	IVES	8200/8305-4X16-US26D-AM <
W	INDOW AND DOOR G	AZING TO B	E TEMPERI	ED AT LOCA	ATIONS IN	DICATED V		1	OCCUPANCY INDICATOR		B571626
			,			EY BOX FO	R OFFICE, SIZED TO HOLD ALL KEYS.	3	HINGES	STANLEY	FBB179
	NYL GRAPHICS SUPP INDINGS AT DOORS T		,					2	KICKPLATE	HIAWATHA	KP8X34-32D
ΙΛ	ITH THE EXCEPTION (					BE KEYEI	ALIKE.	1	DOOR STOP	DON-JO	1407-630-US26D
				AR DOORS	_			ı 1	DOOR SILENCER	IVES	SR64

NOTE TO AOR: CODED LOCKS ONLY FOR SPECIFIC DESIGNATED PROJECTS, WHEN REQUIRED SPECIFY: LOCKSET, SCHLAGE, AD-200-CY-40-KP-ATH-626AM (SPECIFY LEFT OR RIGHT HANDED)



## FRAME TYPES

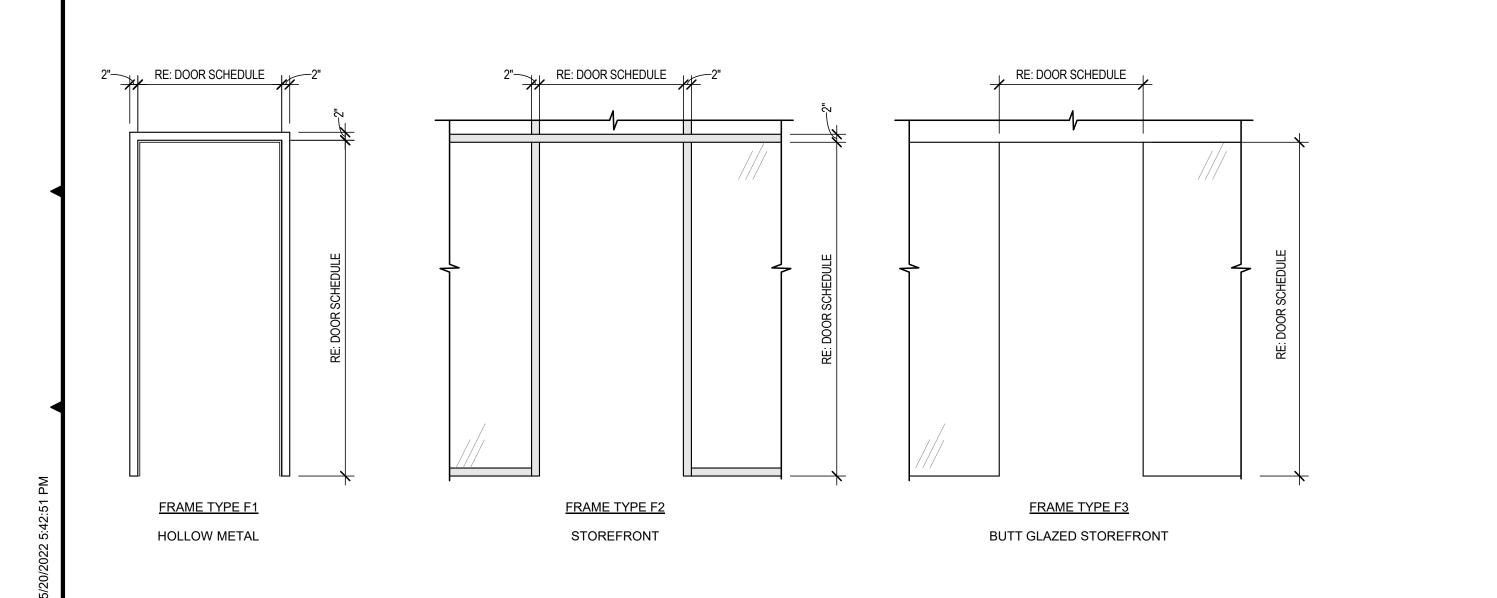

## sweetgreen

3000 S. ROBERTSON BLVD. LOS ANGELES, CALIFORNIA 90034

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ARCHITECT OF RECORD:

## **Dewberry**

Dewberry Architects Inc.

300 N. Lake Ave, 12th Floor Pasadena, Ca. 91101 916.239.4256 Phone 916.239.7245 Fax

STAMP:

XX.XX.XXXX

ATUR RD, DEC/ Z 1556

DRAWN BY: CHECKED BY: PROJECT MANAGER: SG DESIGN MANAGER: SG CONSTR. MANAGER: PROJECT NO: 50139167 TEMPLATE VERSION: 05.06.2022


REVISIONS

REV. DATE

## **DOORS & WINDOWS**

DESCRIPTION

1556 N. DECATUR ROAD EMORY VILLAGE, LLC 856-359-5312

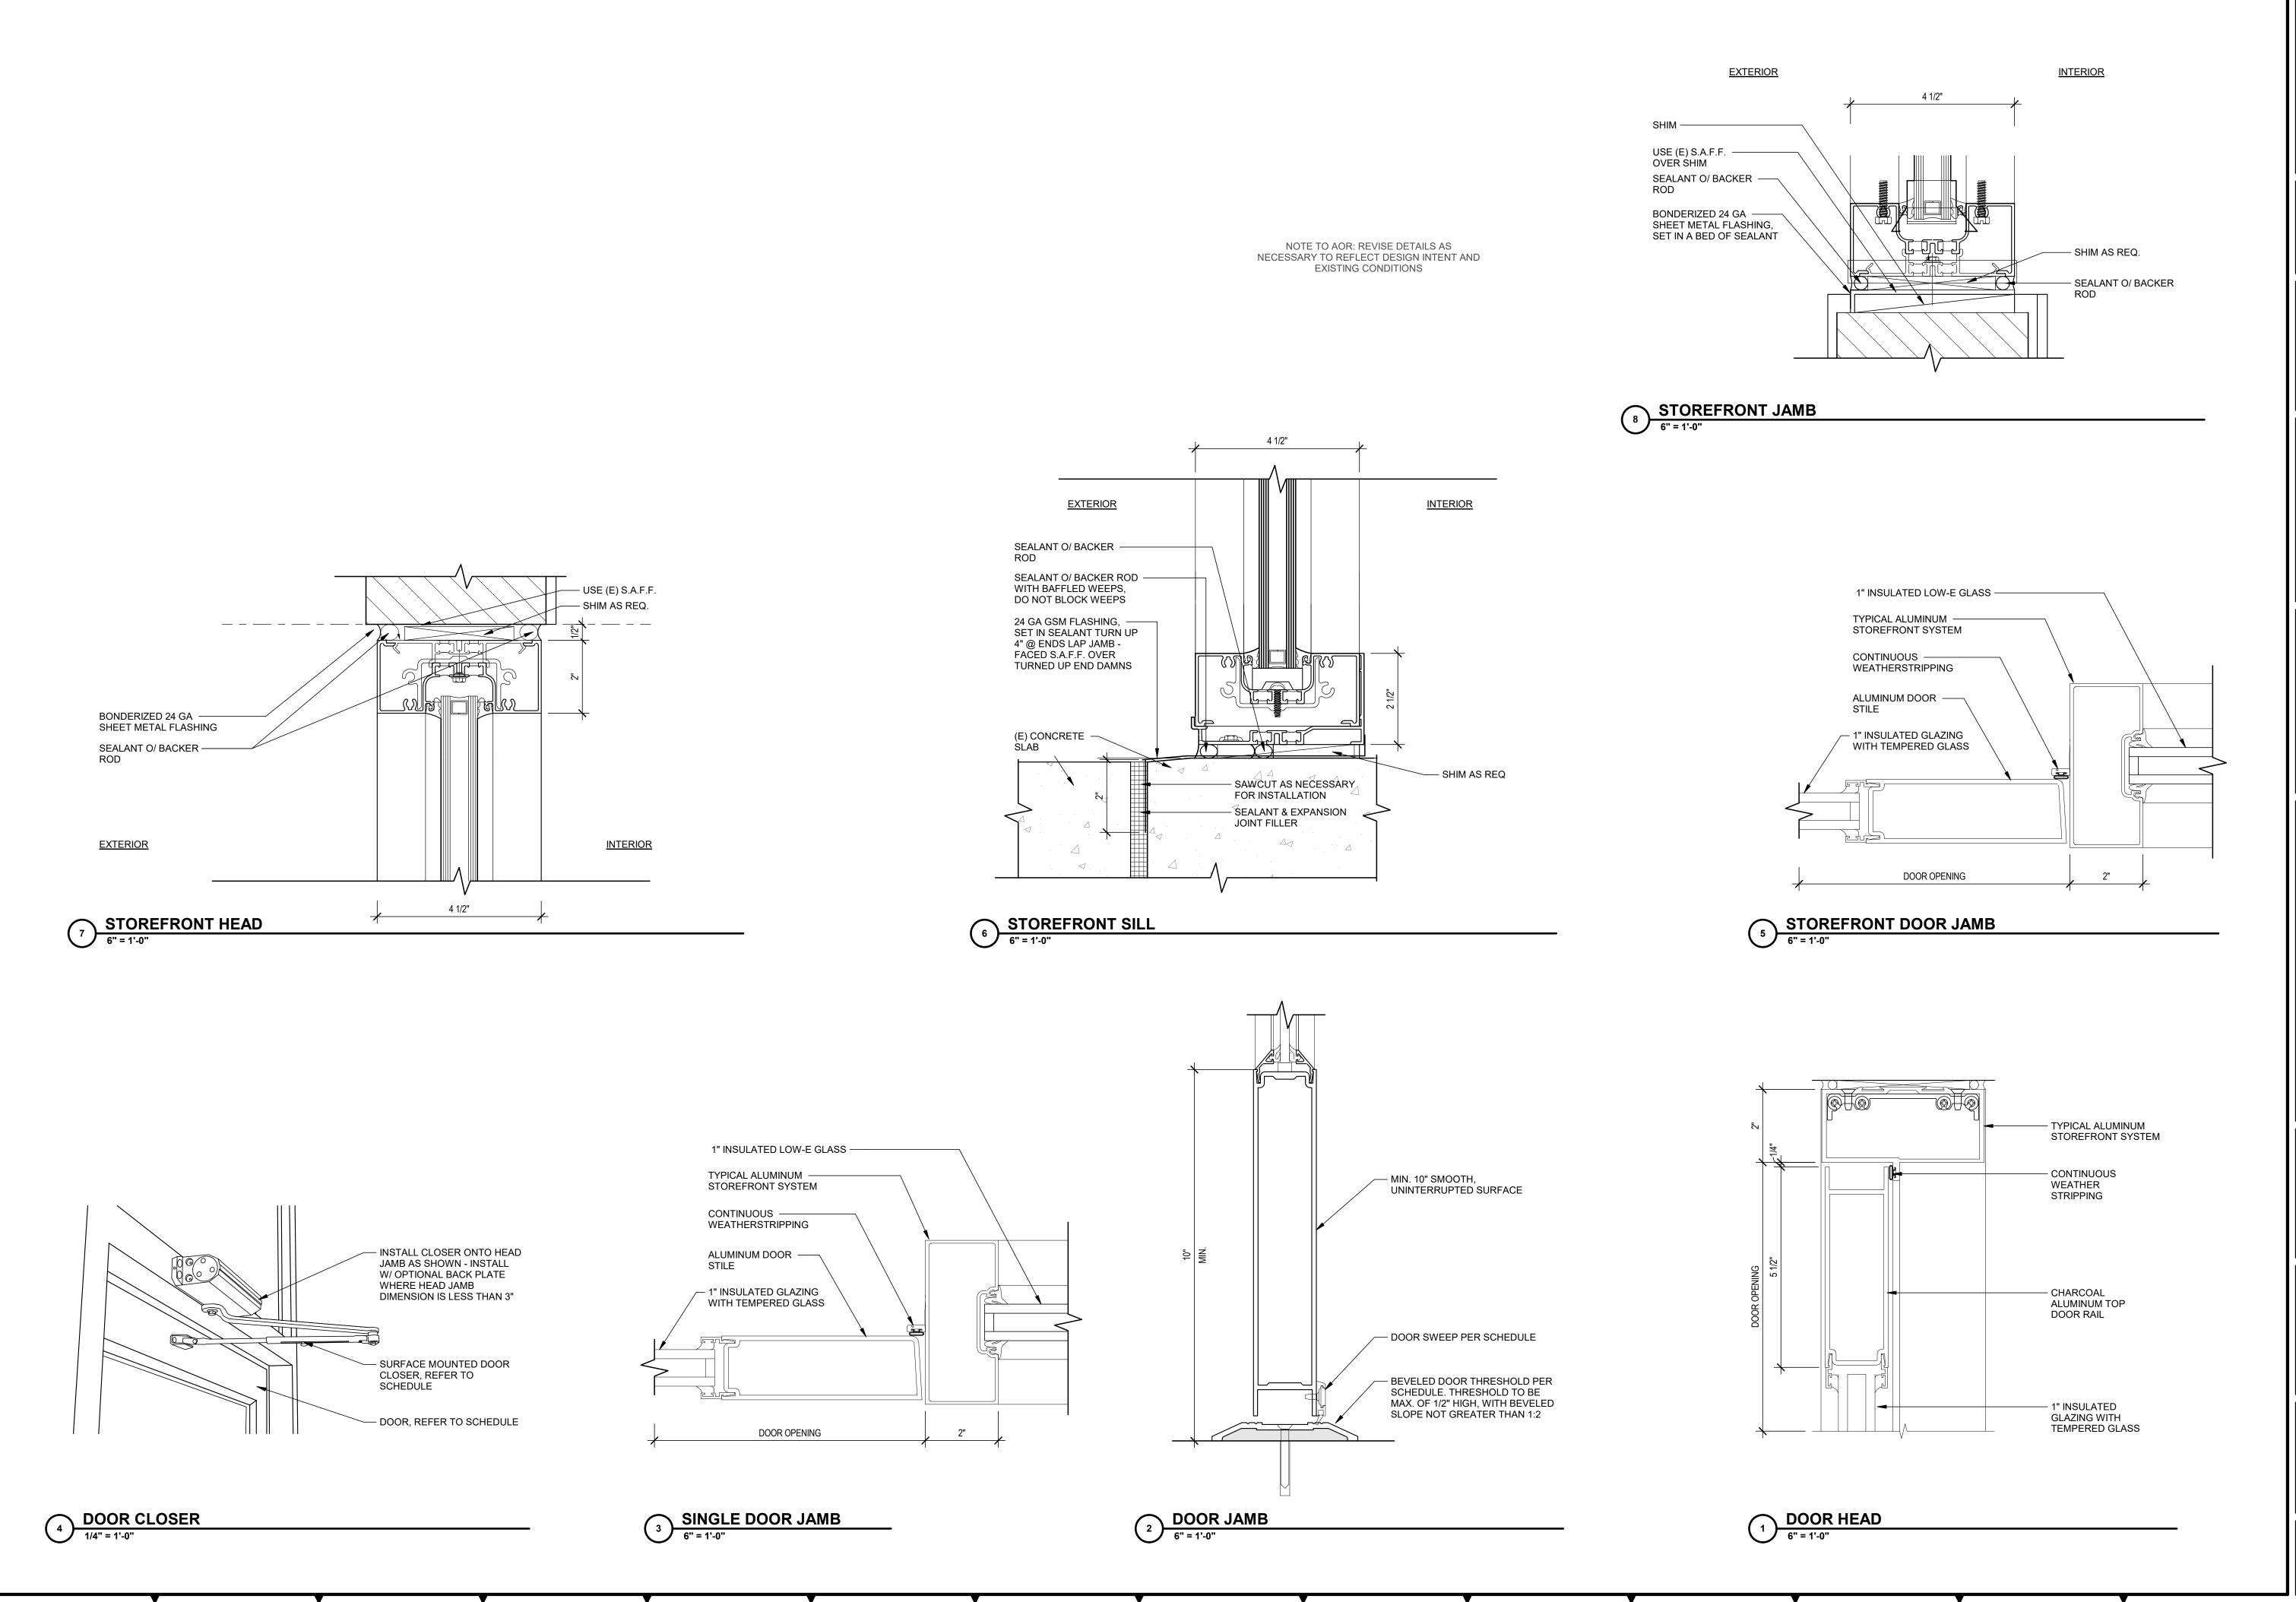

Sg

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ARCHITECT OF RECORD:

## Dewberry

Dewberry Architects Inc.
300 N. Lake Ave, 12th Floor

300 N. Lake Ave, 12th Floor Pasadena, Ca. 91101 916.239.4256 Phone 916.239.7245 Fax

STAMP:

XX.XX.XXXX

ON: SATUR RD,

PROJECT INFORMATION:
1556 N DECATU


DRAWN BY: TF
CHECKED BY: JW
PROJECT MANAGER: ZM
SG DESIGN MANAGER: LG
SG CONSTR. MANAGER: JD
PROJECT NO: 50139167
TEMPLATE VERSION: 05.06.2022

REVISIONS

REV. DATE DESCRIPTION

DOOR & WINDOW DETAILS

1556 N. DECATUR ROAD EMORY VILLAGE, LLC 856-359-5312

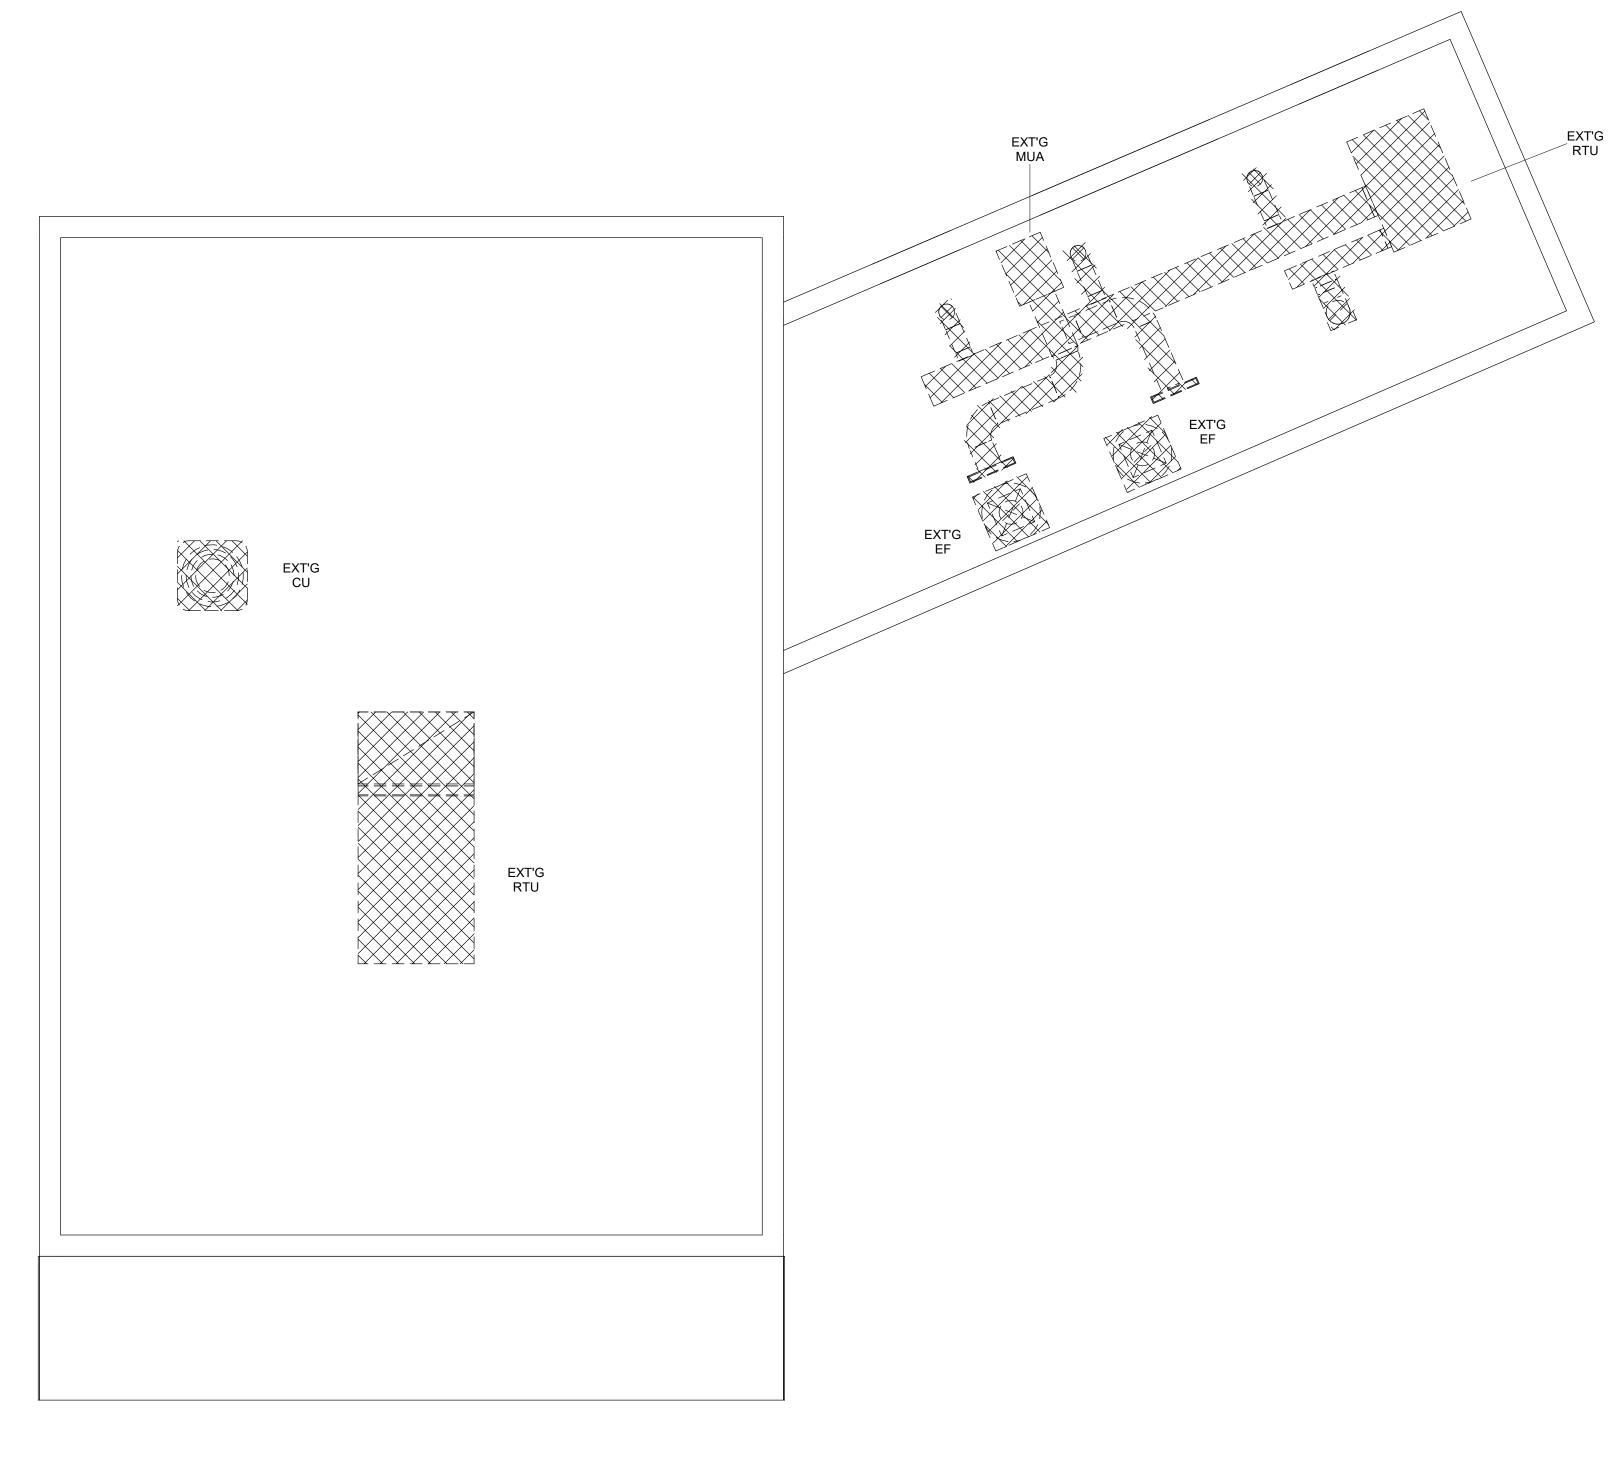



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ARCHITECT OF RECORD:



Dewberry Architects Inc.

1760 Creekside Oaks Dr. Sacramento, Ca. 95833 Ste. 280 916.239.7244 Phone 916.239.7245 Fax

STAMP:

XX.XX.XXXX

\_\_\_\_\_

MORY VILLAGE

OJECT INFORMATION:

RD,

DECATUR

Z

DRAWN BY: CW
CHECKED BY: DBS
PROJECT MANAGER: XX
SG DESIGN MANAGER: XX

PROJECT MANAGER: XX
SG DESIGN MANAGER: XX
SG CONSTR. MANAGER: XX
PROJECT NO: 50139167
TEMPLATE VERSION: 06.01.2020

REVISIONS
REV. DATE DESCRIPTION
05/20/2022 80% PROGRESS SET

## HVAC DEMO ROOF PLAN


SALAS O'BRIEN

3200 WINDY HILL RD SE, STE 200E ATLANTA, GA 30339-8435 404 881 5300 2021-02355 1556 N. DECATUR ROAD EMORY VILLAGE, LLC 856-359-5312

**M-200** 

H - HVAC Demolition Roof Plan

TRUE PLAN
NORTH NORTH

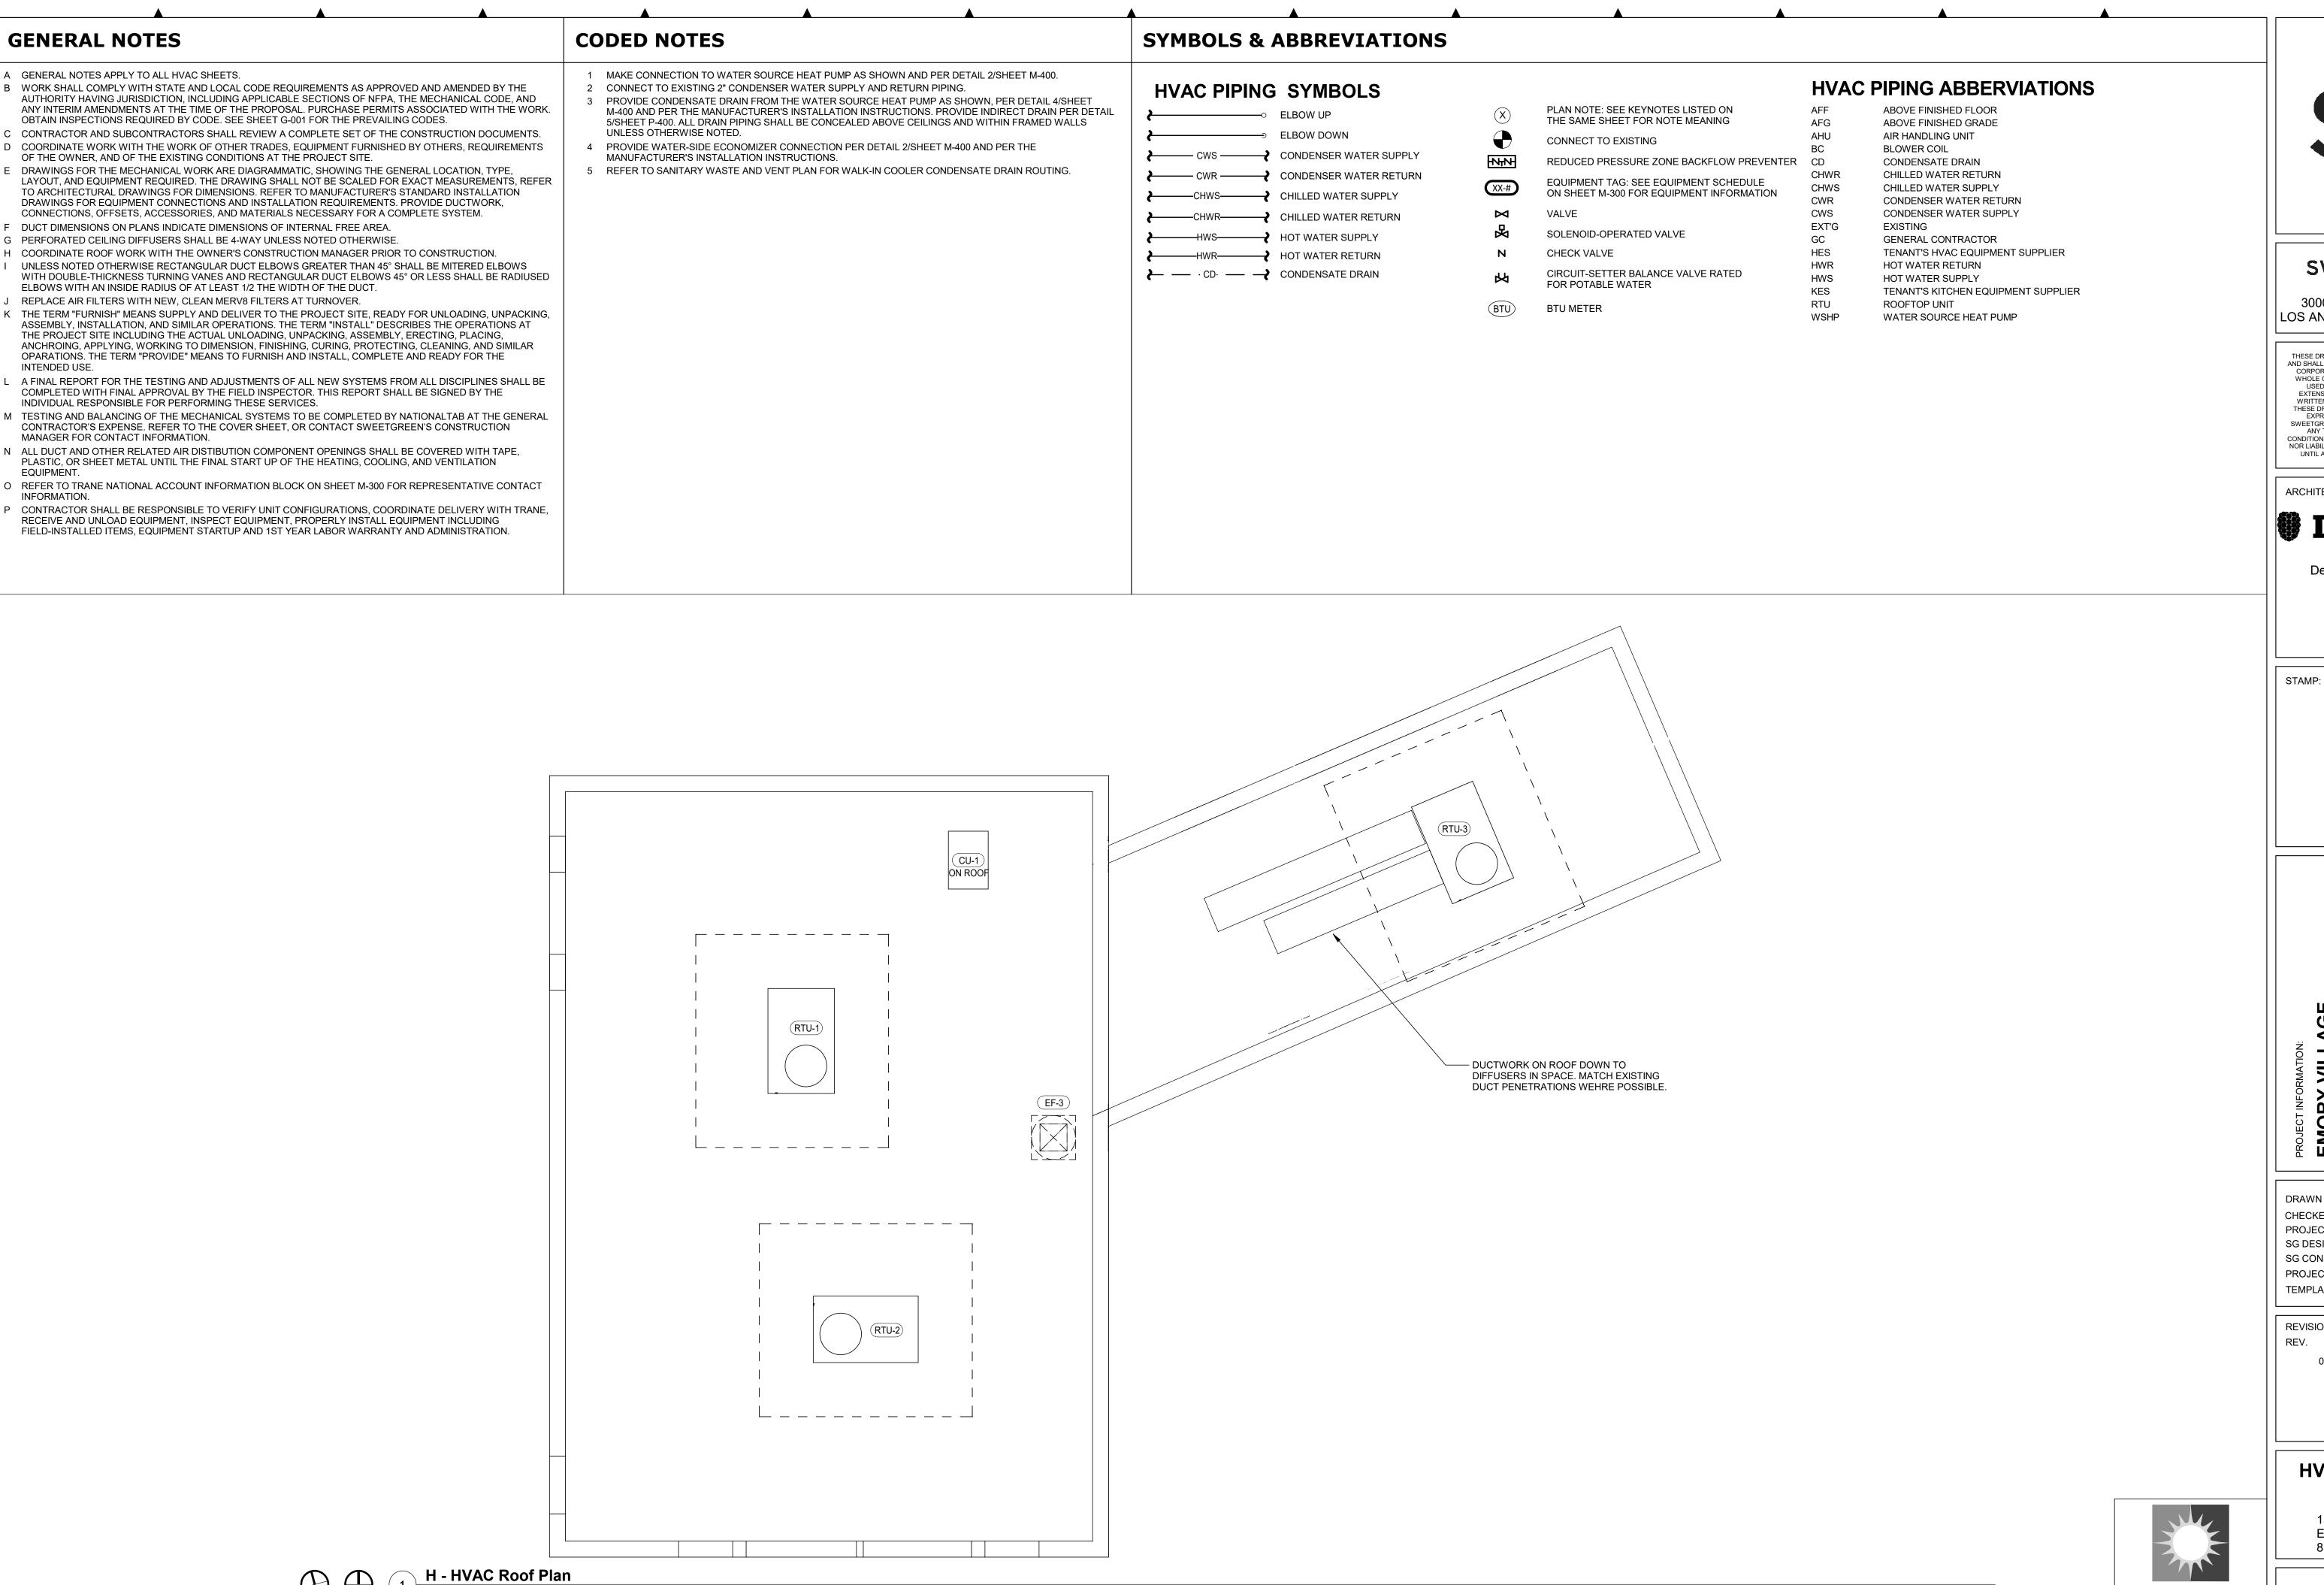

NORTH NORTH

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XX.XX.XXXX

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CW

DRAWN BY: CHECKED BY: PROJECT MANAGER: SG DESIGN MANAGER: SG CONSTR. MANAGER: PROJECT NO: TEMPLATE VERSION: 06.01.2020

REVISIONS REV. DATE

SALAS O'BRIEN

3200 WINDY HILL RD SE, STE 200E ATLANTA, GA 30339-8435 404 881 5300 2021-02355

DESCRIPTION 05/20/2022 80% PROGRESS SET

**HVAC ROOF PLAN** 

1556 N. DECATUR ROAD EMORY VILLAGE, LLC 856-359-5312

M-201



Southwest Corner of the building



Southeast corner of the building and adjacent property



Partial south elevation behind adjacent property at east



North side of building



West side of building





West side of building



South side of building – Patio area



South side - Patio area and fence