

Development Services Center 178 Sams Street Decatur, GA 30030 www.dekalbcountvga.gov/planning 404-371-2155 (o); 404-371-4556 (f)

Chief Executive Officer
Michael Thurmond

#### DEPARTMENT OF PLANNING & SUSTAINABILITY

Interim Director Cedric Hudson

#### **Application for Certificate of Appropriateness**

Date Received: 6/13/2013 Application No.:
Address of Subject Property: 923 Barton Woods Road, Atlanta, GA 30307
Applicant: Jorge Roblero E-Mail: Jorge Othelandmortyp.
Applicant Mailing Address: 3569 Kellogo Creetz Road
Applicant Phone: 470 -315 - 1377 Fax:
Applicant's relationship to the owner: Owner  Architect: Contractor/Builder Other
Owner(s): Ben Russell Campbell Email: 1ckirbo Ogmail.com
Owner(s): Eugene Arsley Jr. Email: geneansley agmail con
Owner(s) Mailing Address:
Owner(s) Telephone Number:
Approximate age or date of construction of the primary structure on the property and any secondary structures affected by this project:
Nature of work (check all that apply):
New construction □ Demolition □ Addition □ Moving a building □ Other building □ Other building □ Other environmental Changes □ Sign installation or replacement □ Other ☑
Description of Work:
Exterior home remodel windows and doors, no enanges to existing structure as discussed. Exterior painting.
This form must be completed in its entirety and be accompanied by supporting documents, such as plans, list of materials, color samples, photographs, etc. All documents should be in PDF format, except for photographs, which may be in JPEG format. Email the application and supporting material to <a href="mailto:plansustain@dekaibcountyga.gov">plansustain@dekaibcountyga.gov</a> and <a href="mailto:ribragg@dekaibcountyga.gov">ribragg@dekaibcountyga.gov</a> An incomplete application will not be accepted.
Signature of Applicant:



#### Authorization of a Second Party to Apply for a Certificate of Appropriateness

This form is required if the individual making the request is not the owner of the property.

I/ We: Eugene B. Ansley, Ir and Ben R. Campbell

being owner(s) of the property at: 923 Barton woods Road

hereby delegate authority to: <u>lorge Roblero, project coordinator, The Landmark Group, our renovation</u>

contractor to file an application for a certificate of appropriateness in my/our behalf.

Signature of Owner(s):

Date: \_\_6/15/2023

#### Please review the following information

Approval of this Certificate of Appropriateness does not release the recipient from compliance with all other pertinent county, state, and federal regulations.

Before making any changes to your approved plans, contact the preservation planner (404/371- 2155). Some changes may fall within the scope of the existing approval, but others will require review by the preservation commission. If work is performed which is not in accordance with your certificate, a Stop Work Order may be issued.

If your project requires that the county issue a Certificate of Occupancy at the end of construction, an inspection may be made to verify that the work has been completed in accord with the Certificate of Appropriateness. If the work as completed is not the same as that approved in the Certificate of Appropriateness you will not receive a Certificate of Occupancy. You may also be subject to other penalties including fines and/or required demolition of the non-conforming work.

If you do not commence construction within twelve months of the date of approval, your Certificate of Appropriateness will become void and you will need to apply for a new certificate if you still intend to do the work.

#### How to Obtain a Certificate of Appropriateness

- 1. Contact the DeKalb County Department of Planning and Sustainability for an application form. You may make your request by email <a href="mailto:plansustain@dekalbcountyga.gov">plansustain@dekalbcountyga.gov</a> AND <a href="mailto:rlbragg@dekalbcountyga.gov">rlbragg@dekalbcountyga.gov</a>. telephone (404) 371-2247, or fax (404) 371-2813, or visit the website at <a href="https://www.dekalbcountyga.gov/planning-and-sustainability/forms">https://www.dekalbcountyga.gov/planning-and-sustainability/forms</a>
- 2. Complete and submit the application. Please provide as much supporting material as possible,(plans, material, color samples, photos, etc.). All documents must be in PDF format except for photographs, which may be in JPEG format. Applications are accepted for a 10-day period each month. See page 3 (HPC Calendar). Email the application and supporting documents to <a href="mailto:plansustain@dekalbcountyga.gov">plansustain@dekalbcountyga.gov</a> AND <a href="mailto:ribragg@dekalbcountyga.gov">ribragg@dekalbcountyga.gov</a>. If all documents are not provided the application will not be complete and will not be accepted.
- 3. The Preservation Planner will post a sign on the property at least ten days before the preservation commission meeting or coordinate sign posting with the applicant.
- 4. The Preservation Planner will visit the property as part of their review. The commission members may view the property from the right-of-way.
- 5. Applications will be reviewed by the DeKalb County Historic Preservation Commission at its monthly meeting. The Historic Preservation Commission meets on the third Monday at 6 p.m., via Zoom. In unusual circumstances meeting dates and location may be changed.
- 6. The Historic Preservation Commission may approve, approve with modifications or deny an application. The applicant or any affected person as defined by county code may appeal the decision to the DeKalb County Board of Commissioners. Please contact the Department of Planning and Sustainability if you wish to file an appeal. The Historic Preservation Commission is required to make a decision on an application within 45 days of the date of filing, although this time can be extended if the applicant agrees to a deferral.
- 7. Although not required, applicants are encouraged to attend the Historic Preservation Commission meetings. Applicants may make a presentation, but presentations are not required. The commissioners may have questions for the applicant.
- 8. Approval of a Certificate of Appropriateness does not release the recipient from compliance with all other county, state and federal regulations.



#### Design Checklist for a Certificate of Appropriateness

This checklist was created to help applicants prepare a complete application. Omissions and inaccurate information can lead to deferrals and/or denials of applications. Please review the checklist with the project's architect, designer, or builder. All items will not be applicable to all projects. New construction will involve all categories. One copy of drawings at scale (plus nine reduced sets) should be submitted.

Please address questions regarding applicability to your project to the DeKalb County Preservation Planner at 404-371-2155, e-mail dccullis@dekalbcountyga.gov and rlbragg@dekalbcountyga.gov.

Applicants are also referred to the DeKalb County website, <a href="http://www.dekalbcountyga.gov/planning-and-sustainability/planning-sustainability/planning-sustainability/">http://www.dekalbcountyga.gov/planning-and-sustainability/</a>.

	-		
I have reviewed the "Design Manual for the Druid Hills Local Historic District".	Υ		N
I have reviewed the DeKalb County Tree Ordinance.	Υ		N
I have reviewed applicable zoning codes regarding lot coverage, garage sizes, stream	Υ	/	N
buffers.			

#### 1. General

- a. Label all drawings with the address of the site, owners' name, and contact phone number.
- b. Number all drawings.
- c. Include a graphic scale on reductions.
- d. Date all revisions.
- e. Indicate all unverified numbers with +/- signs
- f. Include photos of the existing condition of the property.

#### 2. Site Plan (existing and proposed) to include:

- a. Topographical plan with significant trees sized and located;
- b. Setback compared to adjacent houses (ask surveyor to show corners of adjacent houses);
- c. Distance between houses;
- d. Facade width to finished face of material;
- e. Grading and elevations across site;
- f. Dirt removal or regrading if more than 18";
- g. Tree protection plan;
- h. Tree removal and replacement plan

#### 3. Driveways and Walkways

- a. Location and relationship to house;
- b. Width;
- c. Material;
- d. Curb cut and apron width



#### 4. Fences & Retaining Walls

- a. Placement on lot;
- b. Height of fence or wall. If retaining wall, height on both sides;
- c. Material;
- d. Railing if necessary

#### 5. Elevations and Floor Plans: << Indicate all unverified numbers with +/- signs>>

- a. Plans for all floors (drawn to scale, ¼"=1' preferred);
- b. House orientation on site plan;
- c. Scalable elevations for front, rear, left, right;
- d. Height, grade to ridge;
- e. Streetscape comparison showing heights of two flanking houses on each side;
- f. Height from grade to first floor level at all four corners;
- g. Height from grade or finished floor line to eaves at all four corners;
- h. Ceiling heights of each floor, indicating if rough or finished;
- i. Height of space between the ceiling and finished floor above;
- j. Two people of 5'-6" and 6' height shown;
- k. Landscaping plan

#### 6. Additions

- a. Placement shown on elevations and floor plan;
- b. Visibility from rights-of-way and paths;
- c. Photos of all facades;
- d. Design proportioned to main house;
- e. Landscaping plan;
- f. Materials and their combinations

#### 7. Roof Plan

- a. Shape and pitch of roof;
- b. Roofing material;
- c. Overhang;
- d. Louvers and vents;
- e. Chimney height and material

#### 8. Dormers

- a. Construction details provided;
- b. Shape and size of dormer (show dimensions on drawings);
- c. Overhang;
- d. Size of window(s), with nominal size of sash (show dimensions on drawings)

#### 9. Skylights

- a. Profile;
- b. Visibility from right-of-way;
- c. Material (plastic lens or glass);
- d. Shown in plan and elevation to scale



#### 10. Façade

- a. Consistency in style;
- Materials and their combinations brick size and color stone type and color fiber-cement (e.g., Hardie-plank) or wood siding shake or shingle other
- c. Height of foundation at corners;
- d. Ceiling heights comparable to area of influence: basement, first floor, second floor;
- e. Detailing: soldier course, brackets, fascia board; water table;
- f. Height from grade to roof ridge;
- g. Dimensions, proportions and placement of windows, doors

#### 11. Entrance

- a. Height and width of door;
- b. Design of door (e.g., 6-panel, craftsman);
- c. Material of door;
- d. Overhang;
- e. Portico height;
- f. Size and height of columns or posts;
- g. Railing

#### 12. Windows

- a. Consistent with original as well as the area of influence;
- b. Size and proportion similar to original;
- c. Pane orientation and size similar to original;
- d. Type (e.g., double hung, casement);
- e. Fenestration on walls visible from right-of-way;
- f. Simulated divided light (SDL) or true divided light (TDL): location of muntins between the glass, behind the glass or permanently affixed on exterior;
- g. Material of window and any cladding;
- h. Width of muntins compared to original (show dimensions on drawings);
- i. Shutters or canopies
- j. Dimensions of windows and doors.

#### 13. Materials

- a. Show all materials and label them on drawings;
- b. Provide samples of brick or stone;
- c. Provide samples if new or unusual materials



#### 14. Garages / Accessory Buildings


- a. Visibility from street;
- b. Placement on site;
- c. Scale, style appropriate for house;
- d. Show dimensions on drawings;
- e. Materials;
- f. Square footage appropriate for lot size;
- g. Garage door size and design
- h. Show height from grade to eaves and to top of roof

#### 15. Demolitions

- a. Provide documentation from engineer concerning feasibility of rehabilitation;
- b. Provide photographs of structure to be demolished;
- c. Provide plan for proposed redevelopment

Scope	Of Work			Applicable Codes
remodeling the exterior walls, home and is a	e existing 1 story ho	ome. There shall be <b>no change</b> to alteration of this home <b>does no</b>	Permit. The proposed design calls for the existing foundation walls, t leave the existing footprint of the	<ul> <li>International Building Code, 2018 Edition, with Georgia Amendments (2020)</li> <li>International Residential Code, 2018 Edition, with Georgia Amendments (2020)</li> <li>International Fire Code, 2018 Edition, with Georgia Amendments (2020)</li> <li>International Plumbing Code, 2018 Edition, with Georgia Amendments (2020)</li> <li>International Mechanical Code, 2018 Edition, with Georgia Amendments (2020)</li> <li>International Fuel Gas Code, 2018 Edition, with Georgia Amendments (2020)</li> <li>National Electrical Code, 2017 Edition, with no Georgia Amendments (Effective 1/1/2018)</li> <li>International Energy Code, 2015 Edition, with Georgia Supplements and Amendments (2020)</li> <li>International Swimming Pool and Spa Code, 2018 Edition, with Georgia Amendments (2020)</li> </ul>
Location Level 1 Totals	<b>Heated</b> 1710 <b>1710</b> sq/ft	Unheated	<b>Total</b> 1710 <b>1710</b> sq/ft	- NFPA 101, Life Safety Code 2018 Edition, with State Amendments (2020)  Design Firm
			3 Bedrooms 3 Baths	i20 Design Phone: (404) 717 9996 Email: thomasc@i20design.com



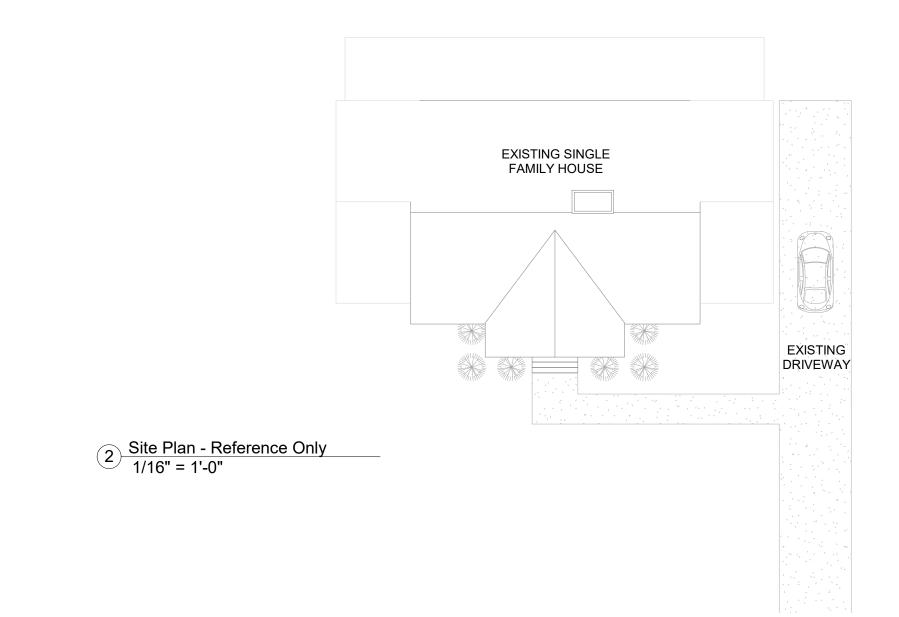



3 3D View - Front

Sheet #	Title	Date Issued
A000's	Cover Sheet & Perspectives	06/02/2023
B000's	Existing & Proposed Floor Plans	
C000's	Existing & Proposed Elevations	
D000's	Electrical Plans	
E000's	Foundation & Framing Plans	
F000's	Schedules	

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## Barton Woods Alteration The Ansley's Residence

923 Barton Woods Rd. NE Atlanta GA 30307


## Cover Sheet

Date 05/26/2023


Drawn By Author

A001

e As indicated

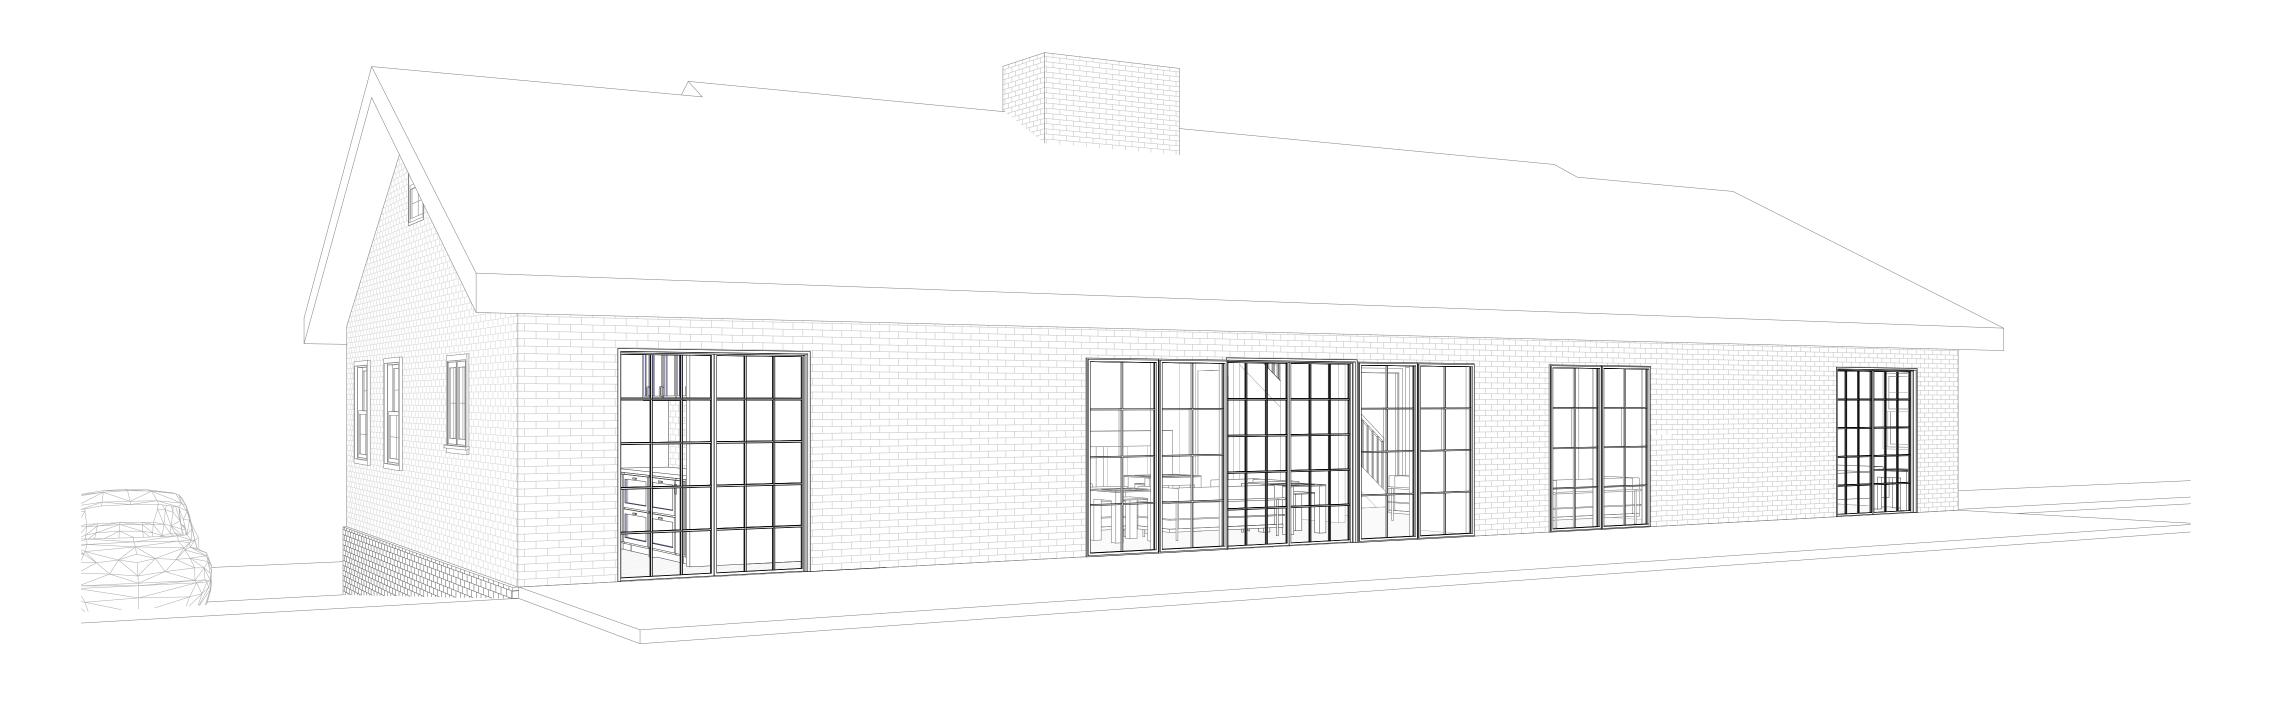

1 Rear Exterior Perspective 1

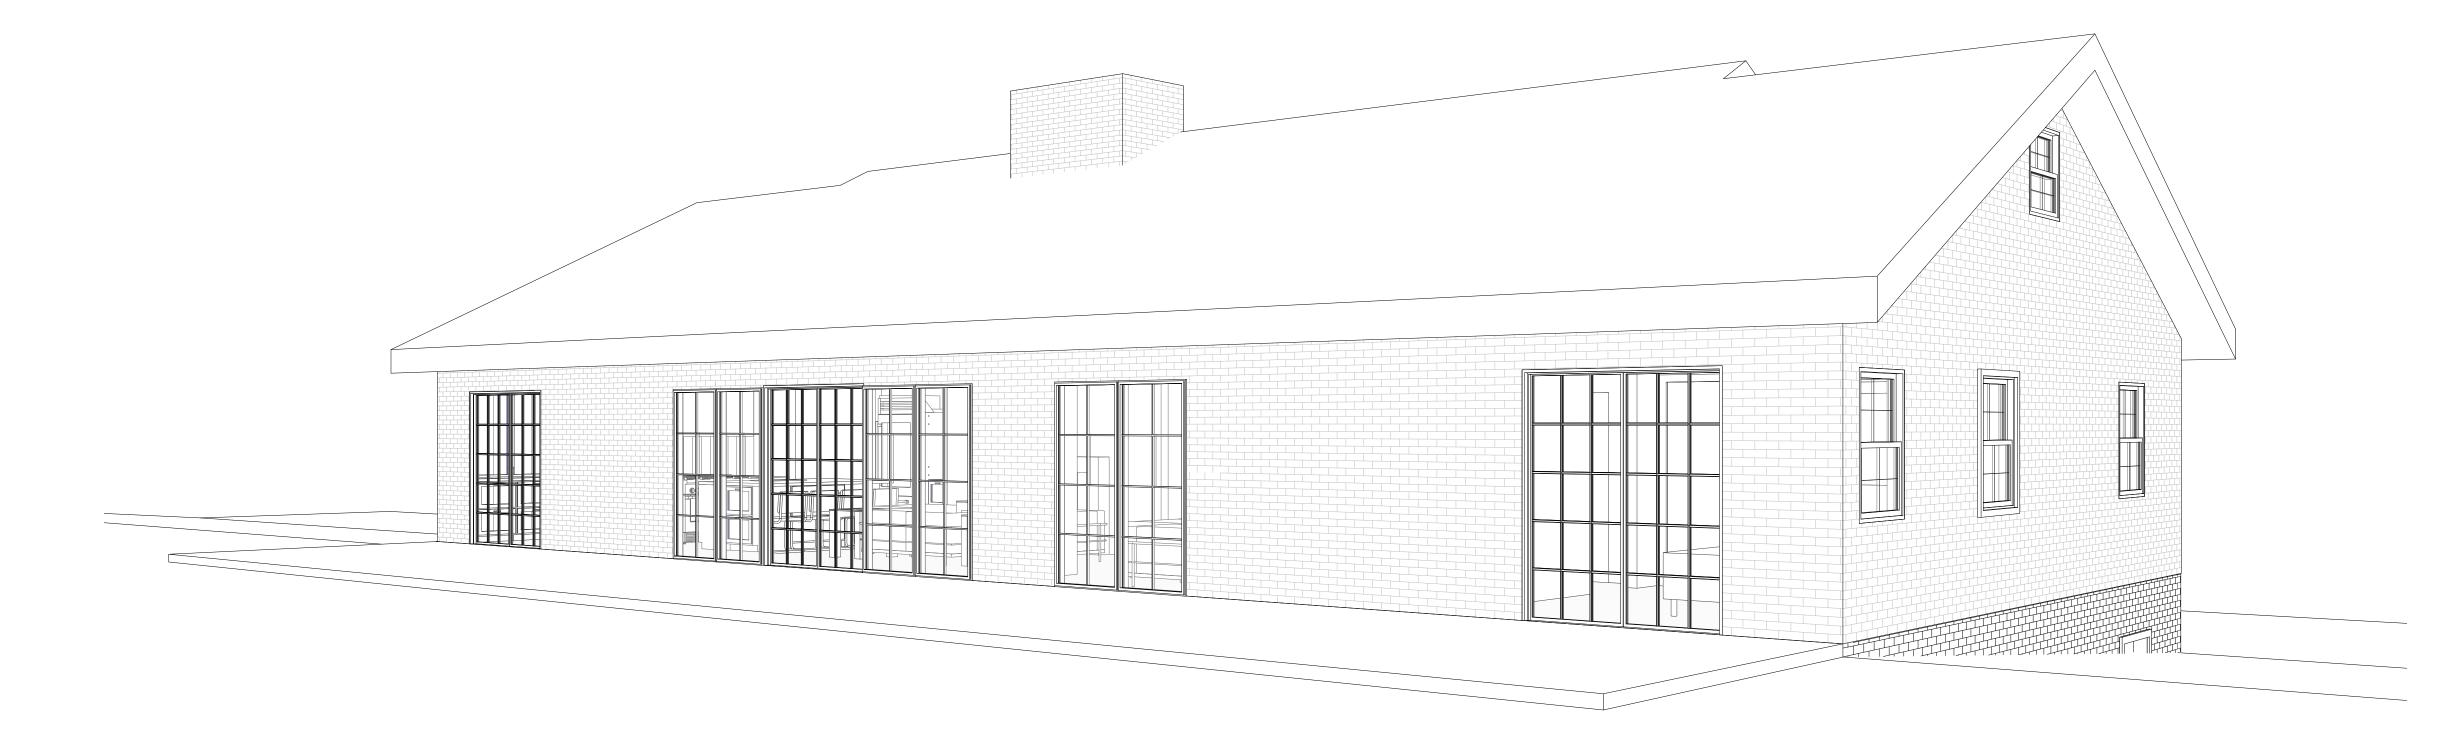

2 Rear Exterior Perspective 2

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D000's Ele		ectrical Plans		
E000's	Fo	undation & Framing Plans		
F000's	Sc	hedules		

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# Exterior Perspectives


Date 05/26/2023

Drawn By Author

A002

Scale



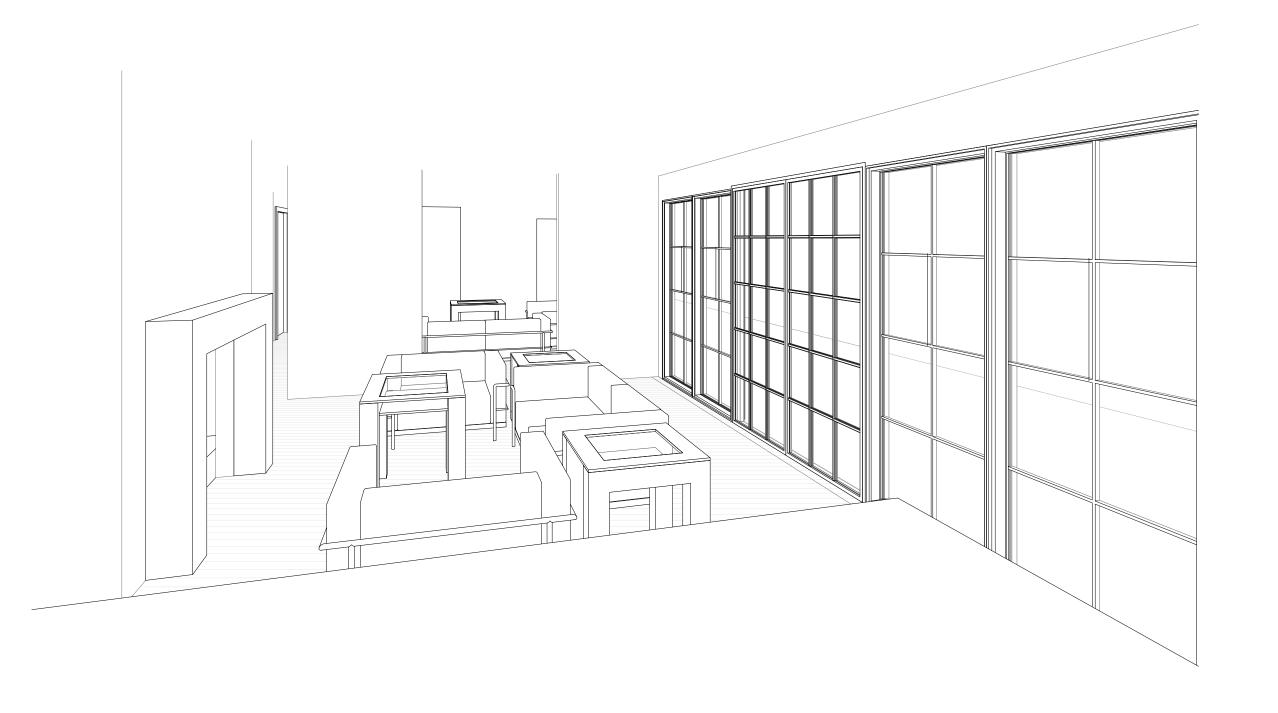

3 3D View - Front Door

2 3D View 1







4 3D View - Larder

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# Interior Perspectives

Date 05/26/2023

Drawn By Author

A003

Scale

Demo	olition Legend
	Demo
	New
	Existing

RELOCATE W&D: SEE SHEET BO04	NO CHANGE	

1) Existing + Proposed Plans - Basement Plan 1/4" = 1'-0"

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C000's	Ex	isting & Proposed Elevations	
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E000's	Fo	undation & Framing Plans	
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# Floor Plan - Existing Basement


Date 05/26/2023

Drawn By Author

B001

Scale 1/4" = 1'-0"

Demo	olition Legend
	Demo
	New
	Existing

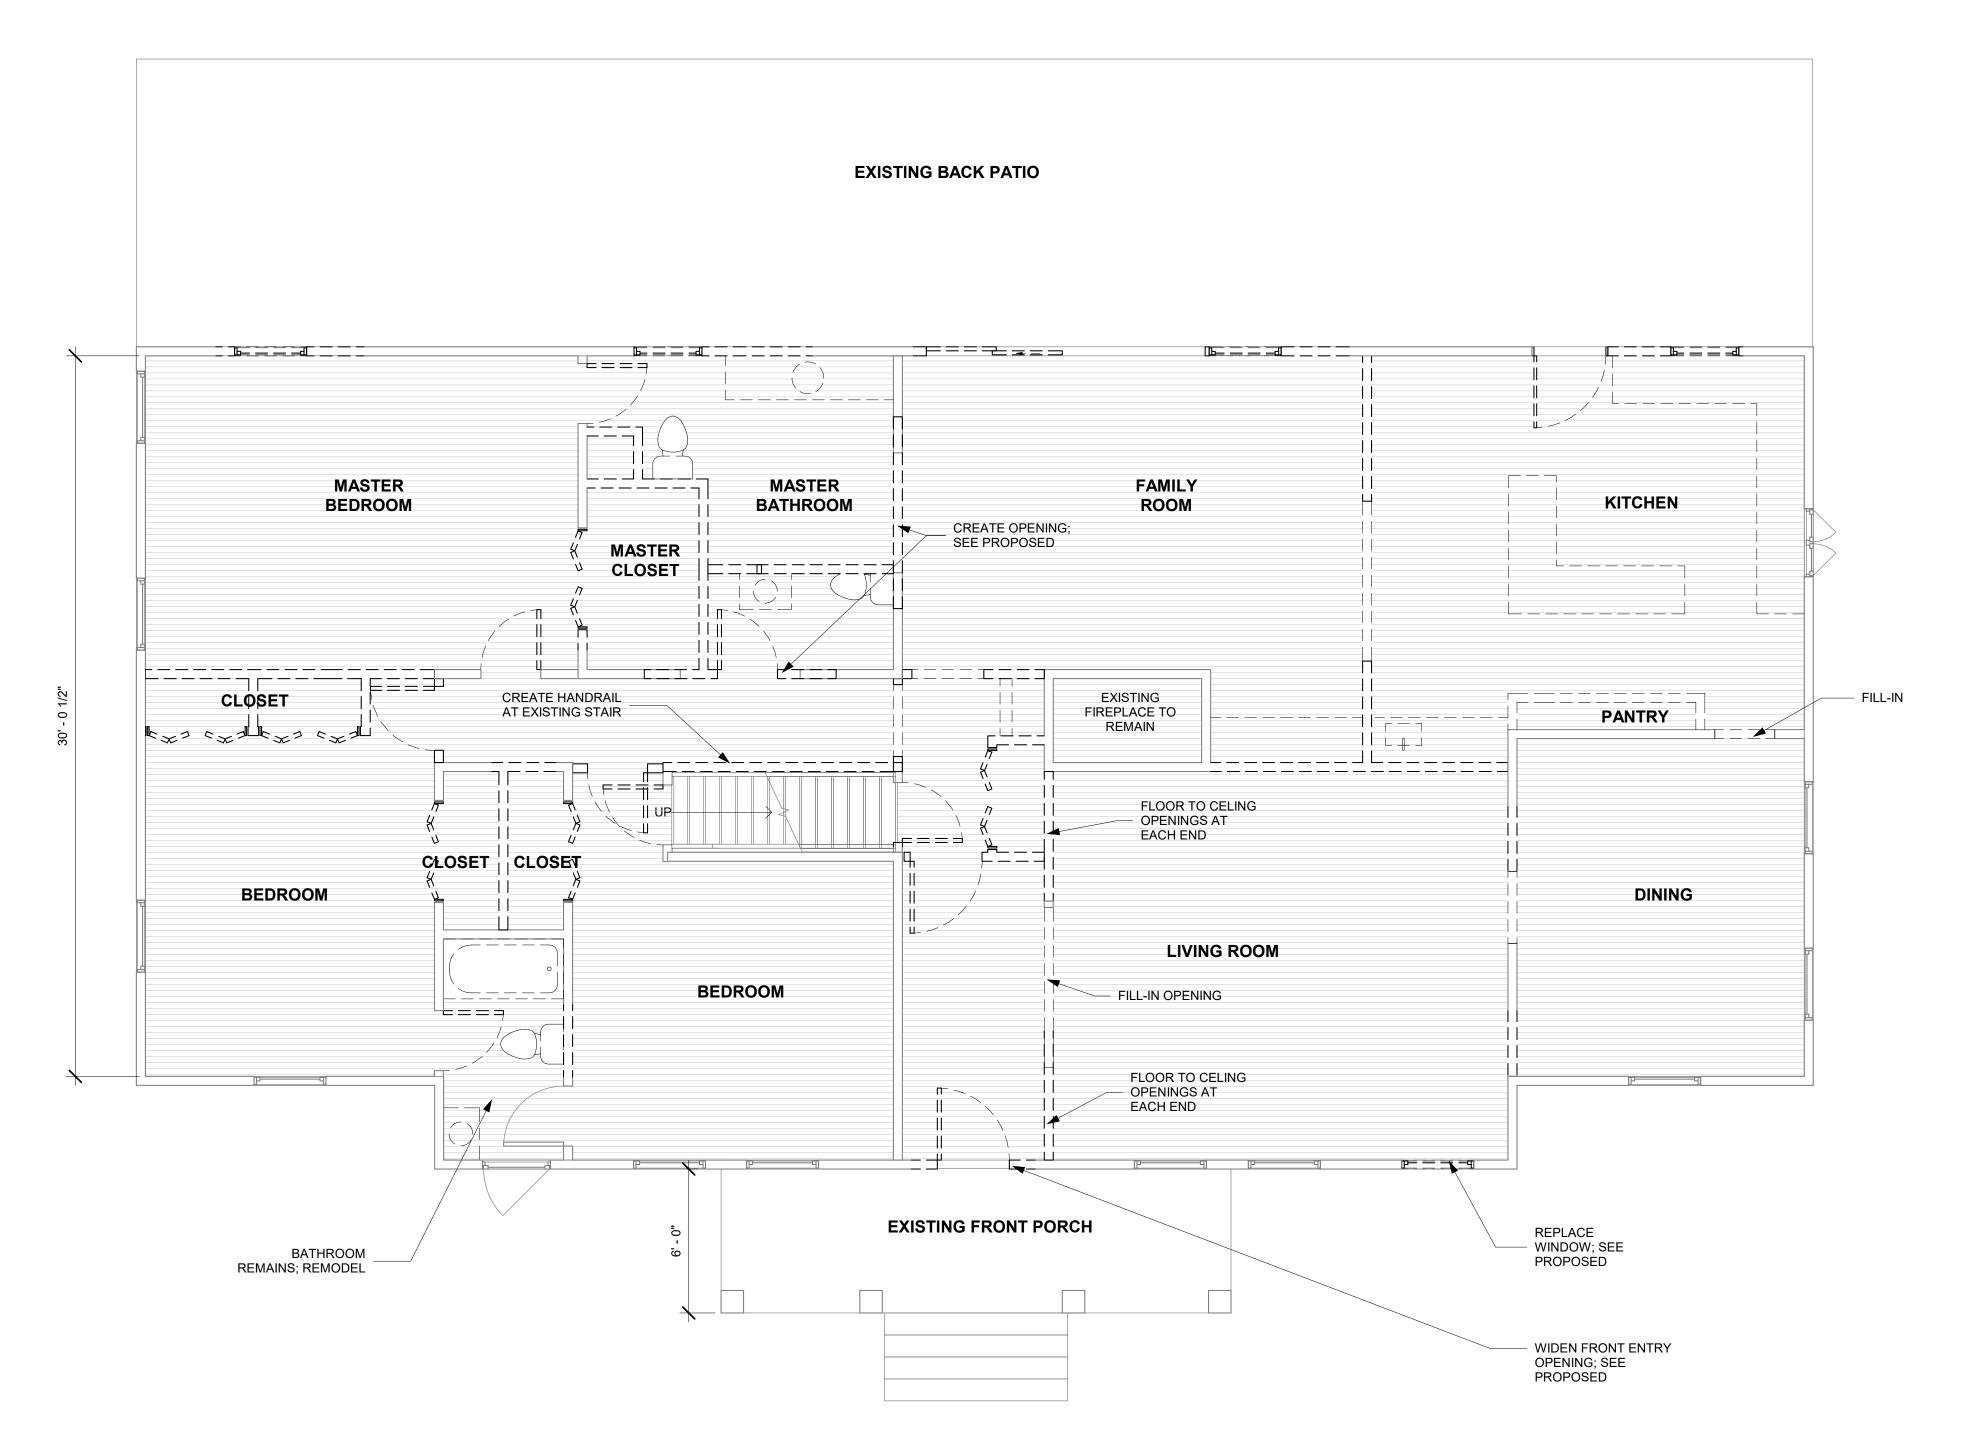

1) Existing Plans - Level 1 1/4" = 1'-0"

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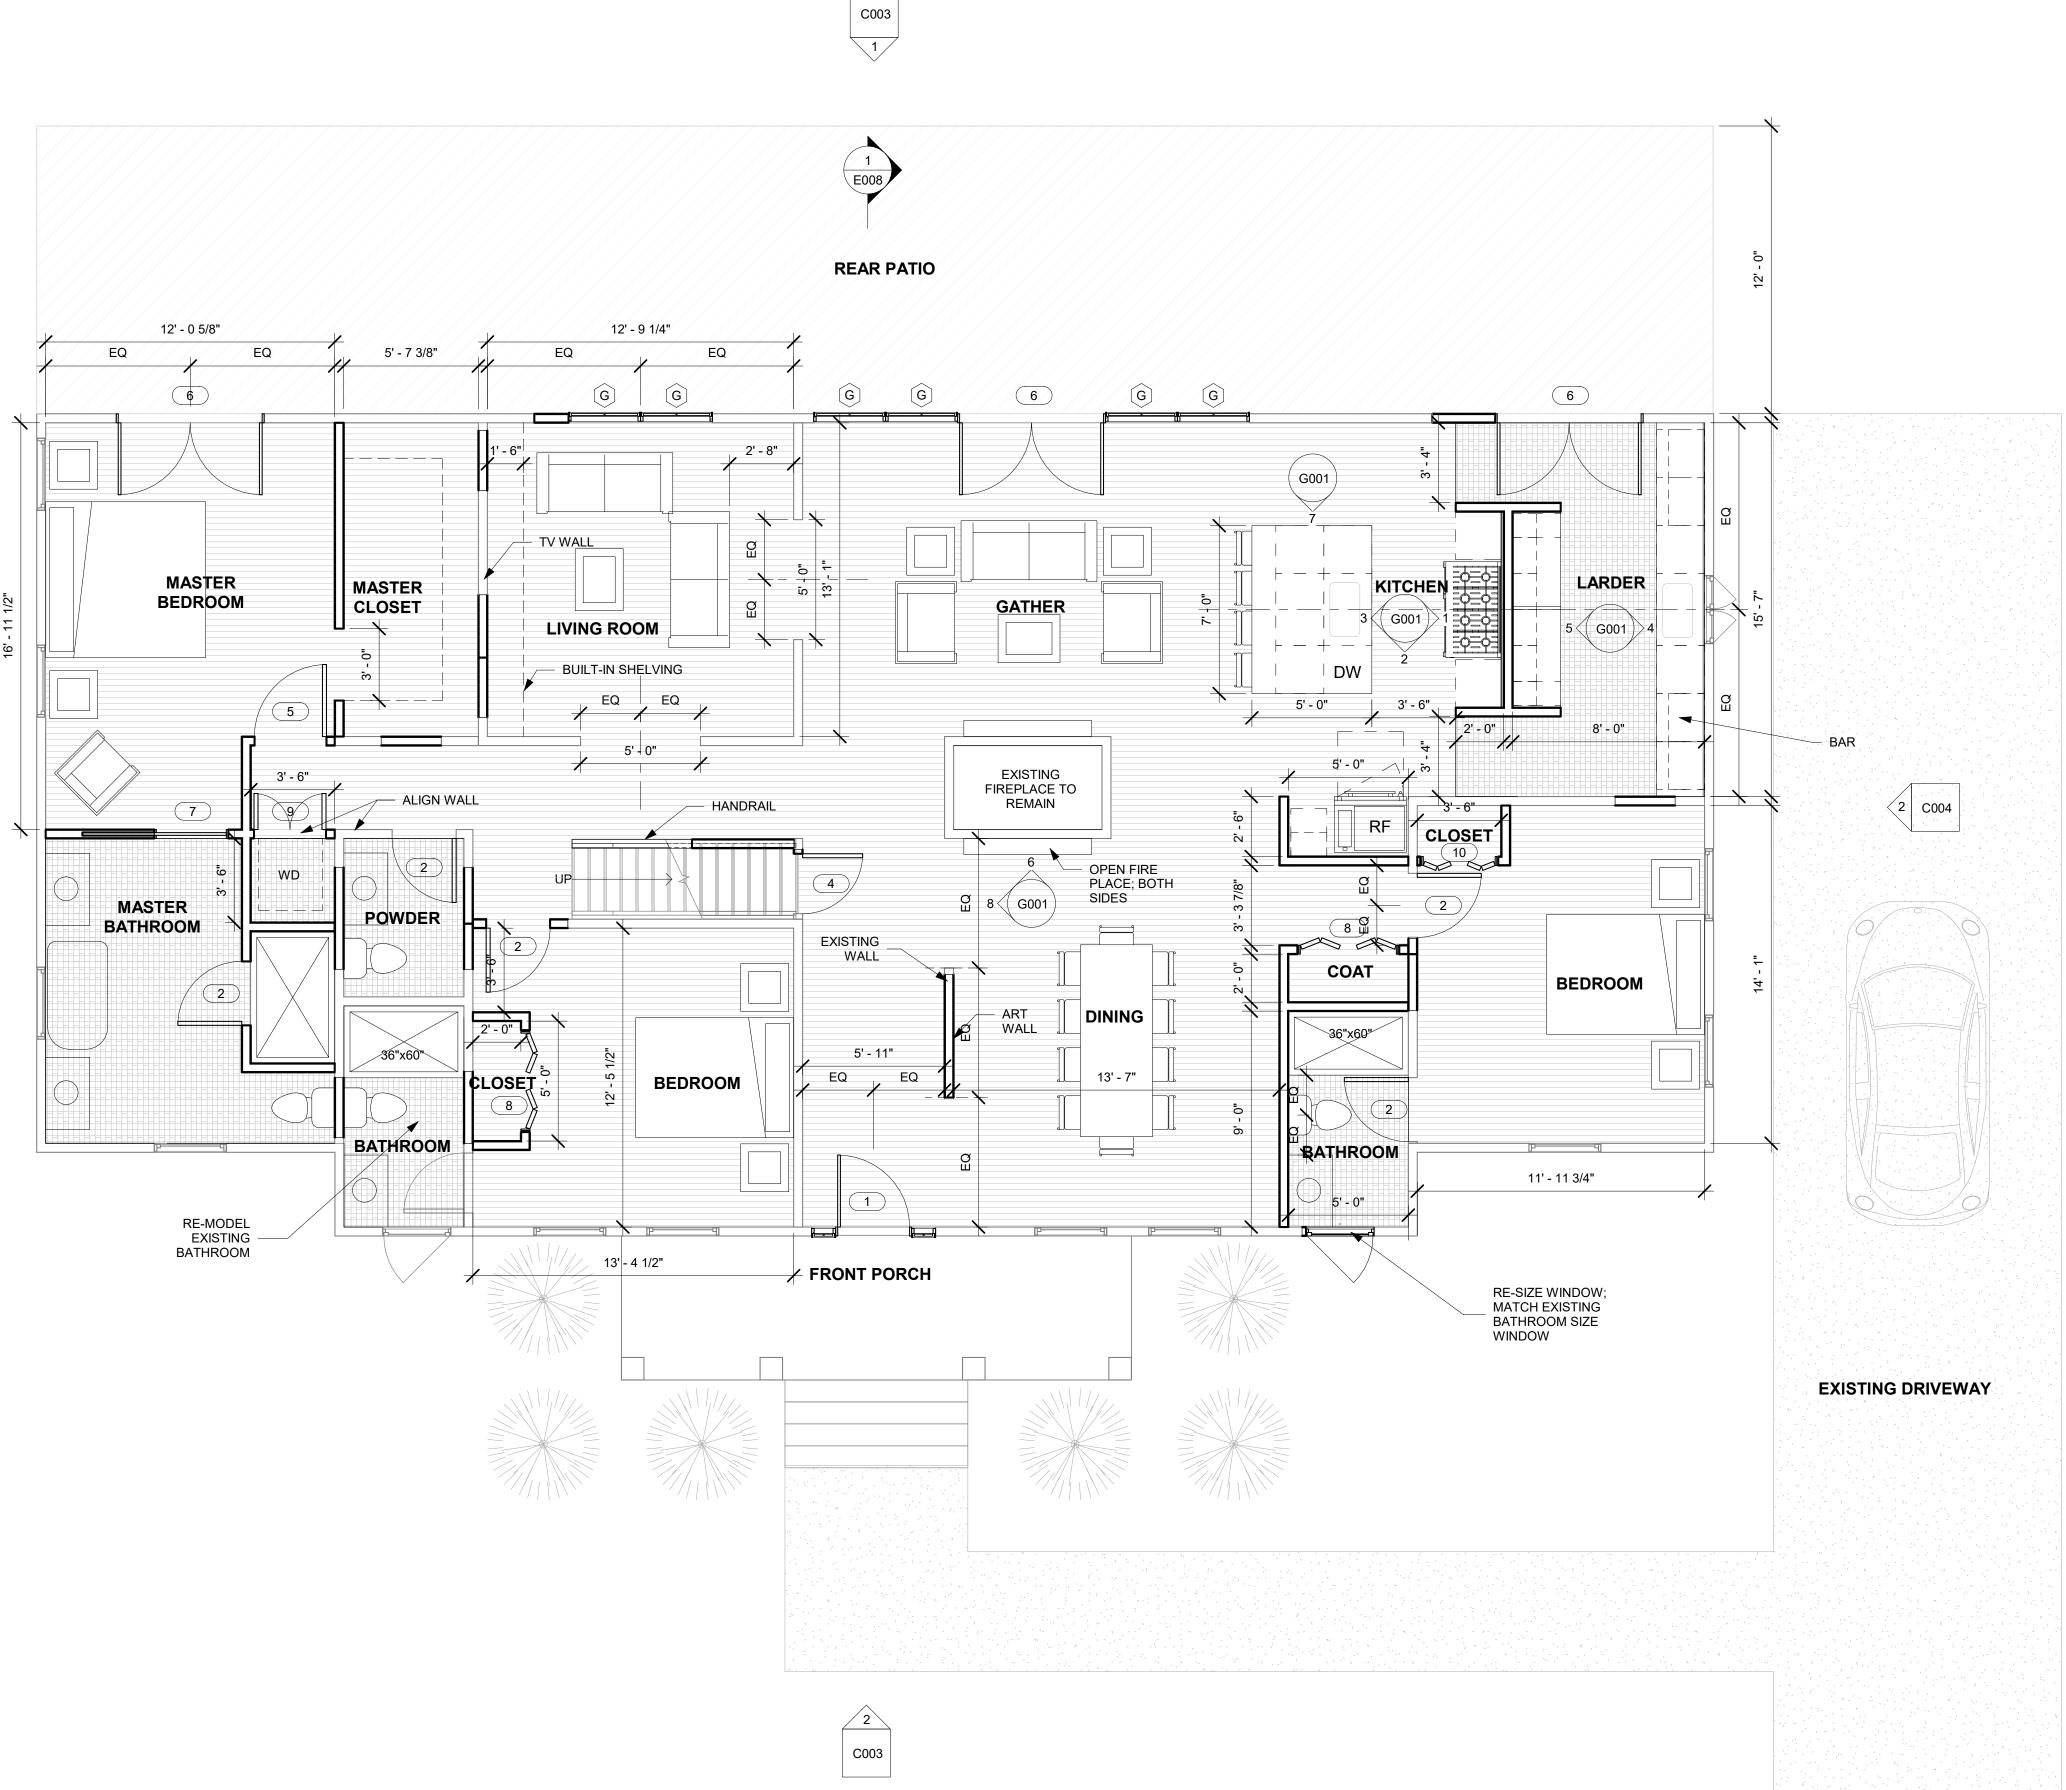
## Floor Plan - Existing Level 1


Date 05/26/2023

Drawn By Author

B002

Scale 1/4'' = 1'-0''



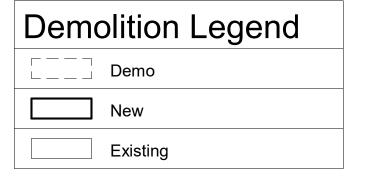

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# Floor Plan -Proposed Level 1

Date 05/26/2023

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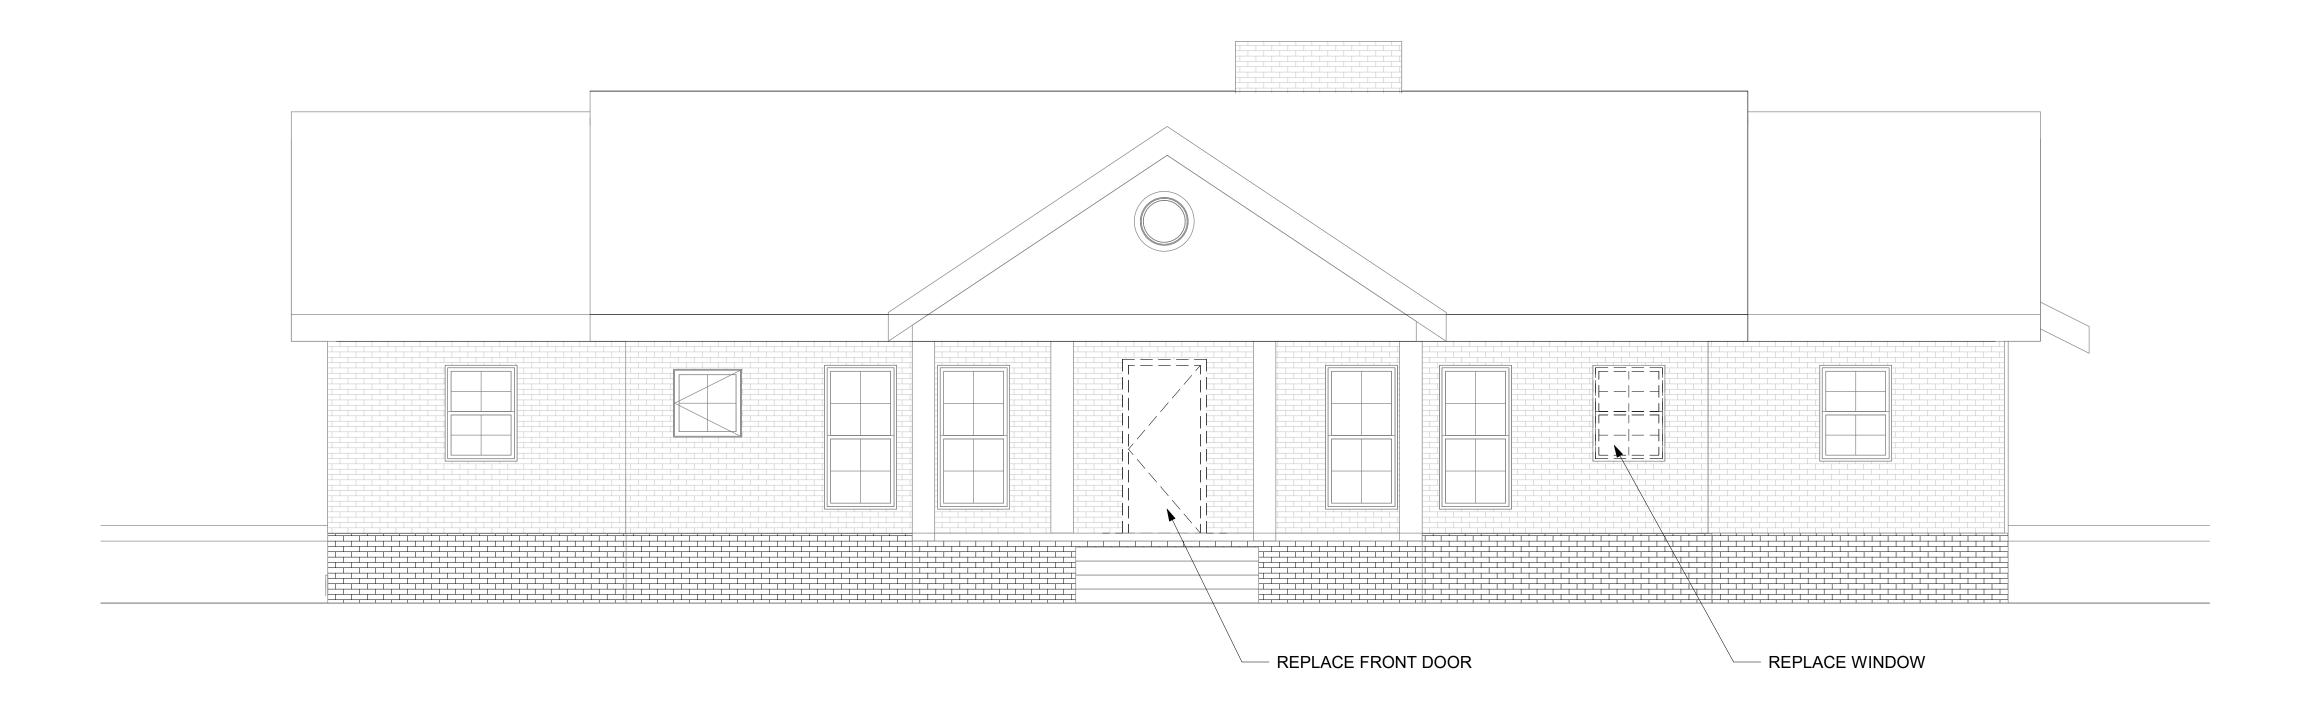
B004

1/4" = 1'-0"


Pricing Set For Construction

Proposed Floor Plan - Level 1
1/4" = 1'-0"

Demolition Legend					
	Demo				
	New				
	Existing				



1 Existing Elevation - Front 1/4" = 1'-0"

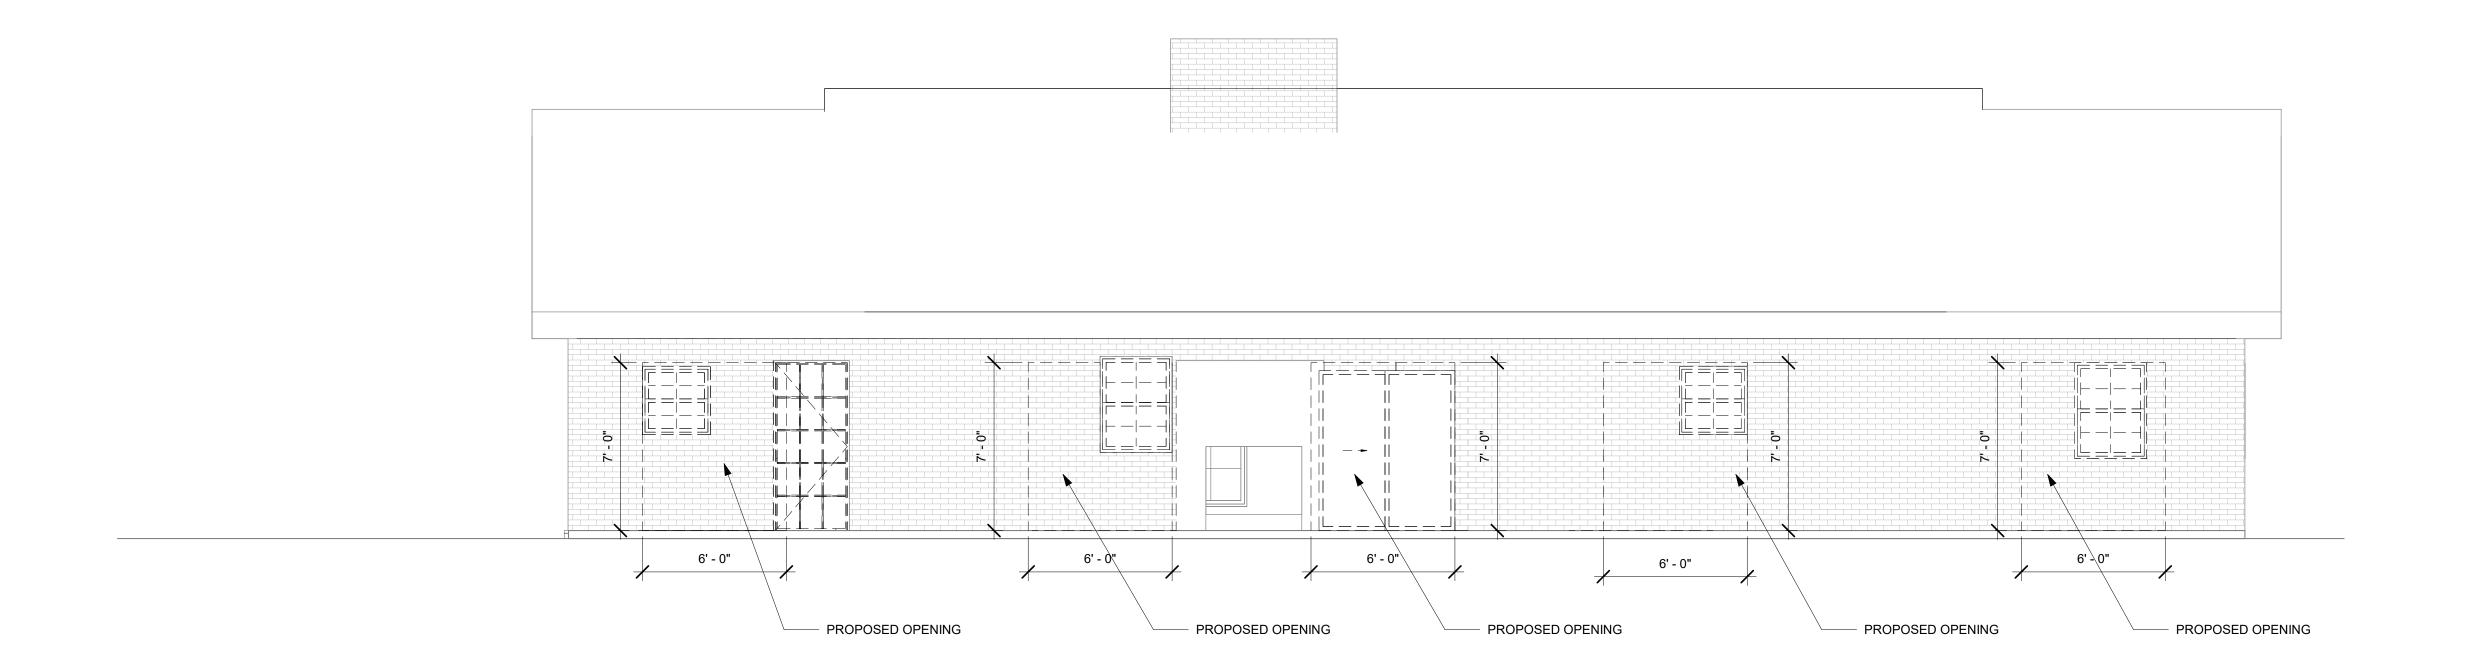

2 Existing Elevation - Back 1/4" = 1'-0"

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# Barton Woods Alteration The Ansley's Residence

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# Elevations - Existing

 Date
 05/26/2023

 Drawn By
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C001

Scale 1/4" = 1'-0"



1 Existing Elevation - Left 1/4" = 1'-0"



2 Existing Elevation - Right 1/4" = 1'-0"

emc	molition Legend				
	Demo				
	New				
	Existing				

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# Elevations - Existing


Date 05/26/2023


Drawn By i20 Design


C002

1/4" = 1'-0"



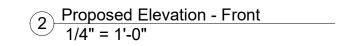

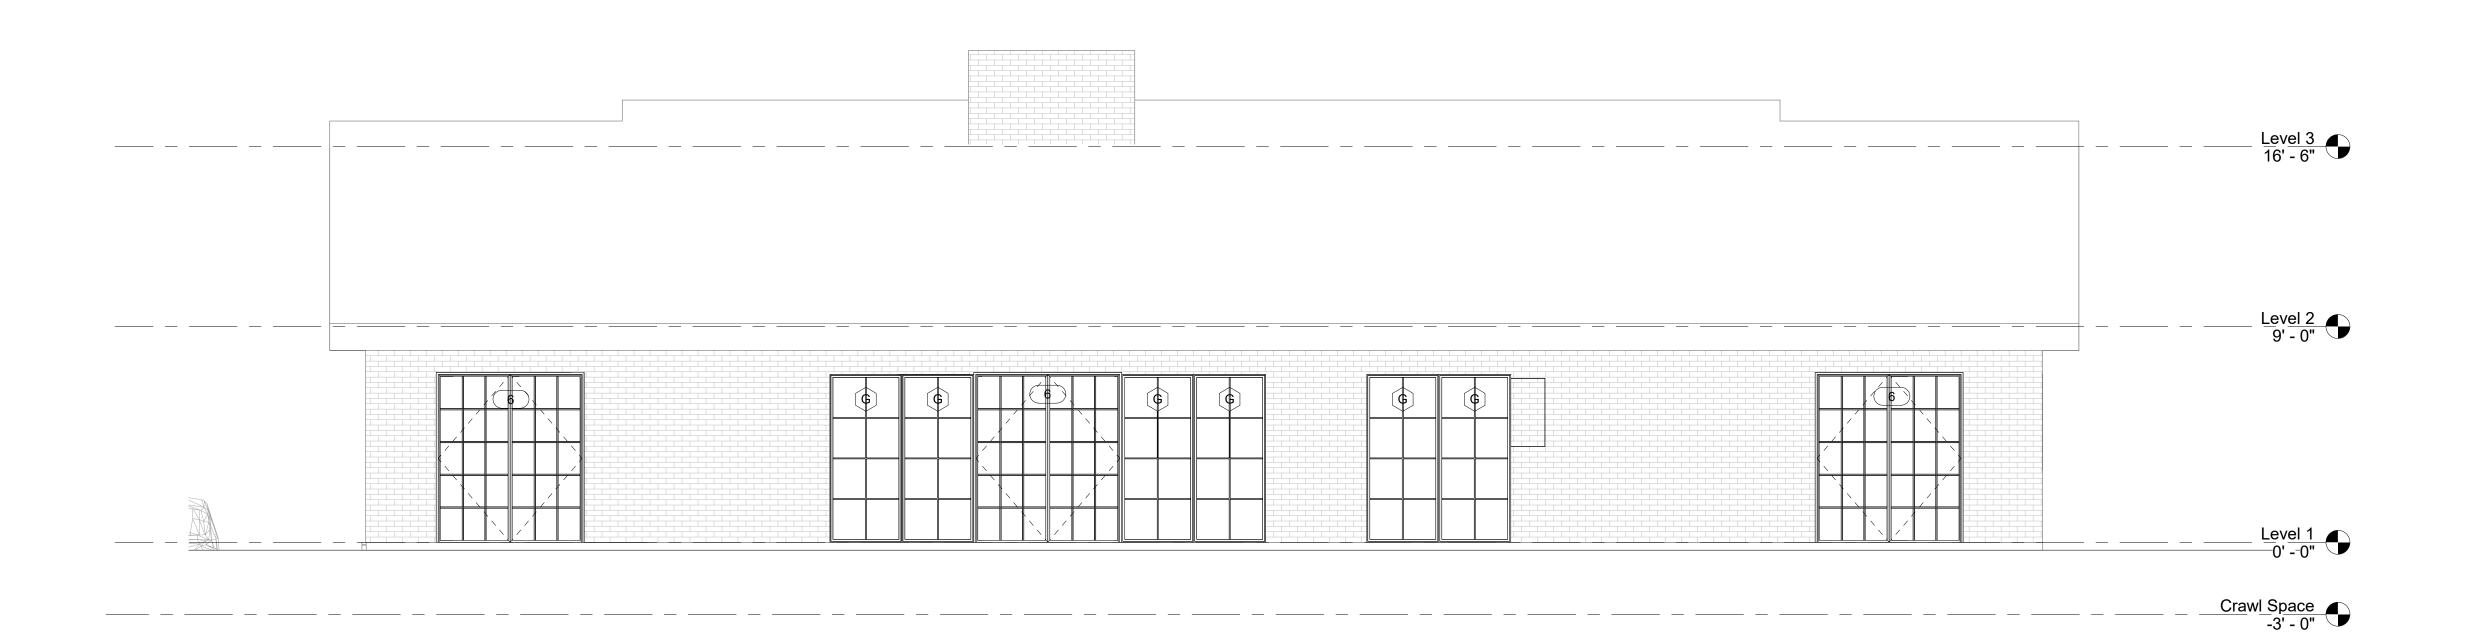

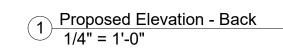

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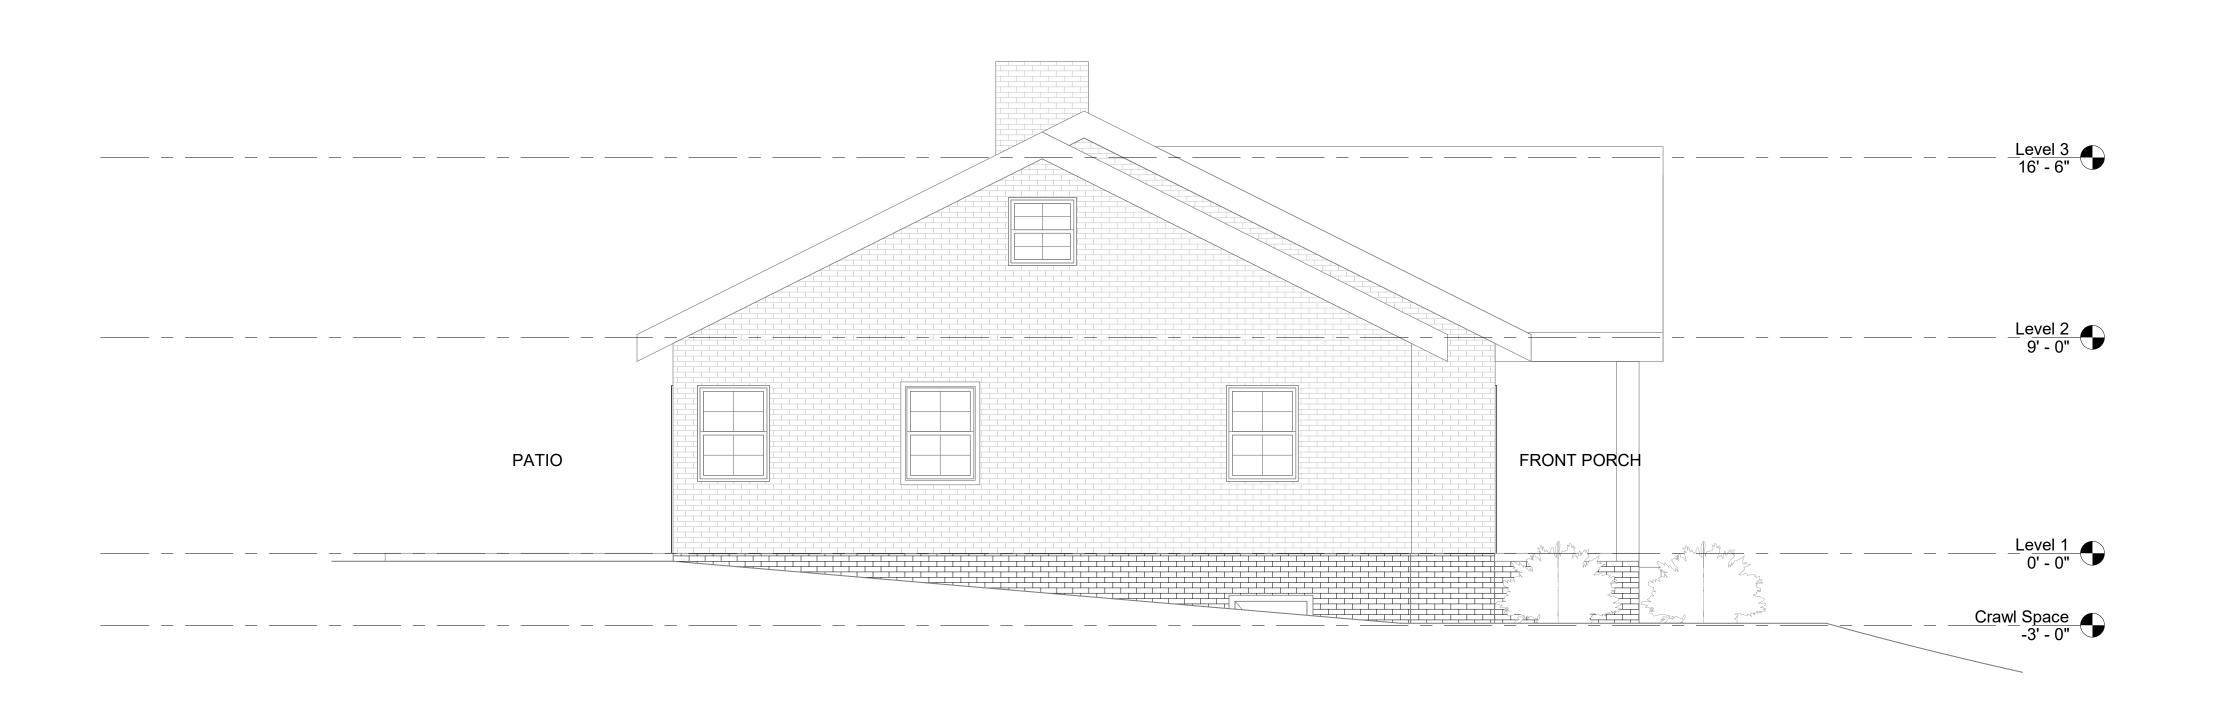
# Elevations - Proposed


Date 05/26/2023


Drawn By i20 Design

C003

e 1/4" = 1'-0"



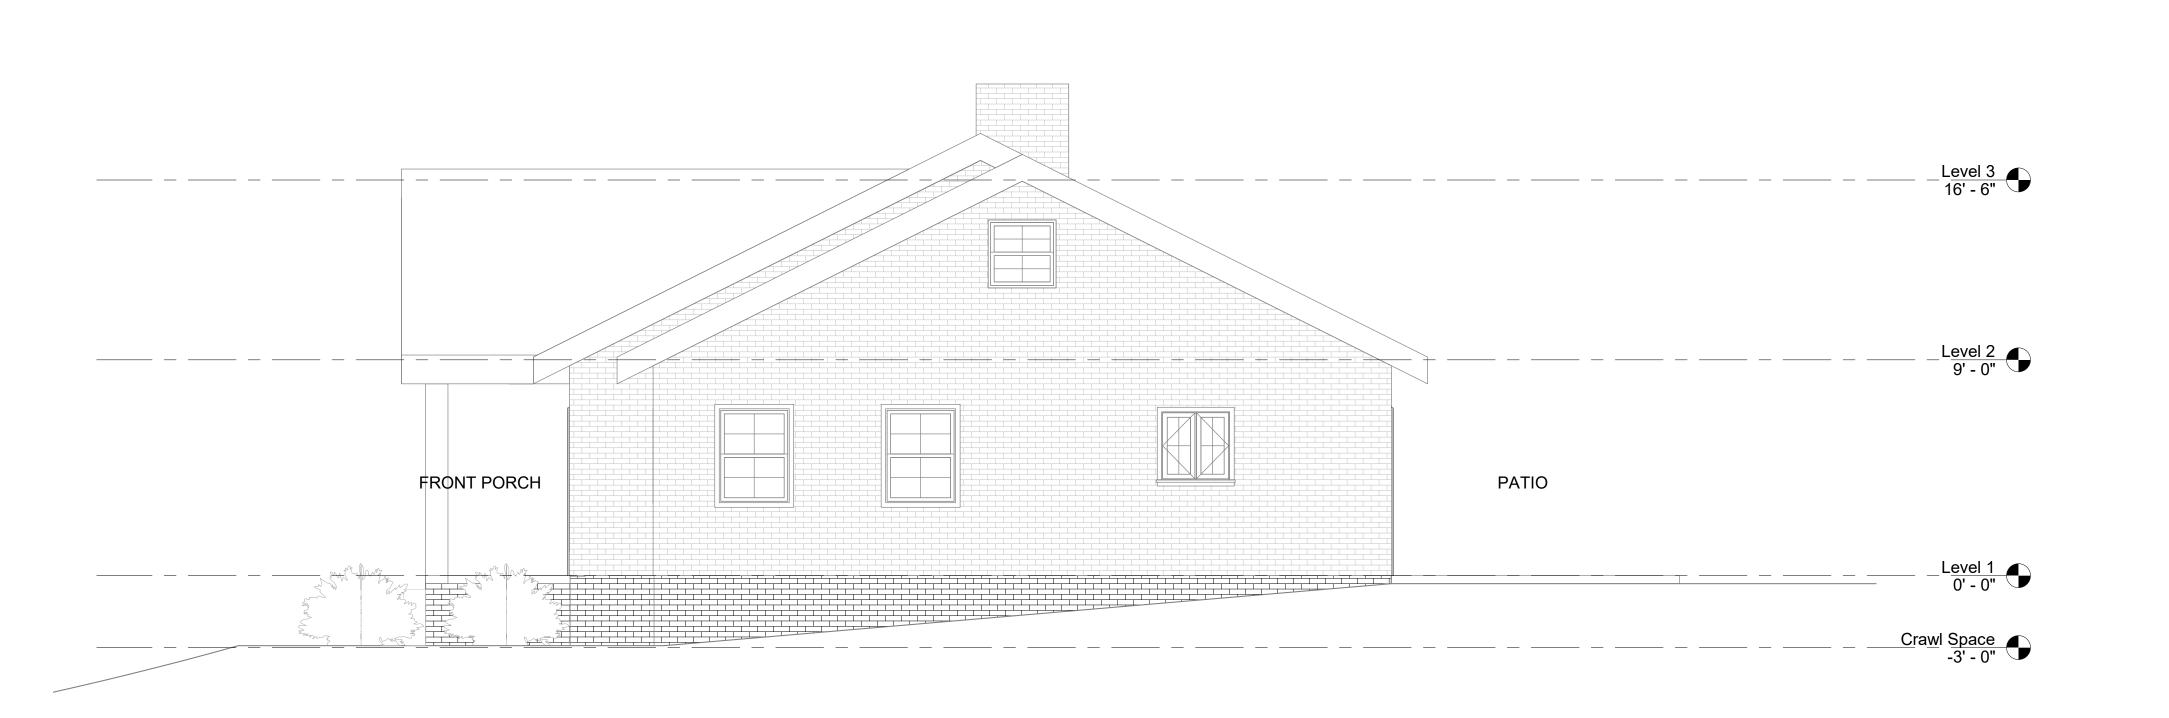

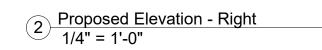

Sheet #	!	Title		Date Issued	
A000's	Cover S	Sheet & Perspectives		06/02/202	
B000's	Existing & Proposed Floor Plans		ans		
C000's Exis		Existing & Proposed Elevations			
D000's	00's Electrical Plans				
E000's	Foundation & Framing Plans				
F000's	Schedules				

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## Barton Woods Alteration The Ansley's Residence

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# Elevations - Proposed

Date 05/26/2023

Drawn By i20 Design

C004

1/4" = 1'-0"



Electric	Electrical Plan Legend					
<b>−</b> ∞	Switch					
-	Outlet					
– <b>⊜</b> gif	GFCI Outlet					
×	Ceiling Fan					
	Wall Sconce					
<b>-</b> \$	Smoke Detector (hardwire)					
\$	Carbon Monoxide Detector (hardwire)					
F	Ceiling Light					
	Can Light					
	Exhaust Fan + Can Light Combo					
$\triangle$	Directional Ceiling Light (artwork)					

1) Proposed Electrical Plan - Level 1 1/4" = 1'-0"

ELECTRICAL NOTES:
HIDE ALL OUTLETS IN KITCHEN AND
BATHROOM OUT OF SITE; LOCATE BELOW
COUNTERTOP HEIGHT AND TO SIDE.

UNDERMOUNT CABINET LIGHTING; TBD COORDINATED WITH LANDMARK.

ALL SWITCHES TO BE 48" ABOVE FINISHED FLOOR.

Sheet #	Title	Date Issued
A000's	Cover Sheet & Perspect	ives 06/02/2023
B000's	Existing & Proposed Floor	or Plans
C000's	Existing & Proposed Ele	vations
D000's Electrical Plans		
E000's Foundation & Framing Plans		lans
F000's Schedules		

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# Electrical Plan -Proposed

05/26/2023 Drawn By Author

D001

1/4" = 1'-0"

#### DESIGN CRITERIA:

- 1. LIVE LOADS:
- a. Floor Non sleeping areas = 40PSF
- b. Floor Sleeping areas = 30 PSF
- c. Ceiling = 20 PSF
- d. Roof = 20 PSF
- 2. DEAD LOADS:
- b. Ceiling = 10 PSF

a. Floor = 20 PSF

c. Roof = 10 PSF


#### 3. WIND DESIGN DATA:


- a. Basic Wind Speed (3 second gust) = 106 MPH
- b. Risk Category = Category II
- c. Wind Exposure: Exposure B.
- 4. DESIGN BEARING PRESSURE: 2000 PSF


#### **SPAN CHARTS**

1ST FLOOR FRAMING LOAD BEARING HEADER SCHEDULE						
MAX SPAN (ft.)	SIZE	WOOD GRADE	JACK STUDS	KING STUDS		
4'-0"	2-2X10	Southern Pine No. 2	2	1		
5'-0"	3-2X10	Southern Pine No. 2	2	1		
6'-0"	3-2X12	Southern Pine No. 2	2	1		
7'-0"	3.25X9.5	Boise Cascade 2.1E 3100 Fb	3	2		

2ND FLOOR FRAMING LOAD BEARING HEADER SCHEDULE						
MAX SPAN (ft.)	SIZE	WOOD GRADE	JACK STUDS	KING STUDS		
3'-0"	2-2X6	Southern Pine No. 2	2	1		
4'-0"	2-2X8	Southern Pine No. 2	2	1		
5'-0"	3-2X8	Southern Pine No. 2	2	1		
6'-0"	3-2X10	Southern Pine No. 2	2	1		
7'-0"	3-2X12	Southern Pine No. 2	2	1		
8'-0"	3.25X9.5	Boise Cascade 2.1E 3100 Fb	3	2		

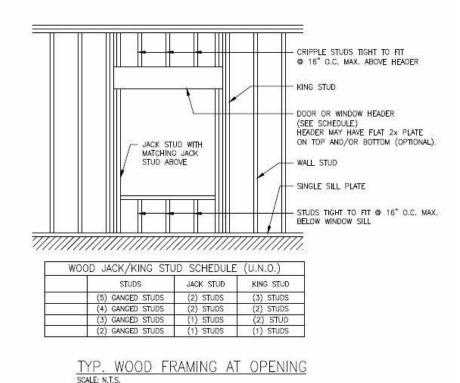

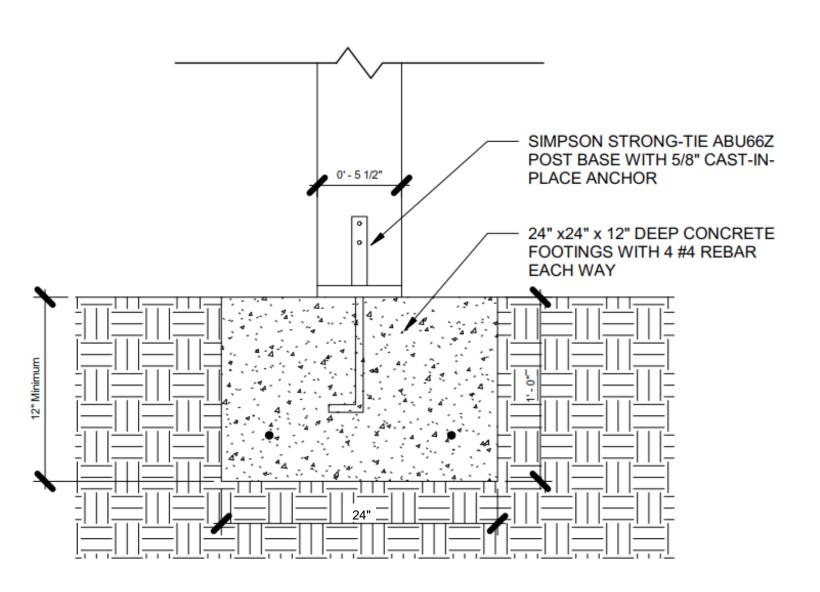

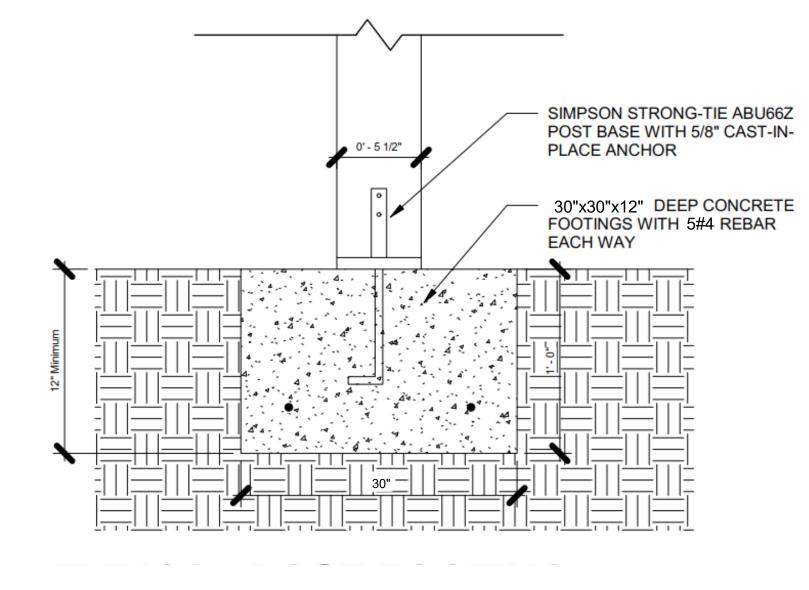

**FOUNDATION NOTES:** 

- ALL SOIL BEARING CAPACITIES AS SHOWN ON THE DRAWINGS ARE ESTIMATED. FINAL, EXACT SOIL BEARING CAPACITIES SHALL BE FIELD DETERMINED AND VERIFIED BY THE OWNER'S SOIL TESTING LABORATORY AND/OR GEOTECHNICAL ENGINEER DURING CONSTRUCTION.
- THE SOIL SUBGRADE FOR ALL FOOTINGS AND SLABS SHALL BE INSPECTED AND APPROVED BY THE OWNER'S TESTING LABORATORY IMMEDIATELY PRIOR TO PLACING FOUNDATION
- BEARING PRESSURE FOR SLAB-ON-GRADE SHALL BE 2,000 PSF. REQUIRED REMEDIATION TO ACHIEVE DESIGN BEARING PRESSURE SHALL BE APPLIED. MEANS AND METHODS OF REMEDIATION
- LL FOOTINGS AND PIERS SHALL REST ON 6" OF 3/4" CRUSHED STONE BASE MATERIAL. ALL CRUSHED STONE SHOULD COMPLY WITH ASTM D2940.
- CRUSHED STONE SHOULD BE COMPACTED WITH VIBRATORY PLATE COMPACTOR. MATERIALS USED TO PRODUCE CONCRETE SHALL COMPLY WITH THE REQUIREMENTS OF ACI 318-14.
- UNLESS NOTED OTHERWISE, ALL CONCRETE TO BE NORMAL-WEIGHT AS DEFINED BY ACI 318-14 AND ITS 28-DAY CONCRETE COMPRESSIVE STRENGTH SHALL BE 3,500 PSI. ALL CONCRETE SHALL CONTAIN AN APPROVED WATER REDUCING PLASTICIZING ADMIXTURE. APPROVED HIGH-RANGE WATER REDUCING ADMIXTURES MAY BE UTILIZED. ALL CONCRETE
- PERMANENTLY EXPOSED TO WEATHER SHALL ALSO CONTAIN AN APPROVED AIR-ENTRAINING ADMIXTURE.
- NO CALCIUM CHLORIDE SHALL BE USED IN ANY CONCRETE. PROVIDE 3" OF COVER FOR REINFORCEMENT IN CONCRETE FOOTING.
  - CONCRETE SLAB SHALL BE AT LEAST 4" THICK AND SHALL BE REINFORCED WITH W8-D8 WWR SPACED @ 6 INCHES ON CENTER ALL WELDED WIRE FABRIC (WWF) SHALL CONFORM TO THE STANDARDS OF ASTM A1064.
  - REINFORCING STEEL SHALL COMPLY WITH THE REQUIREMENTS OF ASTM A615 AND SHALL HAVE MINIMUM YIELD STRENGTH OF 60,000 PSI. ALL REINFORCING SPLICES SHALL CONFORM TO THE REQUIREMENTS OF ACI 318, BUT IN NO CASE SHALL BE LESS THAN 36 BAR DIAMETERS, UNLESS NOTED OTHERWISE.
  - ALL WELDED WIRE FABRIC SPLICES SHALL BE LAPPED TWO (2) FULL MESH PANELS AND TIED SECURELY.
- CONSTRUCTION JOINTS IN ALL WALLS, SLABS AND BEAMS SHALL NOT BE FURTHER APART THAN 90 FEET IN ANY DIRECTION ALL CONSTRUCTION JOINTS SHALL BE WIRE BRUSHED, CLEANED AND MOISTENED IMMEDIATELY PRIOR TO PLACING NEW CONCRETE.
- PLACE ALL SLABS-ON-GRADE IN STRIP POURS OF A MAXIMUM WIDTH OF 30 FEET WITH A MINIMUM OF 24 HOURS BETWEEN ADJACENT POURS.
- STRIP POURED SLABS SHALL HAVE SAWCUT CONTROL JOINTS AT 15'-0" CENTERS. ALL DIMENSIONS TO BE VERIFIED IN FIELD.
- ALL UTILITIES MUST BE PROPERLY MARKED PRIOR TO CONSTRUCTION.
- CONTRACTOR MUST INFORM ARCHITECT AND ENGINEER OF RECORD IF ON-FIELD MEASUREMENTS AND/OR CONDITIONS VARY FROM DESIGN DRAWING.
- ANCHOR BOLTS TO CONFORM TO ASTM A307 STANDARDS. ANCHOR BOLTS TO BE GALVANIZED ACCORDING TO ASTM A153 STANDARDS.
- A NUT AND WASHER TO BE TIGHTENED AT EACH BOLT.
- EACH SILL PLATE SHALL BE EMBEDDED WITH A 1/2" DIAMETER BOLT (WITH NUT AND WASHER) SPACED NOT MORE THAN 72 INCHES ON CENTER AND EMBEDDED AT LEAST 7 INCHES INTO 27. CONCRETE. THERE SHALL BE A MINIMUM OF TWO (2) BOLTS PER SILL PLATE SEGMENT WITH ONE BOLT LOCATED FROM THE END OF EACH SEGMENT AT LEAST 4 INCHES BUT NOT MORE THAN
- STEEL PLATE WASHERS SHALL BE PLACED BETWEEN THE FOUNDATION SILL PLATE AND THE NUT. SUCH WASHERS SHALL BE A MINIMUM OF 0.229 INCH BY 3 INCHES BY 3 INCHES ALL BACKFILL SOILS TO BE COMPACTED TO AT LEAST 95% OF THE MAXIMUM DRY DENSITY, AS DETERMINED BY STANDARD PROCTOR TEST (ASTM D698).
- BOTTOM OF ALL FOUNDATIONS SHALL EXTEND A MINIMUM OF TWELVE (12) INCHES BELOW THE TOP OF FINISHED GRADE. 6 MIL (MINIMUM) POLYETHYLENE MOISTURE BARRIER (WITH JOINTS LAPPED NOT LESS THAN 6 INCHES) SHALL BE PLACED DIRECTLY BENEATH ALL INTERIOR CONCRETE SLABS ON GRADE
- MATERIALS USED TO PRODUCE CONCRETE MASONRY UNITS SHALL COMPLY WITH THE REQUIREMENTS OF TMS 402/602-16. CONCRETE MASONRY UNITS SHALL BE NORMAL-WEIGHT, SHALL HAVE NOMINAL DIMENSIONS OF 8"X8"X16", AND SHALL COMPLY WITH THE REQUIREMENTS OF ASTM C90 WITH A MAXIMUM
- BACKFACE OF CMU WALL (FACE EXPOSED TO BACKFILL) SHALL BE WATERPROOFED WITH TWO CONTINUOUS COATINGS OF HOT BITUMINOUS MATERIAL
- GEOTEXTILE DRAINAGE FABRIC SHALL BE WRAPPED AROUND 12" OF 3/4" CRUSHED STONE DRAIN PIPE SHALL BE PLACED AT FULL LENGTH OF THE WALL TO PROVIDE POSITIVE DRAINAGE
- CONTRACTOR IS RESPONSIBLE ON PROVIDING THE REQUIRED CRAWL SPACE VENTILATION AREA. SPECS. AND MATERIALS CONFORMING WITH GEORGIA IRC 2018 R408 MORTAR FOR MASONRY CONSTRUCTION SHALL BE TYPE S COMPLYING WITH THE REQUIREMENTS OF ASTM C270 WITH A MINIMUM 28-DAY COMPRESSIVE STRENGTH OF 1,800 PSI
- REQUIRED NET AREA COMPRESSIVE STRENGTH OF MASONRY (fm) SHALL BE 2,000 PSI. ALL JOINT REINFORCEMENT, TIES, AND OTHER ACCESSORIES SHALL BE RESISTANT TO CORROSION
- ALL HEAD AND BED JOINTS SHALL BE 3/8" THICK. BED JOINTS OF THE STARTING COURSE OVER THE CONCRETE FOUNDATION MAY BE BETWEEN 1/4" TO 3/4" PROVIDE 1.5" DEEP BY 3.5" WIDE CONTINUOUS KEYWAY
- GROUT FOR MASONRY SHALL COMPLY WITH THE REQUIREMENTS OF ASTM C476 AND SHALL HAVE MINIMUM 28-DAY COMPRESSIVE STRENGTH OF 2,000 PSI
- PROVIDE TRUSS OR LADDER TYPE HORIZONTAL JOINT REINFORCEMENT COMPLYING WITH ASTM A951 WITH MINIMUM TWO 9 GA LONGITUDINAL LINES, ZINC COATED, PLACED 16 INCHES ON CENTER UNLESS NOTED OTHERWISE. PROVIDE PREFABRICATED "L's" AT WALL CORNERS AND "T's" AT WALL INTERSECTIONS
- NEW FOOTINGS CLOSER THAN 5 FEET TO AN EXISTING EXTERIOR HOUSE WALL MUST BEAR AT THE SAME ELEVATION AS THE EXISTING HOUSE FOOTINGS

#### FRAMING NOTES:

- ALL DIMENSIONS TO BE VERIFIED IN FIELD.
- CONTRACTOR MUST INFORM ARCHITECT AND ENGINEER OF RECORD IF ON-FIELD MEASUREMENTS AND/OR CONDITIONS VARY FROM DESIGN DRAWINGS.
- ALL LUMBER AND PLYWOOD USED FOR FOUNDATION AND/OR IN DIRECT CONTACT WITH GROUND SHALL BE PRESSURE-PRESERVATIVE TREATED AND DRIED AFTER TREATMENT IN ACCORDANCE WITH AWPA U1 (COMMODITY SPECIFICATION A, USE CATEGORY 4B AND SECTION 5.2), AND SHALL BEAR THE LABEL OF AN ACCREDITED AGENCY.
- WHERE LUMBER AND/OR PLYWOOD IS CUT OR DRILLED AFTER TREATMENT, THE TREATED SURFACE SHALL BE FIELD TREATED WITH COPPER NAPHTHENATE, THE CONCENTRATION OF WHICH SHALL CONTAIN A MINIMUM OF 2 PERCENT COPPER METAL, BY REPEATED BRUSHING, DIPPING OR SOAKING UNTIL THE WOOD ABSORBS NO MORE PRESERVATIVE.
- ALL TIMBER FRAME CONSTRUCTION SHALL BE DONE IN STRICT CONFORMANCE WITH THE AITC TIMBER CONSTRUCTION MANUAL & NDS 2018. ALL TIMBER STRUCTURAL FRAMING COMPONENTS, INCLUDING BUT NOT LIMITED TO STUDS, JOISTS, RAFTERS, HEADERS, BEAMS, AND POSTS SHALL BE SOUTHERN PINE, #2 OR BETTER UNLESS NOTED OTHERWISE.
- ALL PLYWOOD FLOOR DECKING SHALL BE 3/4" APA RATED STRUCTURAL 1 (RATED 48/24).
- ALL PLYWOOD ROOF DECKING SHALL BE 5/8" APA RATED STRUCTURAL 1 EXPOSURE 1 (RATED 32/16). INTERMEDIATE EXTERIOR PLYWOOD WALL SHEATHING SHALL BE FASTENED WITH 8d COMMON NAILS SPACED AT 4" O.C. AT PANEL EDGES AND 12" O.C. INTERMEDIATE.
- ALL LAG BOLT CONNECTIONS SHALL BE PRE-DRILLED WITH THE PROPER SIZE LEAD HOLE DIAMETER IN ACCORDANCE WITH THE AITC TIMBER MANUAL.
- ALL TIMBER FRAMING CLIPS AND FASTENERS SHALL BE HOT DIP GALVANIZED AFTER FABRICATION. ALL FRAMING CONNECTORS FOR STRUCTURAL TIMBER MEMBERS SHALL BE SIMPSON STRONG TIE CONNECTORS AND SHALL HAVE A MINIMUM CAPACITY OF 1100 LBS.
- CONTRACTOR MUST ABIDE BY ALL ENGINEERED LUMBER MANUFACTURER, OPEN WEB TRUSS MANUFACTURER, AND FRAMING CONNECTOR MANUFACTURER RECOMMENDATIONS AND SILL PLATES AND SOLE PLATES SHALL BE PROTECTED AGAINST DECAY AND TERMITES.
- EACH SILL PLATE SHALL BE EMBEDDED WITH A 1/2" DIAMETER BOLT (WITH NUT AND WASHER) SPACED NOT MORE THAN 72 INCHES ON CENTER AND EMBEDDED AT LEAST 7 INCHES INTO CONCRETE. THERE SHALL BE A MINIMUM OF TWO (2) BOLTS PER SILL PLATE SEGMENT WITH ONE BOLT LOCATED FROM THE END OF EACH SEGMENT AT LEAST 4 INCHES BUT NOT MORE THAN
- ALL LVL BEAMS TO BE BOISE CASCADE VERSA LAM 2.1E 3100 Fb
- ALL GLULAM BEAMS TO BE GRADED AS 24F-V4 AND SHALL BE TREATED FOR OUTDOOR EXPOSURE HOLD-DOWNS MUST BE PROVIDED ON EITHER SIDE OF ALL LARGE OPENINGS GREATER THAN 6 FEET IN WIDTH (AT THE NARROW-BRACED WALL PANELS). AT SUCH OPENINGS SIMPSON HTT5
- EQUIVALENT) HOLD DOWNS AT THE FLOOR PLATE AND STRAPS AT THE TOP ARE REQUIRED.

Sheet # Title Date Issued 06/02/2023 A000's | Cover Sheet & Perspectives B000's | Existing & Proposed Floor Plans C000's | Existing & Proposed Elevations D000's | Electrical Plans E000's | Foundation & Framing Plans F000's Schedules

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## Foundation & Framing Notes


05/26/2023 Author Drawn By

E001


12" = 1'-0"

**Pricing Set For Construction** 


**Interior Crawl Space Footing Detail** 

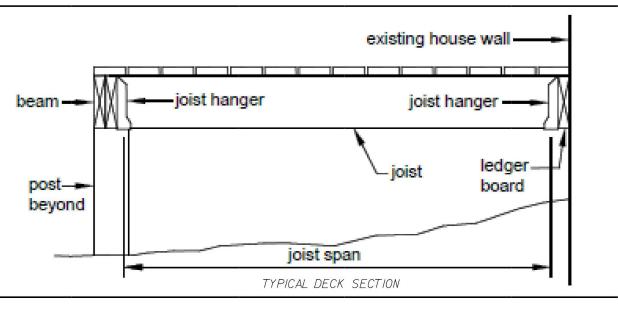



Beam Size→	(2)2x6	(2)2x8	(2)2x10	(2)2x12	(3)2x6	(3)2x8	(3)2x10	(3)2x12
Joist Span <b>√</b>								
≤ 6'	7'-1"	9'-2"	11'-10"	13'-11"	8'-7"	11'-4"	14'-5"	17'-5"
> 6' - 8'	6'-2"	7'-11"	10'-3"	12'-0"	7'-8"	9'-11"	12'-10"	15'-1"
> 8' - 10'	5'-6"	7'-1"	9'-2"	10'-9"	6'-11"	8'-11"	11'-6"	13'-6"
> 10' - 12'	5'-0"	6'-6"	8'-5"	9'-10"	6'-3"	8'-1"	10'-6"	12'-4"
> 12' - 14'	4'-8"	6'-0"	7'-9"	9'-1"	5'-10"	7'-6"	9'-9"	11'-5"
> 14' - 16'	4'-4"	5'-7"	7'-3"	8'-6"	5'-5"	7'-0"	9'-1"	10'-8"
> 16' - 18'	4'-1"	5'-3"	6'-10"	8'-0"	5'-2"	6'-7"	8'-7"	10'-1"

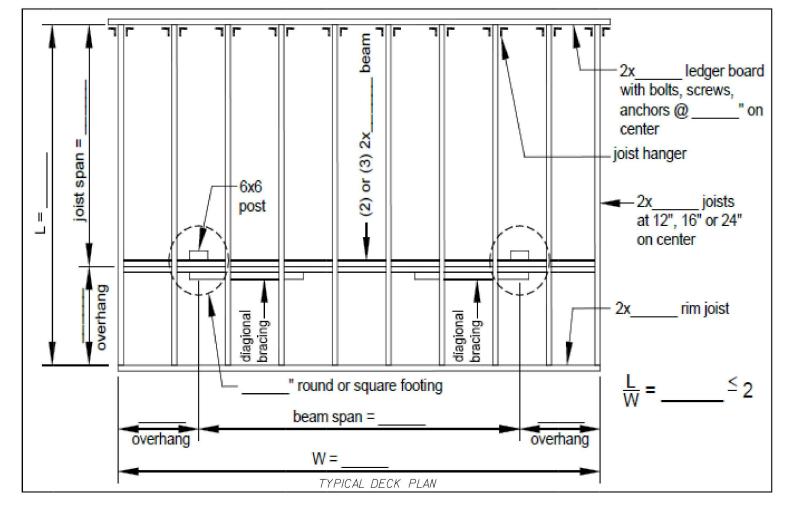

typical

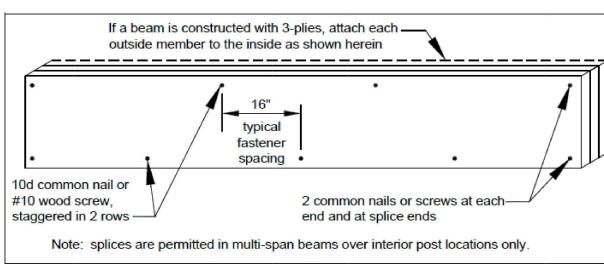

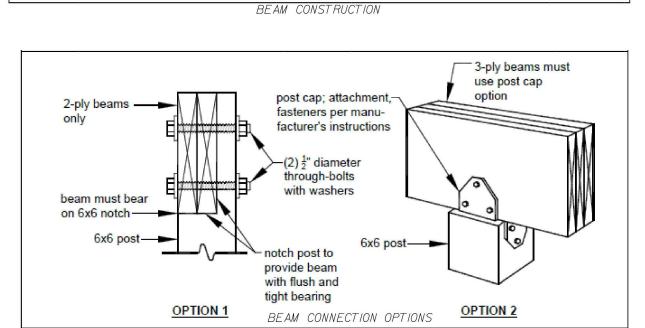


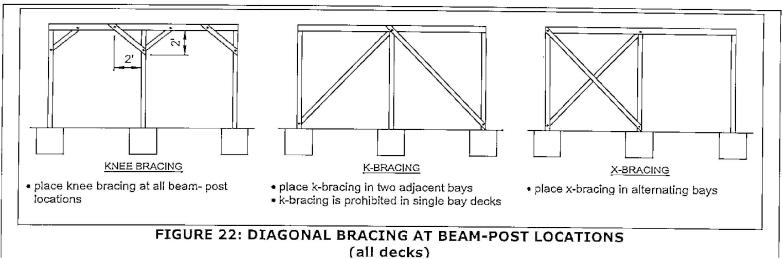

spacing<sub>I</sub> & bottom edges NO LEAD ANCHORS **-**--⊕  $6\frac{1}{2}$ " min. for 2x10 4 fasteners, each  $7\frac{1}{2}$ " min. for 2x12 end of ledger board interior fasteners; 2 rows staggered LEDGER BOARD FASTNER DETAIL


2" min. sides, top -


REFER TO GEORGIA PRESCRIPTIVE DECK CODE FOR ADDITIONAL INFORMATION AND DETAILS.

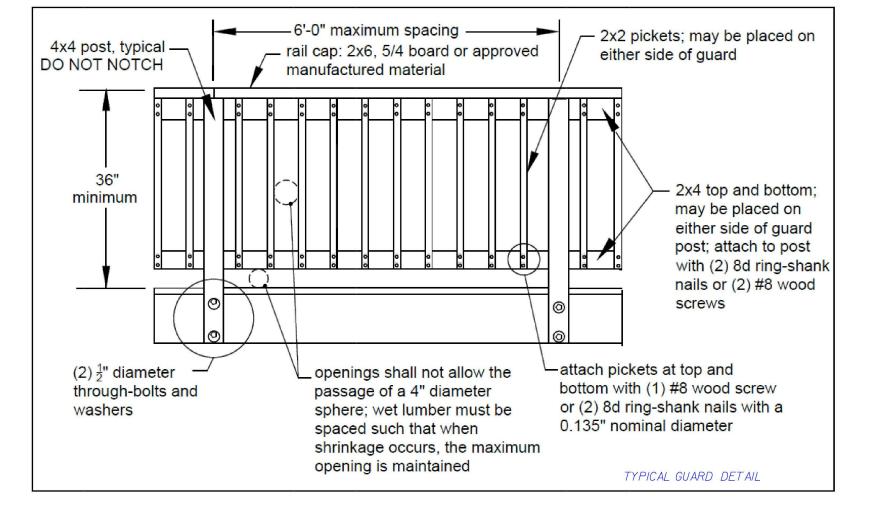

ATTACH RIM TO EXISTING HOUSE RIM BAND. ASSUMED TO BE 2x10

	R-VALUE CHART - PROPOSED WALLS (MINIMUM REQUIREMENTS)								
	Zone Classification	Crawlspace/Basement Walls	Floors/Ceilings	Exterior Walls (2x4)	Attics				
	Zone 3	R19-25	R25	R13-25	R30-60				
ı									

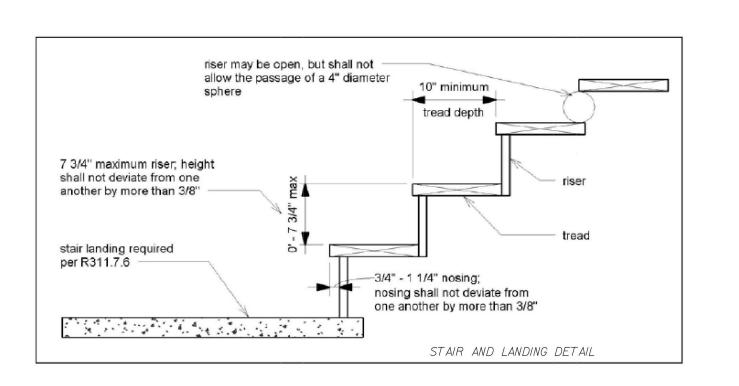

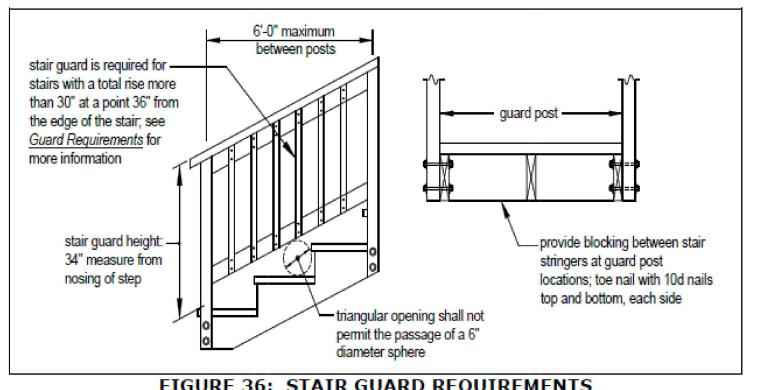

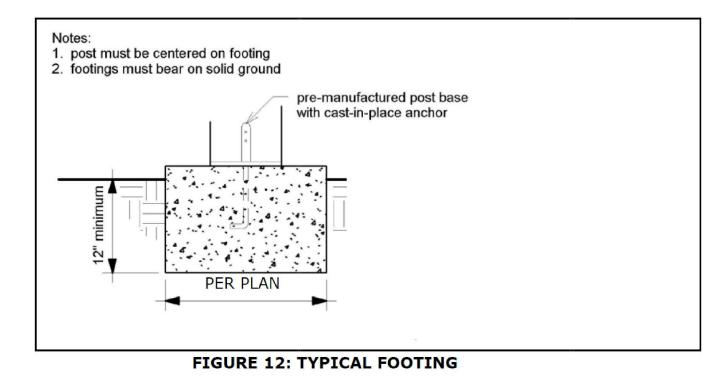


FIGURE 36: STAIR GUARD REQUIREMENTS

Title Sheet # Date Issued 06/02/2023 A000's Cover Sheet & Perspectives B000's Existing & Proposed Floor Plans C000's Existing & Proposed Elevations D000's | Electrical Plans E000's Foundation & Framing Plans F000's Schedules

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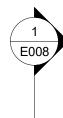
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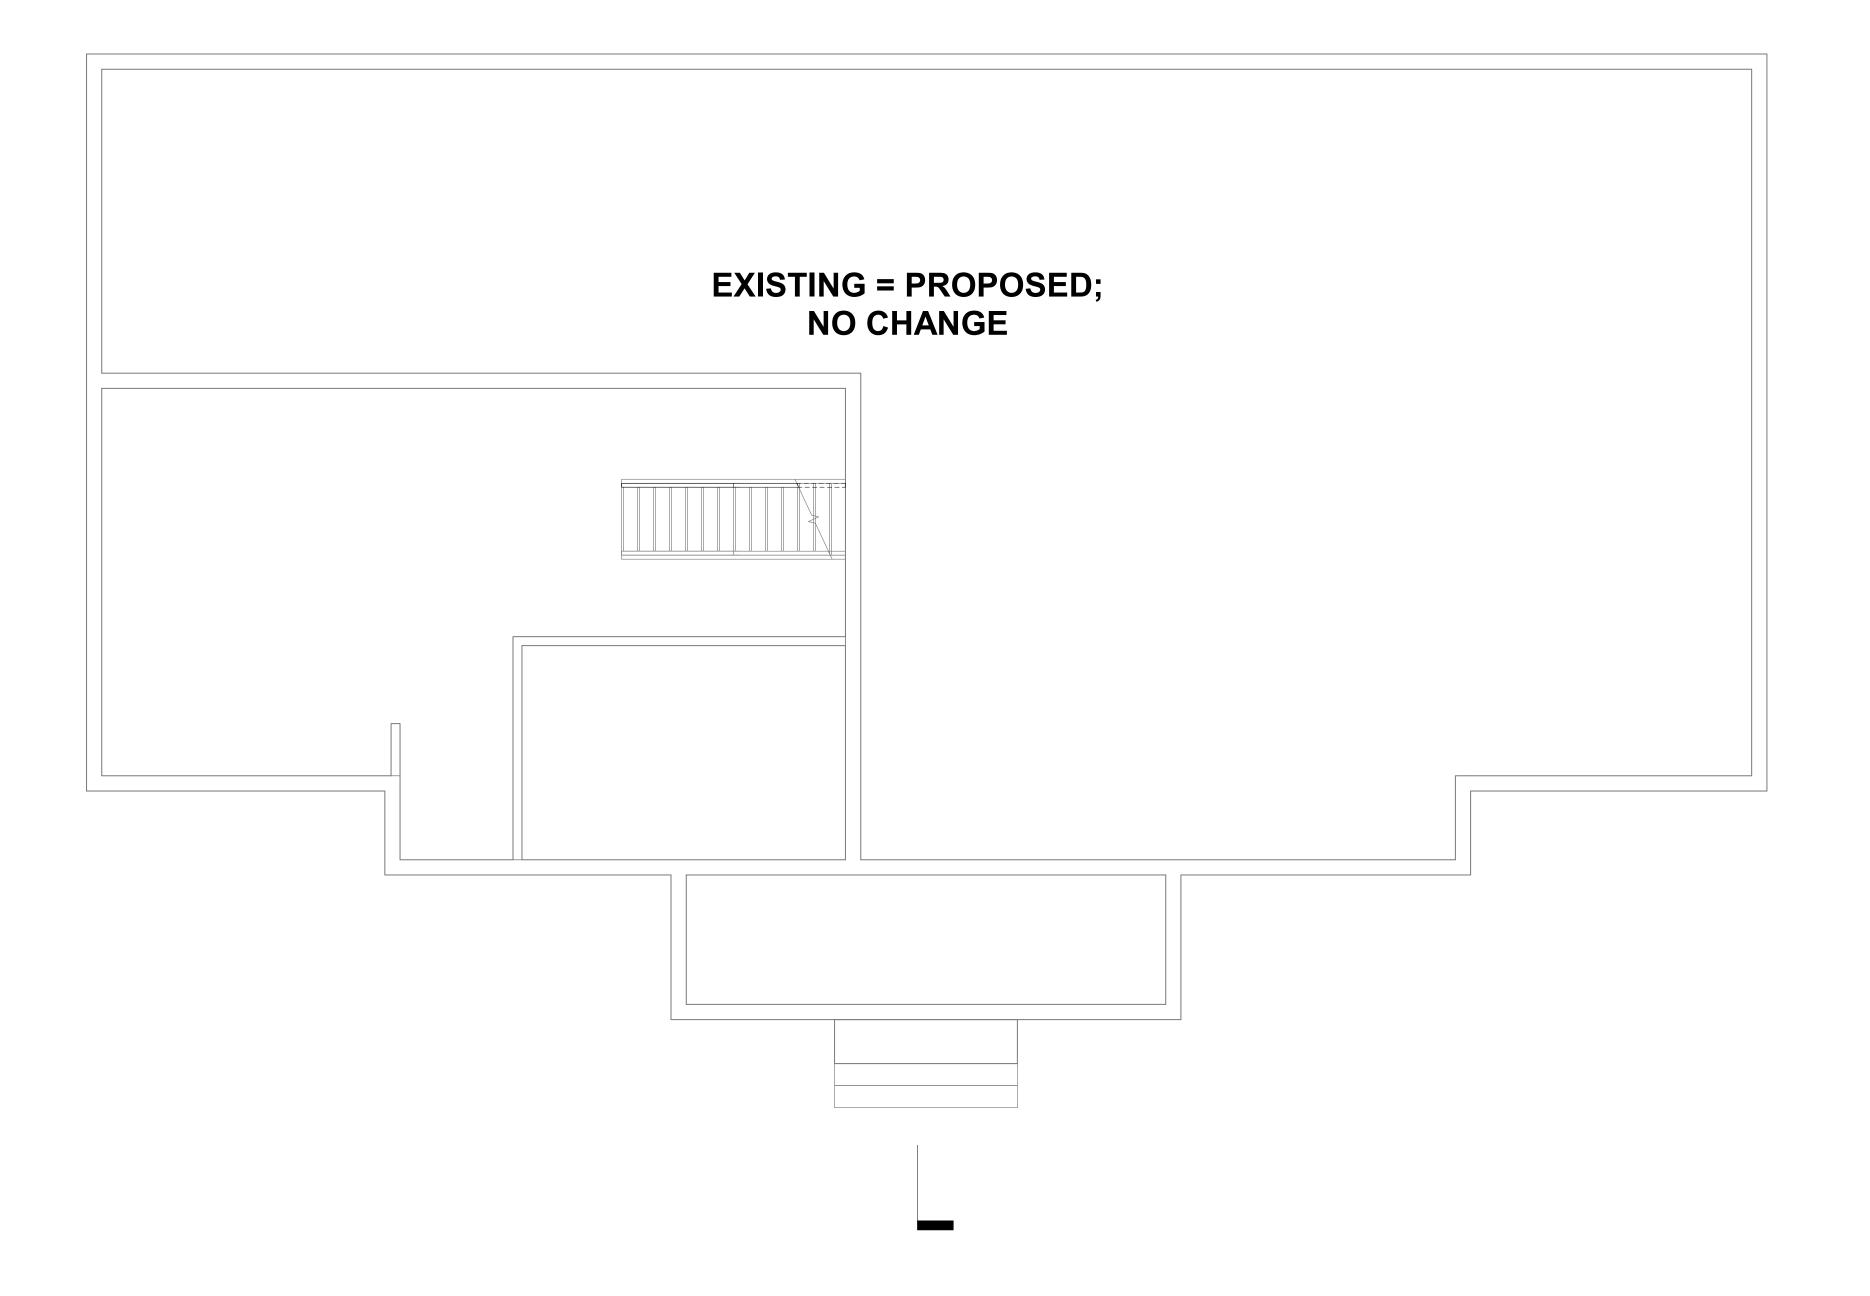
## Foundation & Framing Notes


05/26/2023 Author Drawn By

E002

As indicated Scale





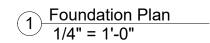

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C000's	Ex	isting & Proposed Elevations					
D000's	Ele	ectrical Plans					
E000's	Fo	undation & Framing Plans					
F000's	Sc	hedules					

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## Foundation Plans


Date 05/26/2023

Drawn By i20 Design

E003

ale 1/4" = 1'-0"



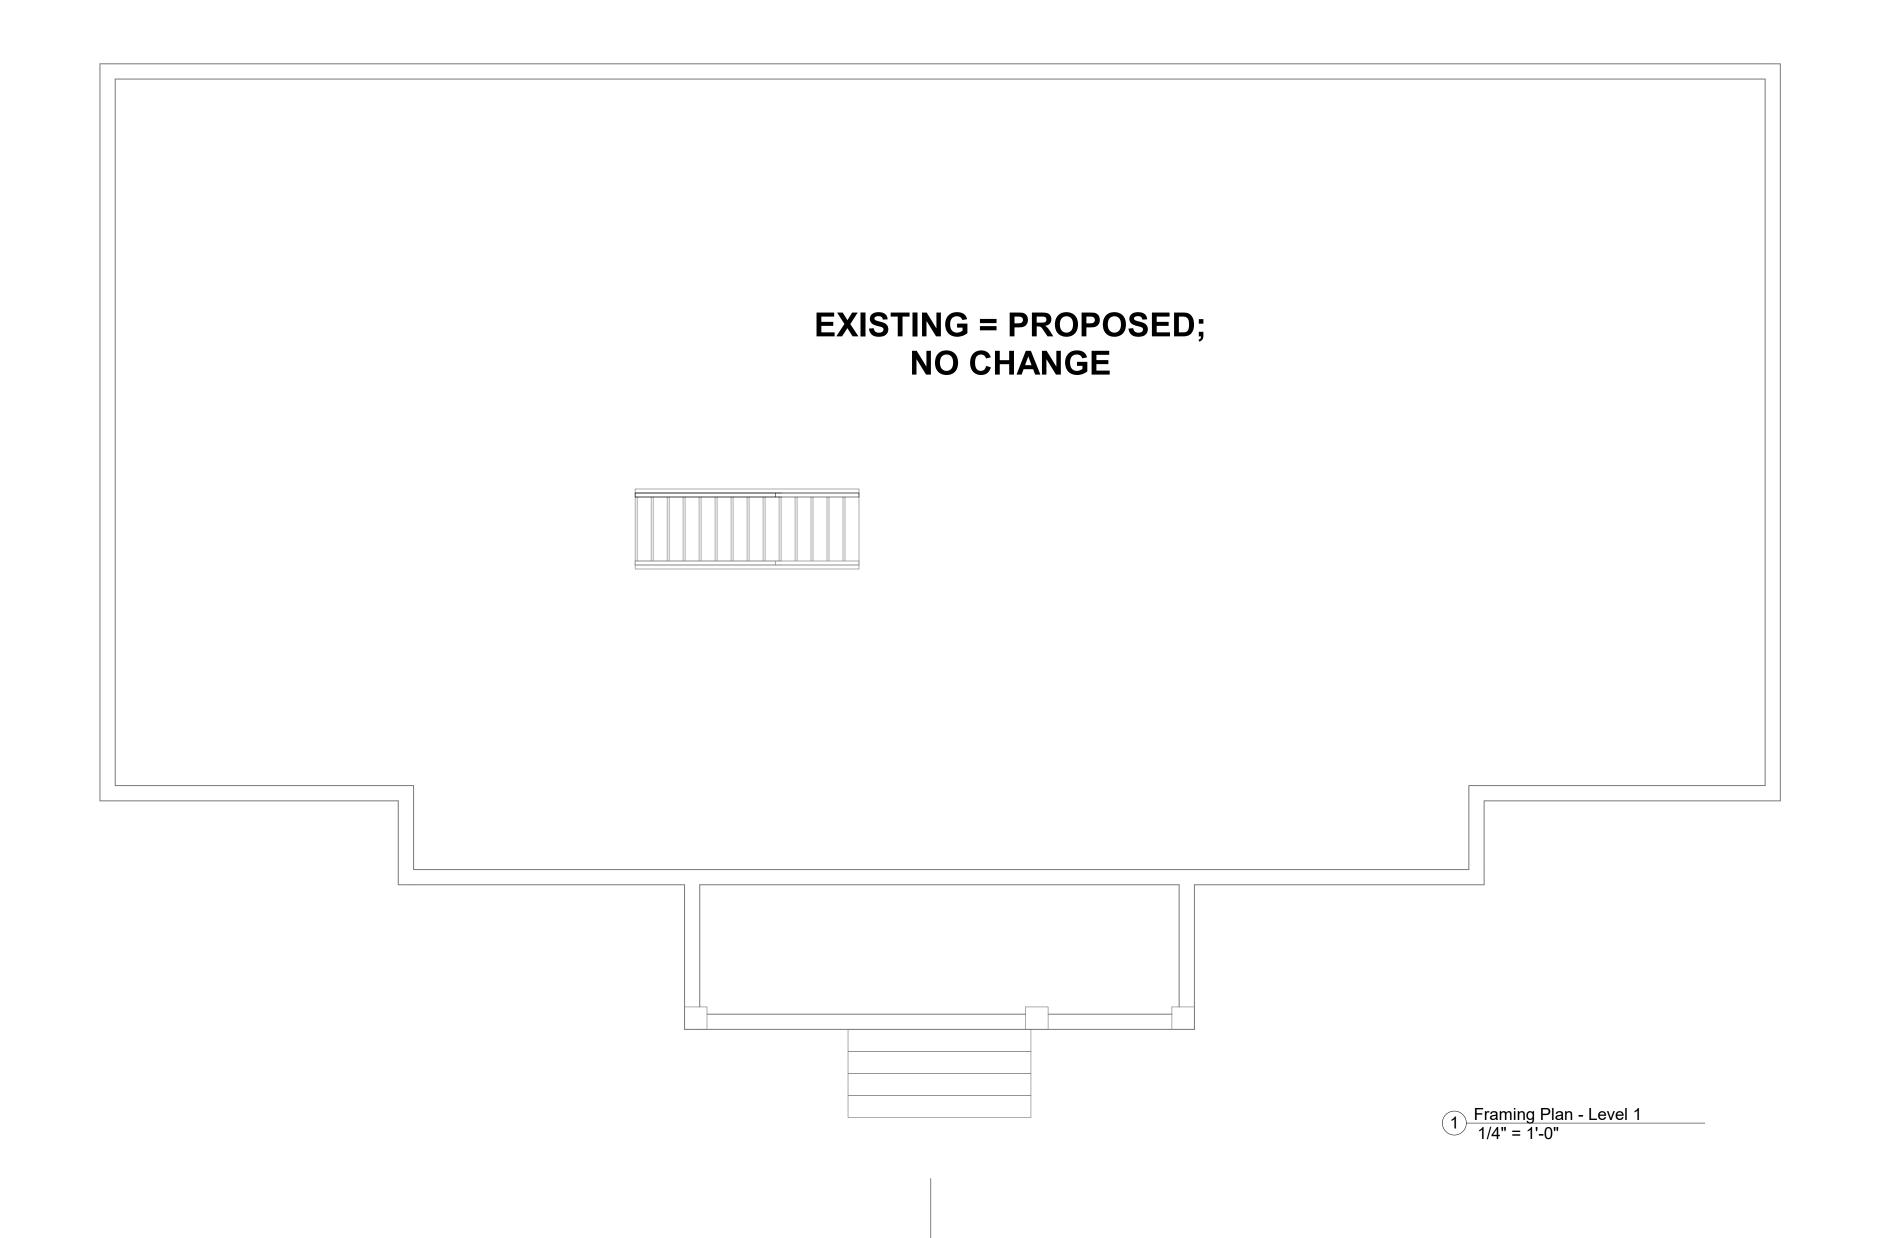

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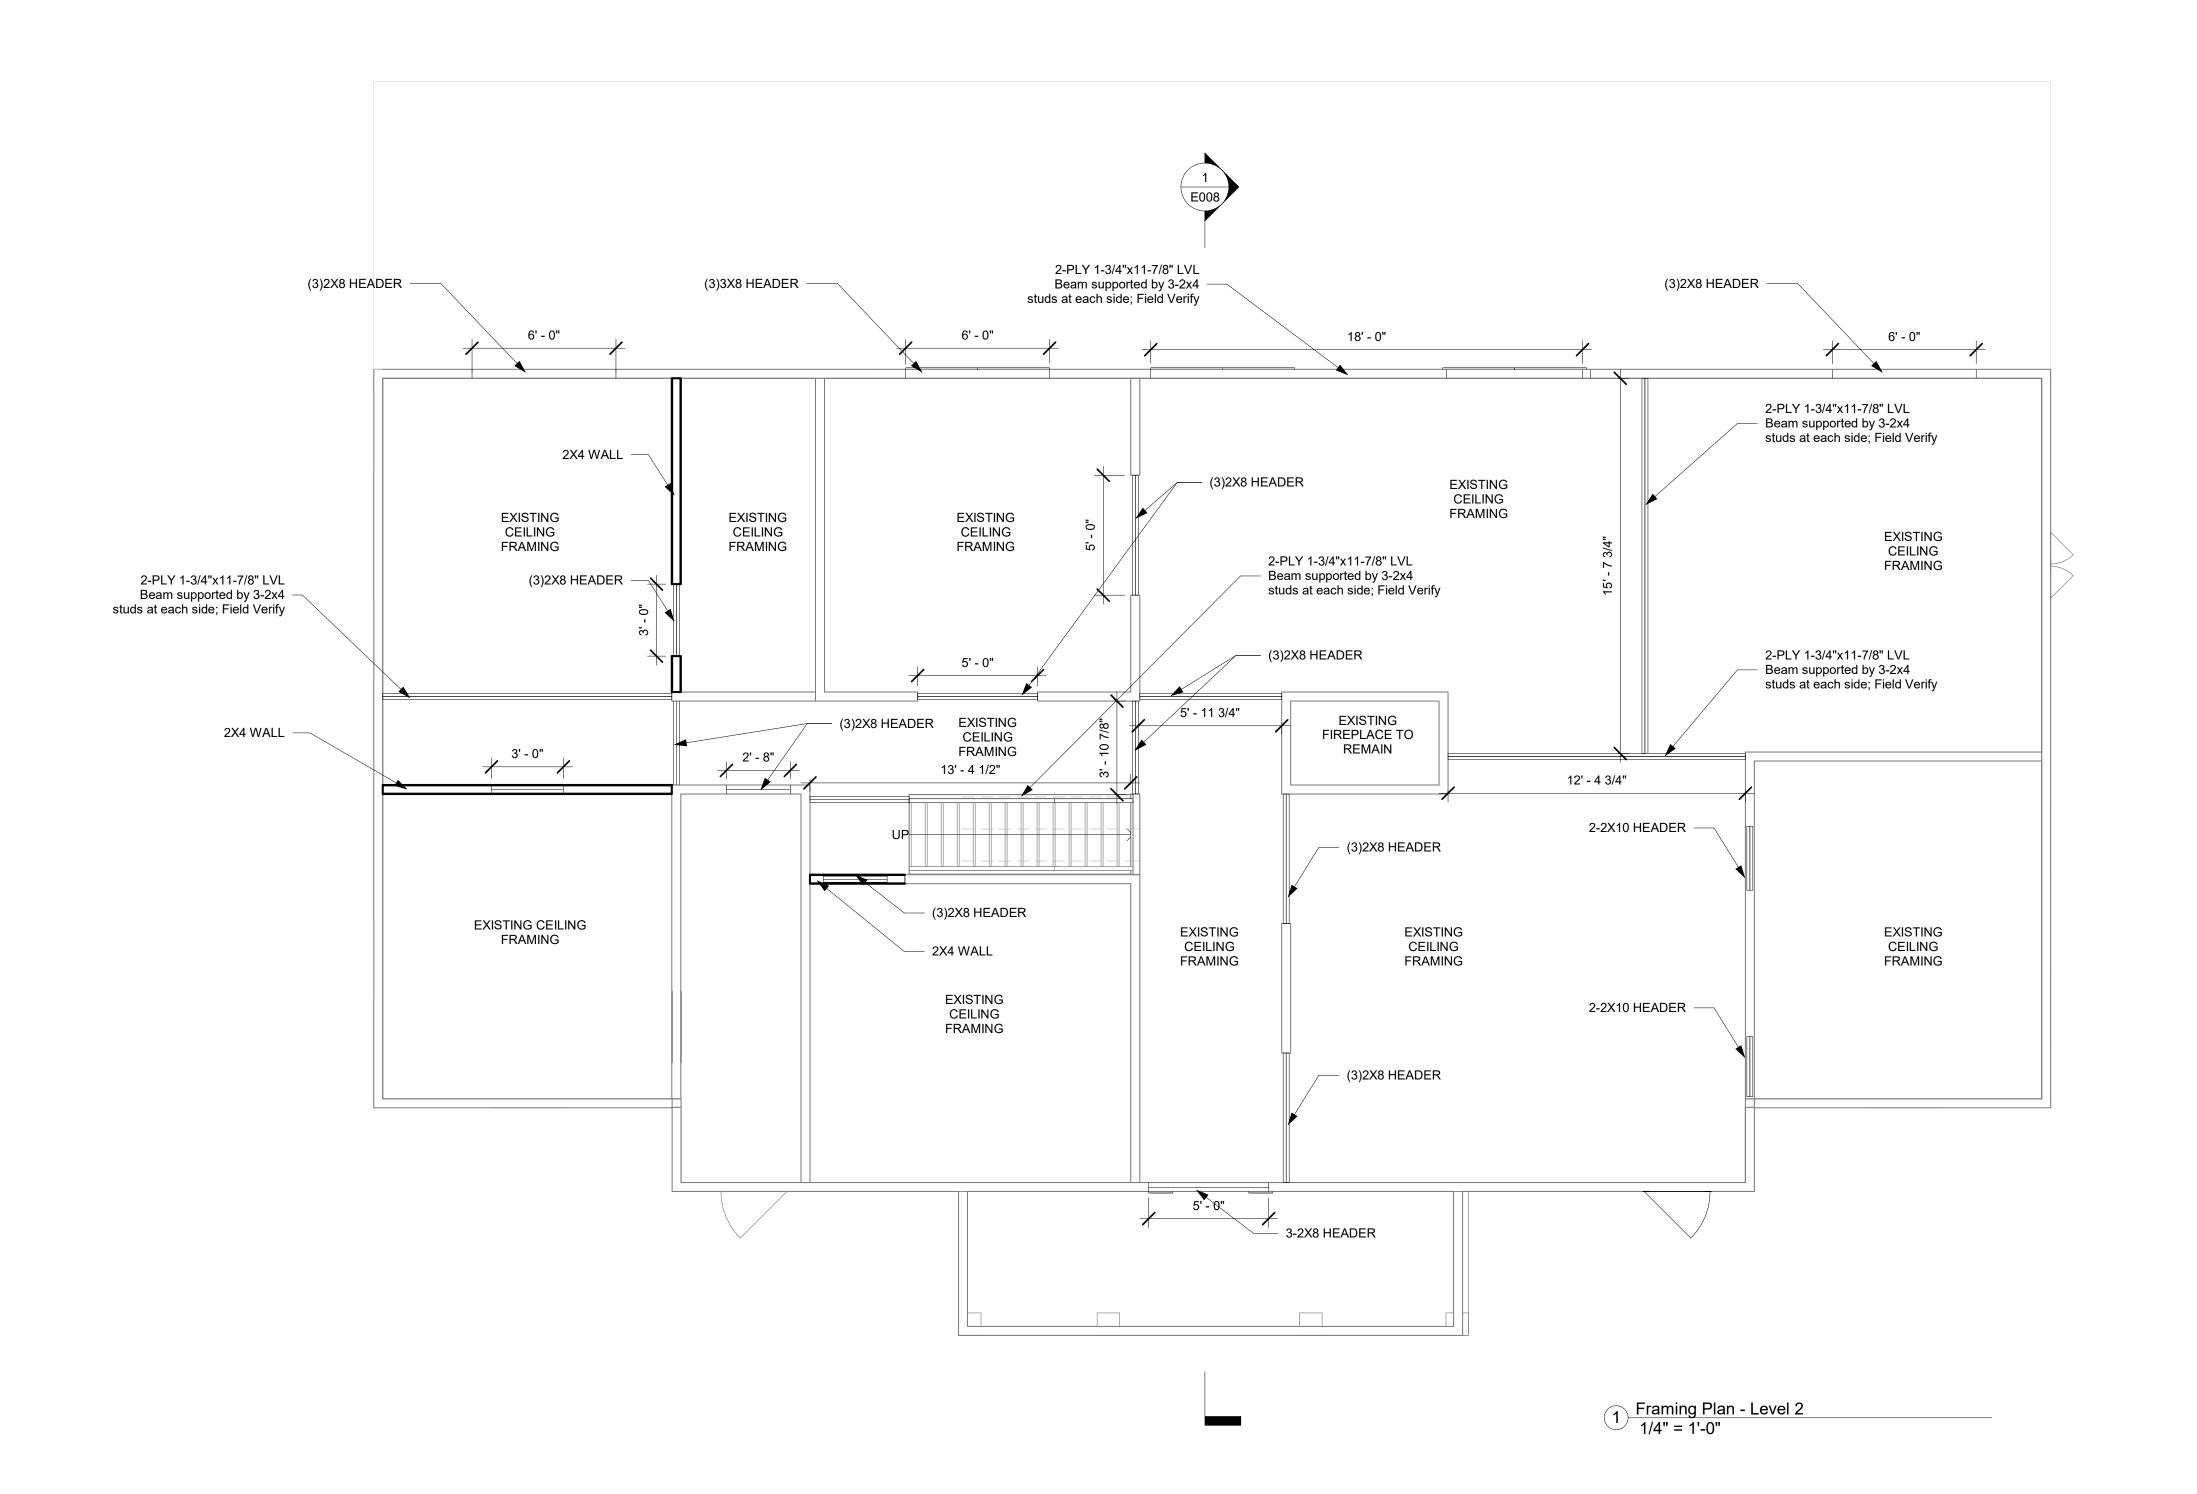
# Framing Plans -Level 1

Date 05/26/2023

Drawn By Author

E004

Scale 1/4" = 1'-0"



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B000's	Ex	isting & Proposed Floor Plans	3		
C000's	Ex	isting & Proposed Elevations			
D000's	Ele	ectrical Plans			
E000's	Fo	undation & Framing Plans			
F000's	Sc	hedules			

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# Barton Woods Alteration The Ansley's Residence

923 Barton Woods Rd. NE Atlanta GA 30307


# Framing Plans -Level 2

Date 05/26/2023

Drawn By Author

E005

ale 1/4" = 1'-0"

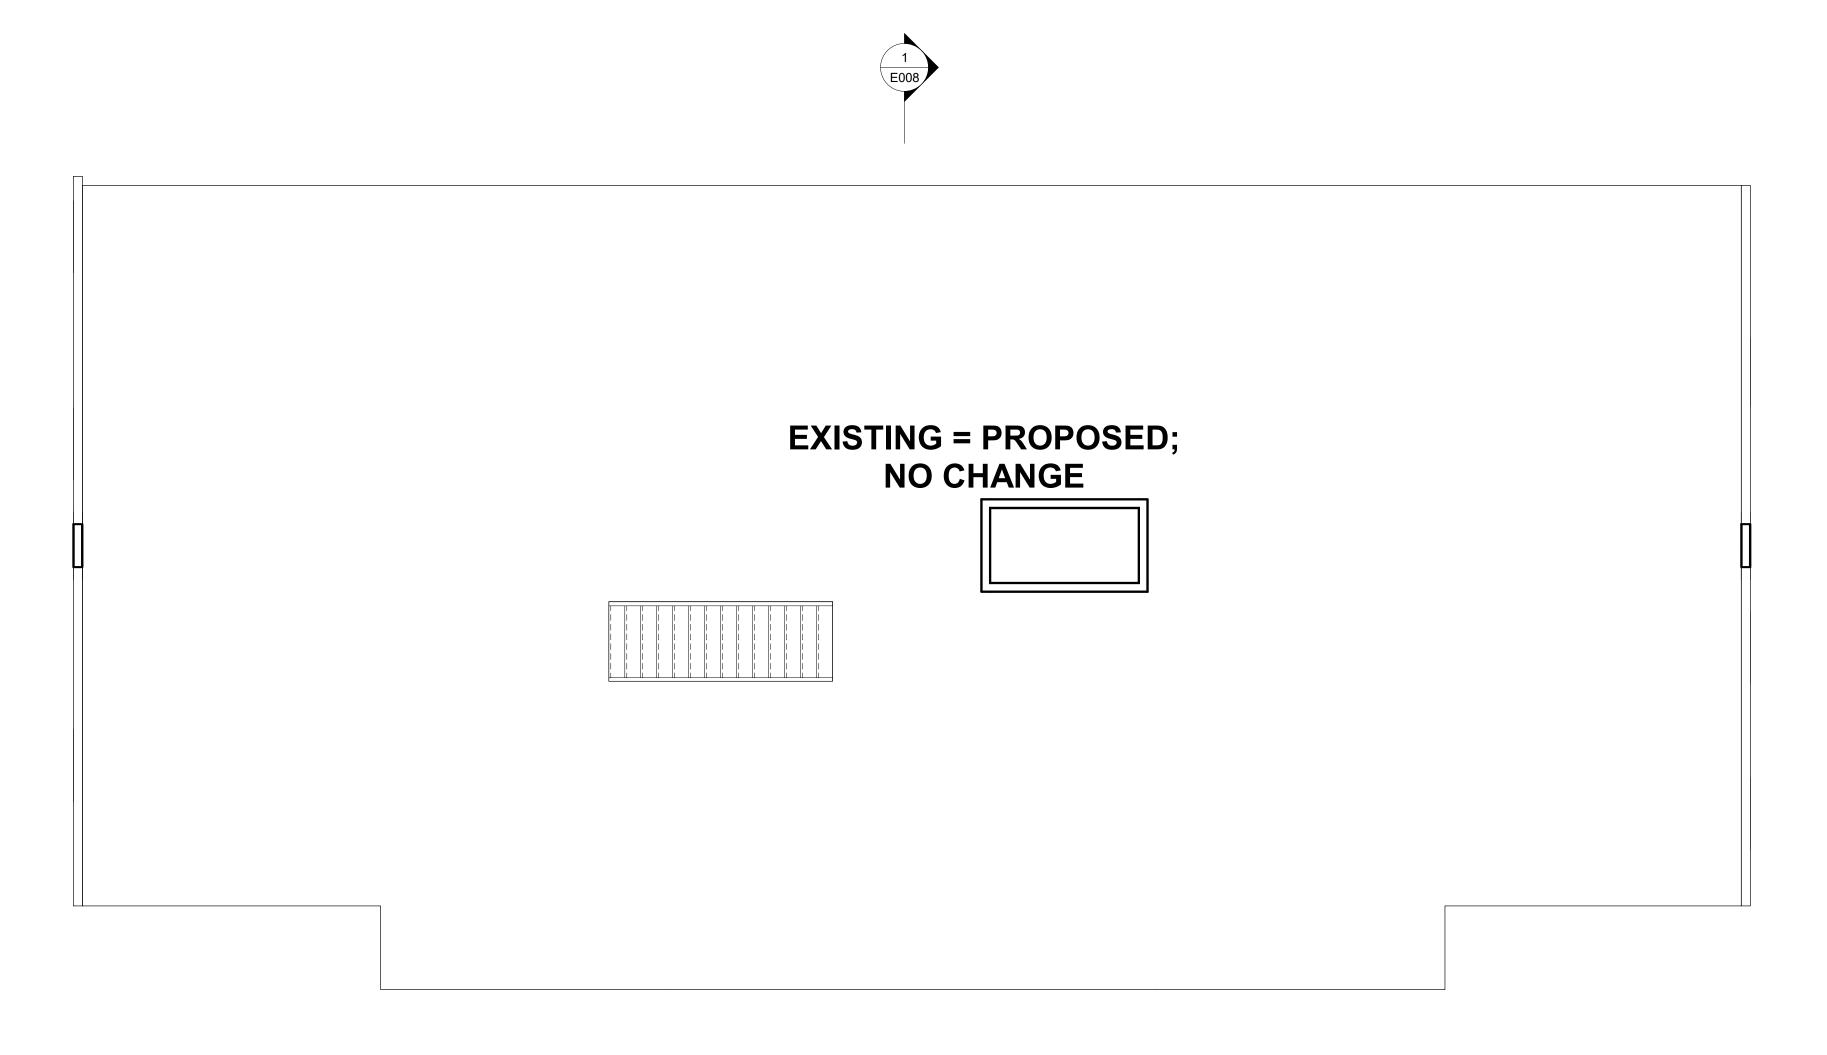

**----**

1 Framing Plan - Ceiling 1/4" = 1'-0"

A000's Cover Sheet & Perspectives 06/02/2023

B000's Existing & Proposed Floor Plans

C000's Existing & Proposed Elevations

D000's Electrical Plans

E000's Foundation & Framing Plans

F000's Schedules

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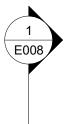
# Framing Plans -Level 3


Date 05/26/2023

Drawn By Author

E006

Scale 1/4" = 1'-0"



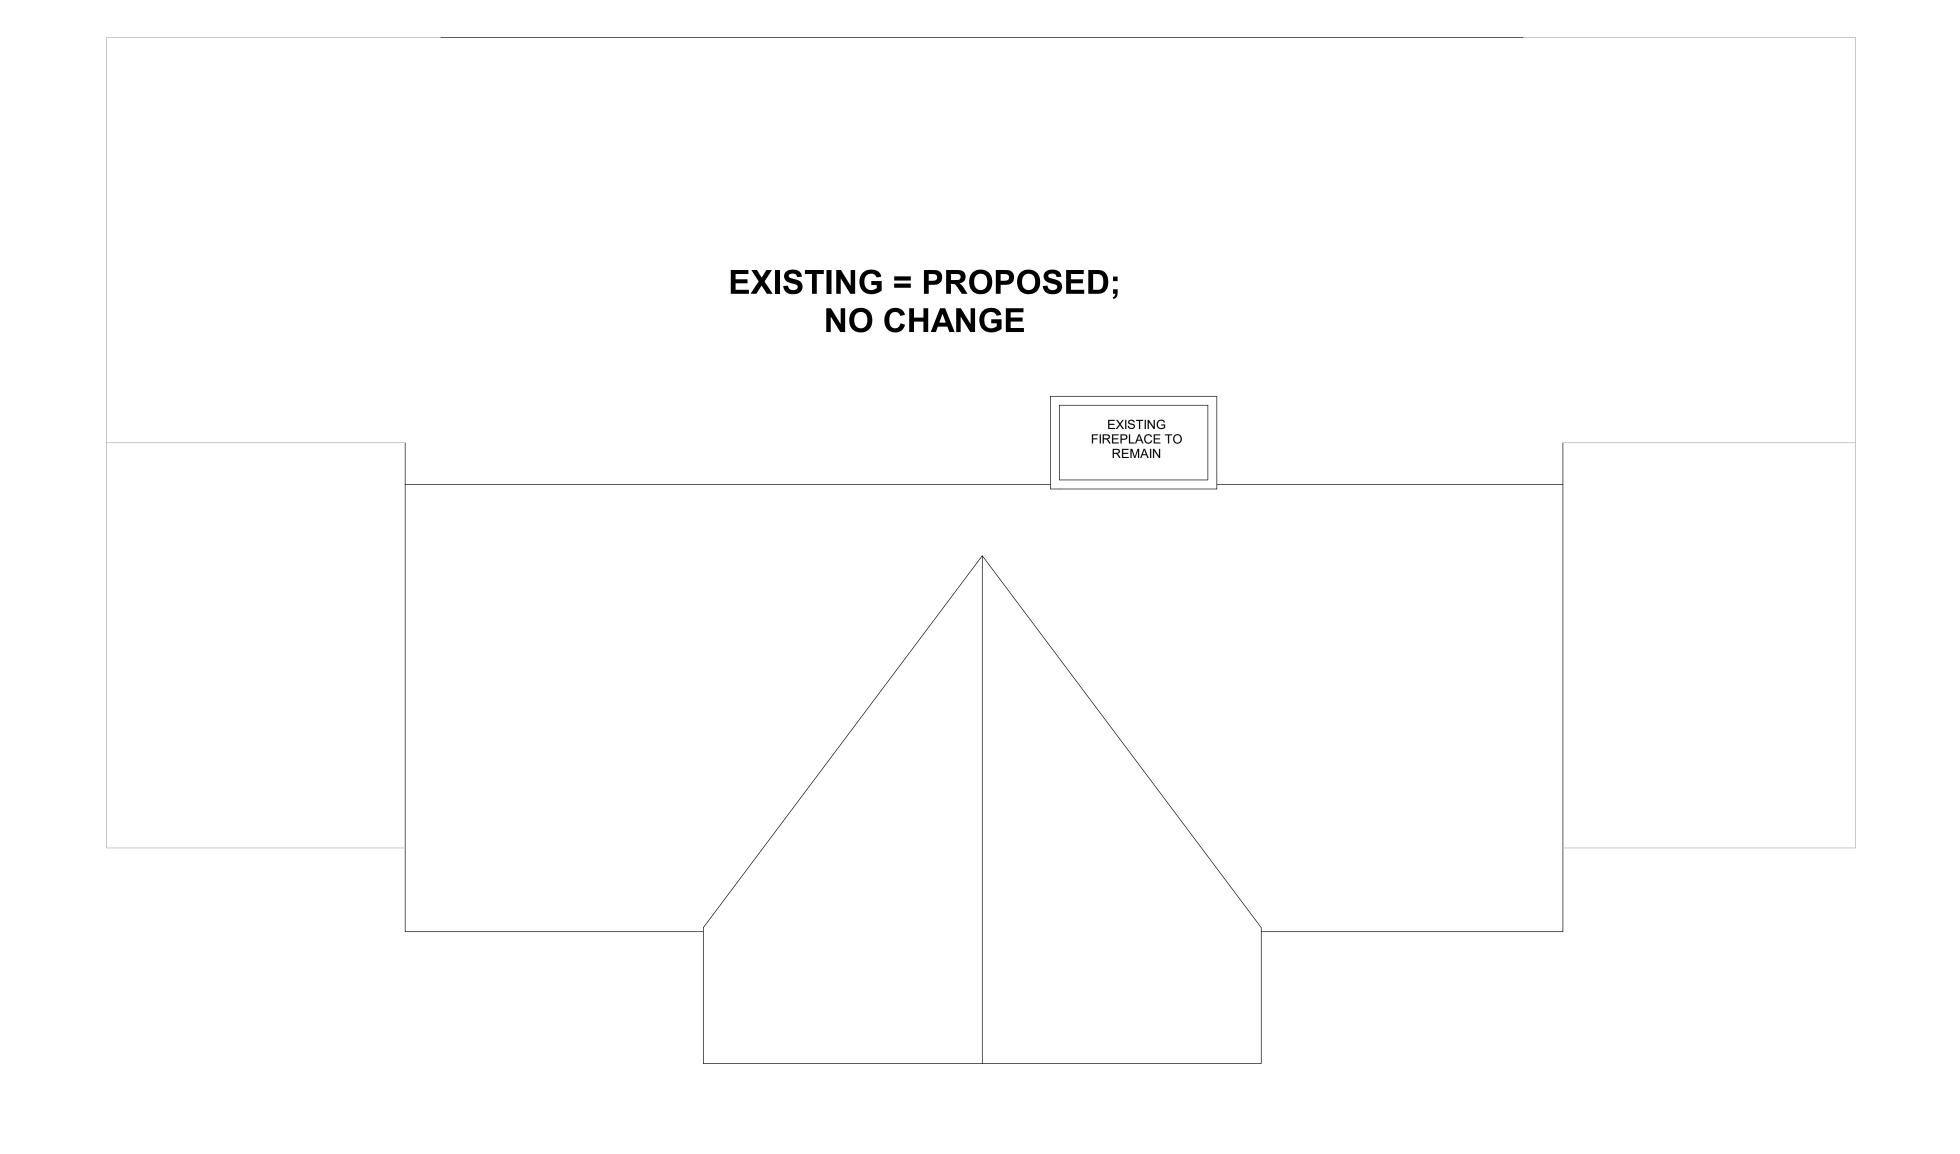

1 Framing Plan - Roof 1/4" = 1'-0"

Sheet #		Title		Date Issued	
A000's	Со	ver Sheet & Perspectives		06/02/2023	
B000's	Ex	isting & Proposed Floor Plans	\$		
C000's	Existing & Proposed Elevations				
D000's	Ele	ectrical Plans			
E000's	Fo	undation & Framing Plans			
F000's	Sc				
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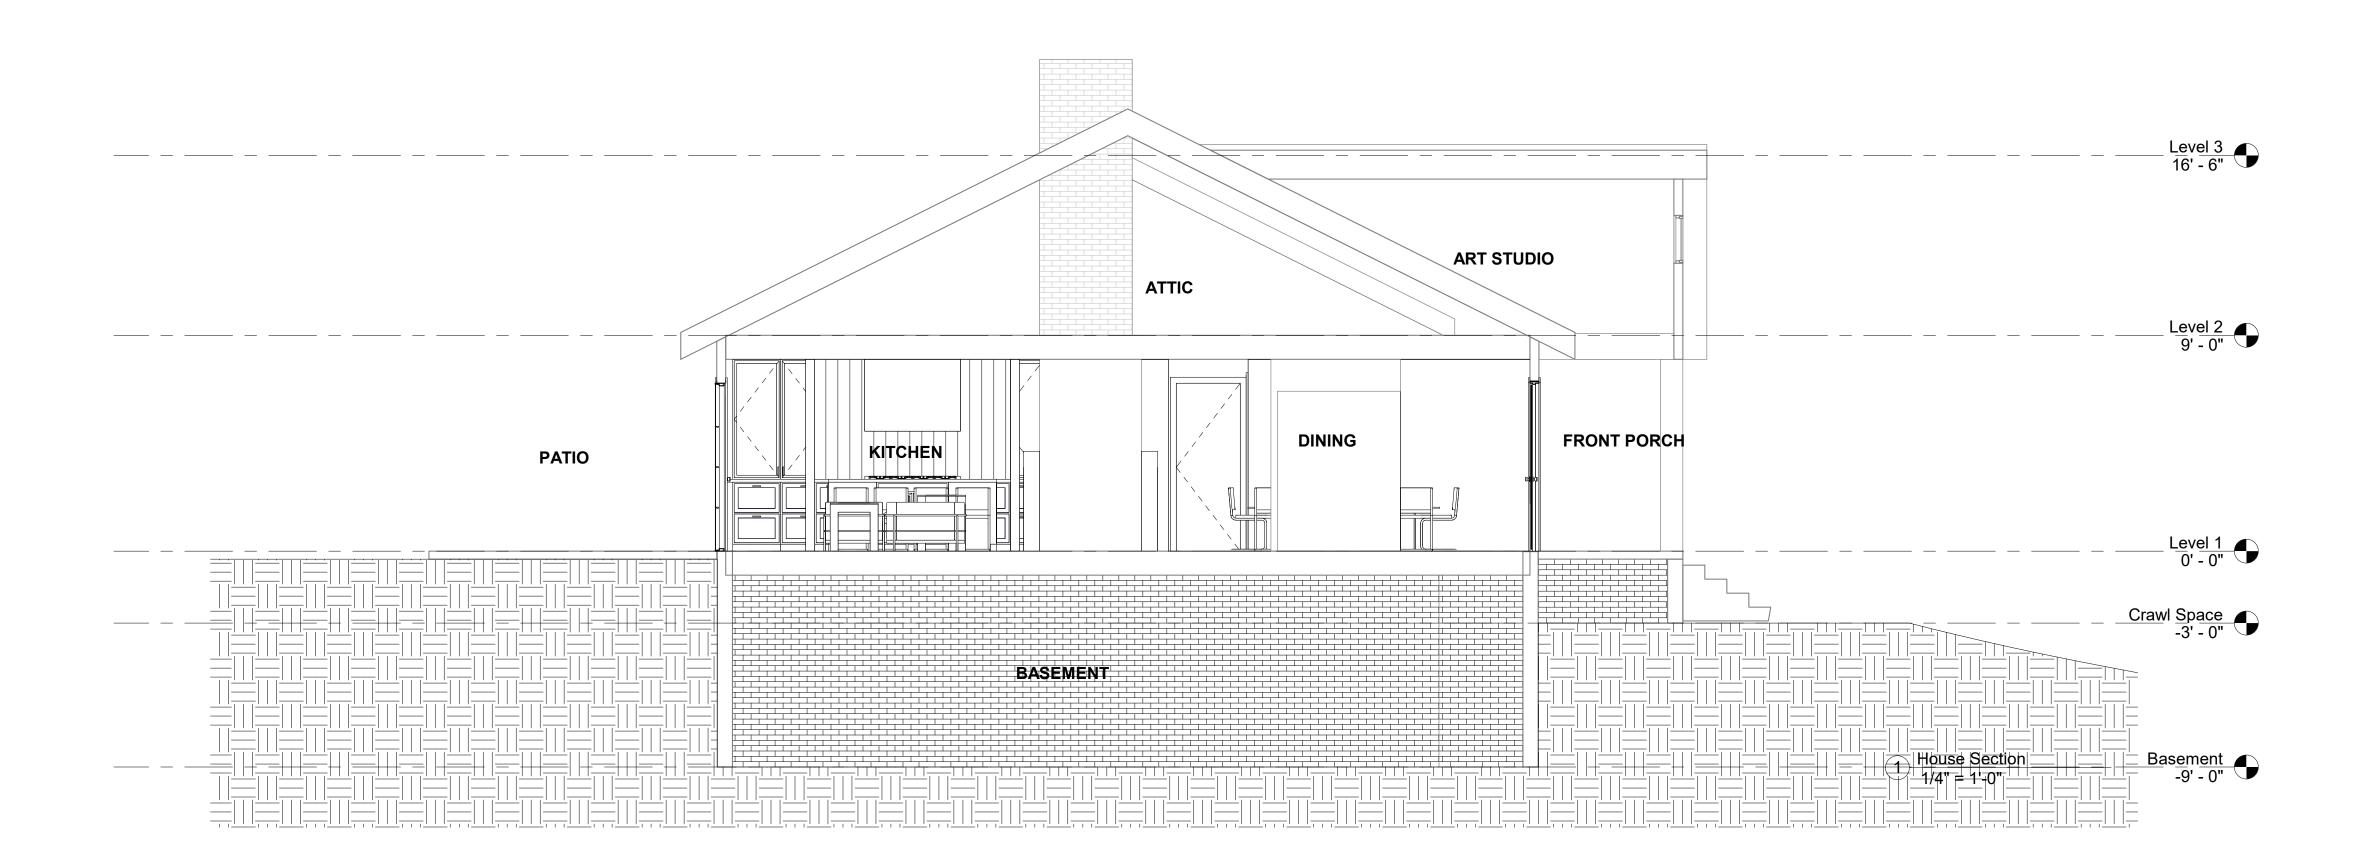
# Roof Framing Plans

Date 05/26/2023

Drawn By Author

E007

Scale 1/4" = 1'-0"



Sheet #	Title	Date Issued
A000's	Cover Sheet & Perspective	es 06/02/2023
B000's	Existing & Proposed Floor	Plans
C000's	Existing & Proposed Eleva	tions
D000's	Electrical Plans	
E000's	Foundation & Framing Plan	าร
F000's	Schedules	

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## **House Sections**


 Date
 05/26/2023

 Drawn By
 i20 Design

E008

ale 1/4" = 1'-0"


	Window Schedule						
Mark	Window Type	Height	Width	Count	Phase Created	Comments	
A	DH	4' - 0"	3' - 0"	7	Existing	WINDSOR MANUFACTURE; CONFIRM ALL SIXING; TYPICAL WINDOWS	
В	DH	6' - 0"	3' - 0"	4	Existing	WINDSOR MANUFACTURE; CONFIRM ALL SIXING; TYPICAL WINDOWS	
С	FX	2' - 10"	2' - 10"	2	Existing	WINDSOR MANUFACTURE; CONFIRM ALL SIXING; ATTIC WINDOWS	
D	DC	2' - 10"	2' - 10"	1	Existing	WINDSOR MANUFACTURE; CONFIRM ALL SIXING; LARDER SINK WINDOW	
E	SC	2' - 10"	2' - 10"	1	Existing	WINDSOR MANUFACTURE; BATHROOM WINDOW; SINGLE CASEMENT	
F	FX	2' - 0"	2' - 0"	1	Existing	FRONT PORCH GABLE; ROUND WINDOW	
E	SC	2' - 10"	2' - 10"	1	New Construction	WINDSOR MANUFACTURE; BATHROOM WINDOW; SINGLE CASEMENT	
G	FX	7' - 0"	3' - 0"	6	New Construction	WINDSOR MANUFACTURE	
Н	FX	7' - 0"	1' - 0"	2	New Construction	WINDSOR MANUFACTURE; FRONT DOOR SIDE LITE WINDOW	

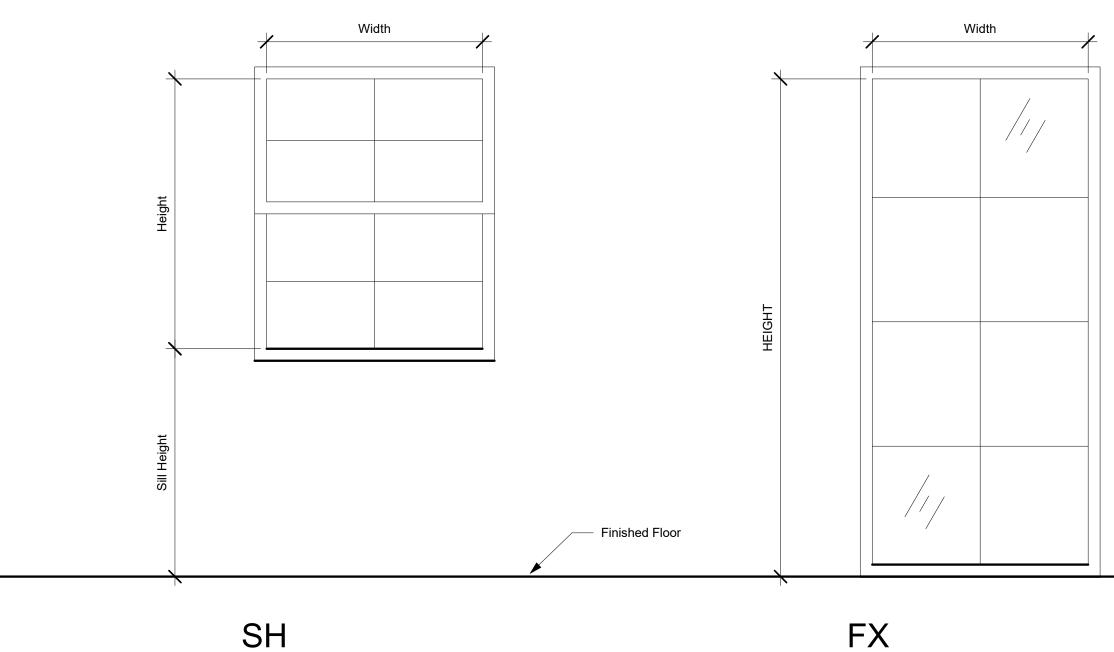

SINGLE HUNG

	Door Schedule							
Type Mark	Door Type	Height	Width	Function	Phase Created	Count	Comments	
1	SFG	7' - 0"	3' - 0"	Exterior	New Construction	1	WINDSOR MANUFACTURE; FRONT ENTRY DOOR	
2	SF	7' - 0"	2' - 8"	Interior	New Construction	5	TYPICAL INTERIOR DOORS	
4	SF	7' - 0"	2' - 6"	Interior	New Construction	1	HIDDEN DOOR; BASEMENT STAIR	
5	SF	7' - 0"	3' - 0"	Interior	New Construction	1	MASTER BEDROOM DOOR	
6	DFG	7' - 0"	6' - 0"	Exterior	New Construction	3	WINDSOR MANUFACTURE; FRENCH DOORS	
7	PK	7' - 0"	3' - 0"	Interior	New Construction	1	INTERIOR POCKET DOORS	
8	BF	7' - 0"	4' - 0"	Interior	New Construction	2	BI-FOLD CLOSET DOOR	
9	SF	7' - 0"	3' - 0"	Interior	New Construction	1	INTERIOR DOORS; MASTER	
10	BF	7' - 0"	3' - 0"	Interior	New Construction	1	BI-FOLD CLOSET DOOR	

FIXED WINDOW

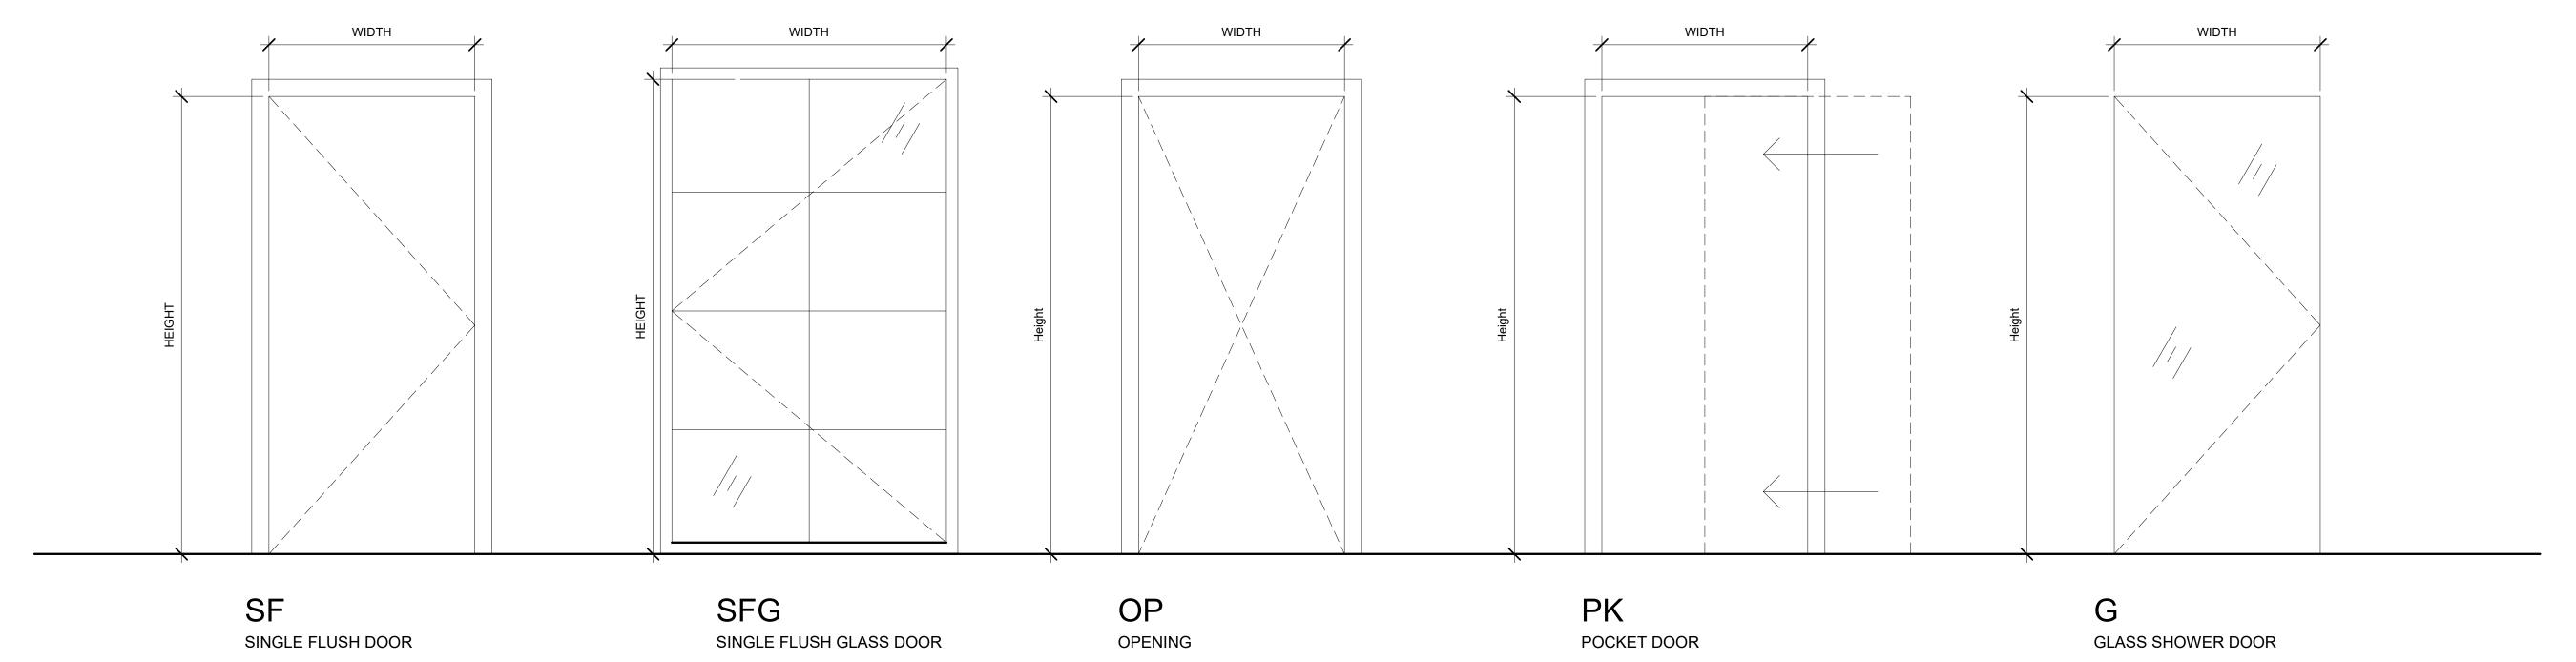

Sheet #		Title	Date Issued
A000's	Co	ver Sheet & Perspectives	06/02/2023
B000's	Exi	sting & Proposed Floor Plans	S
C000's	Exi	sting & Proposed Elevations	
D000's	Ele	ctrical Plans	
E000's	Fo	undation & Framing Plans	
F000's	Sc	nedules	

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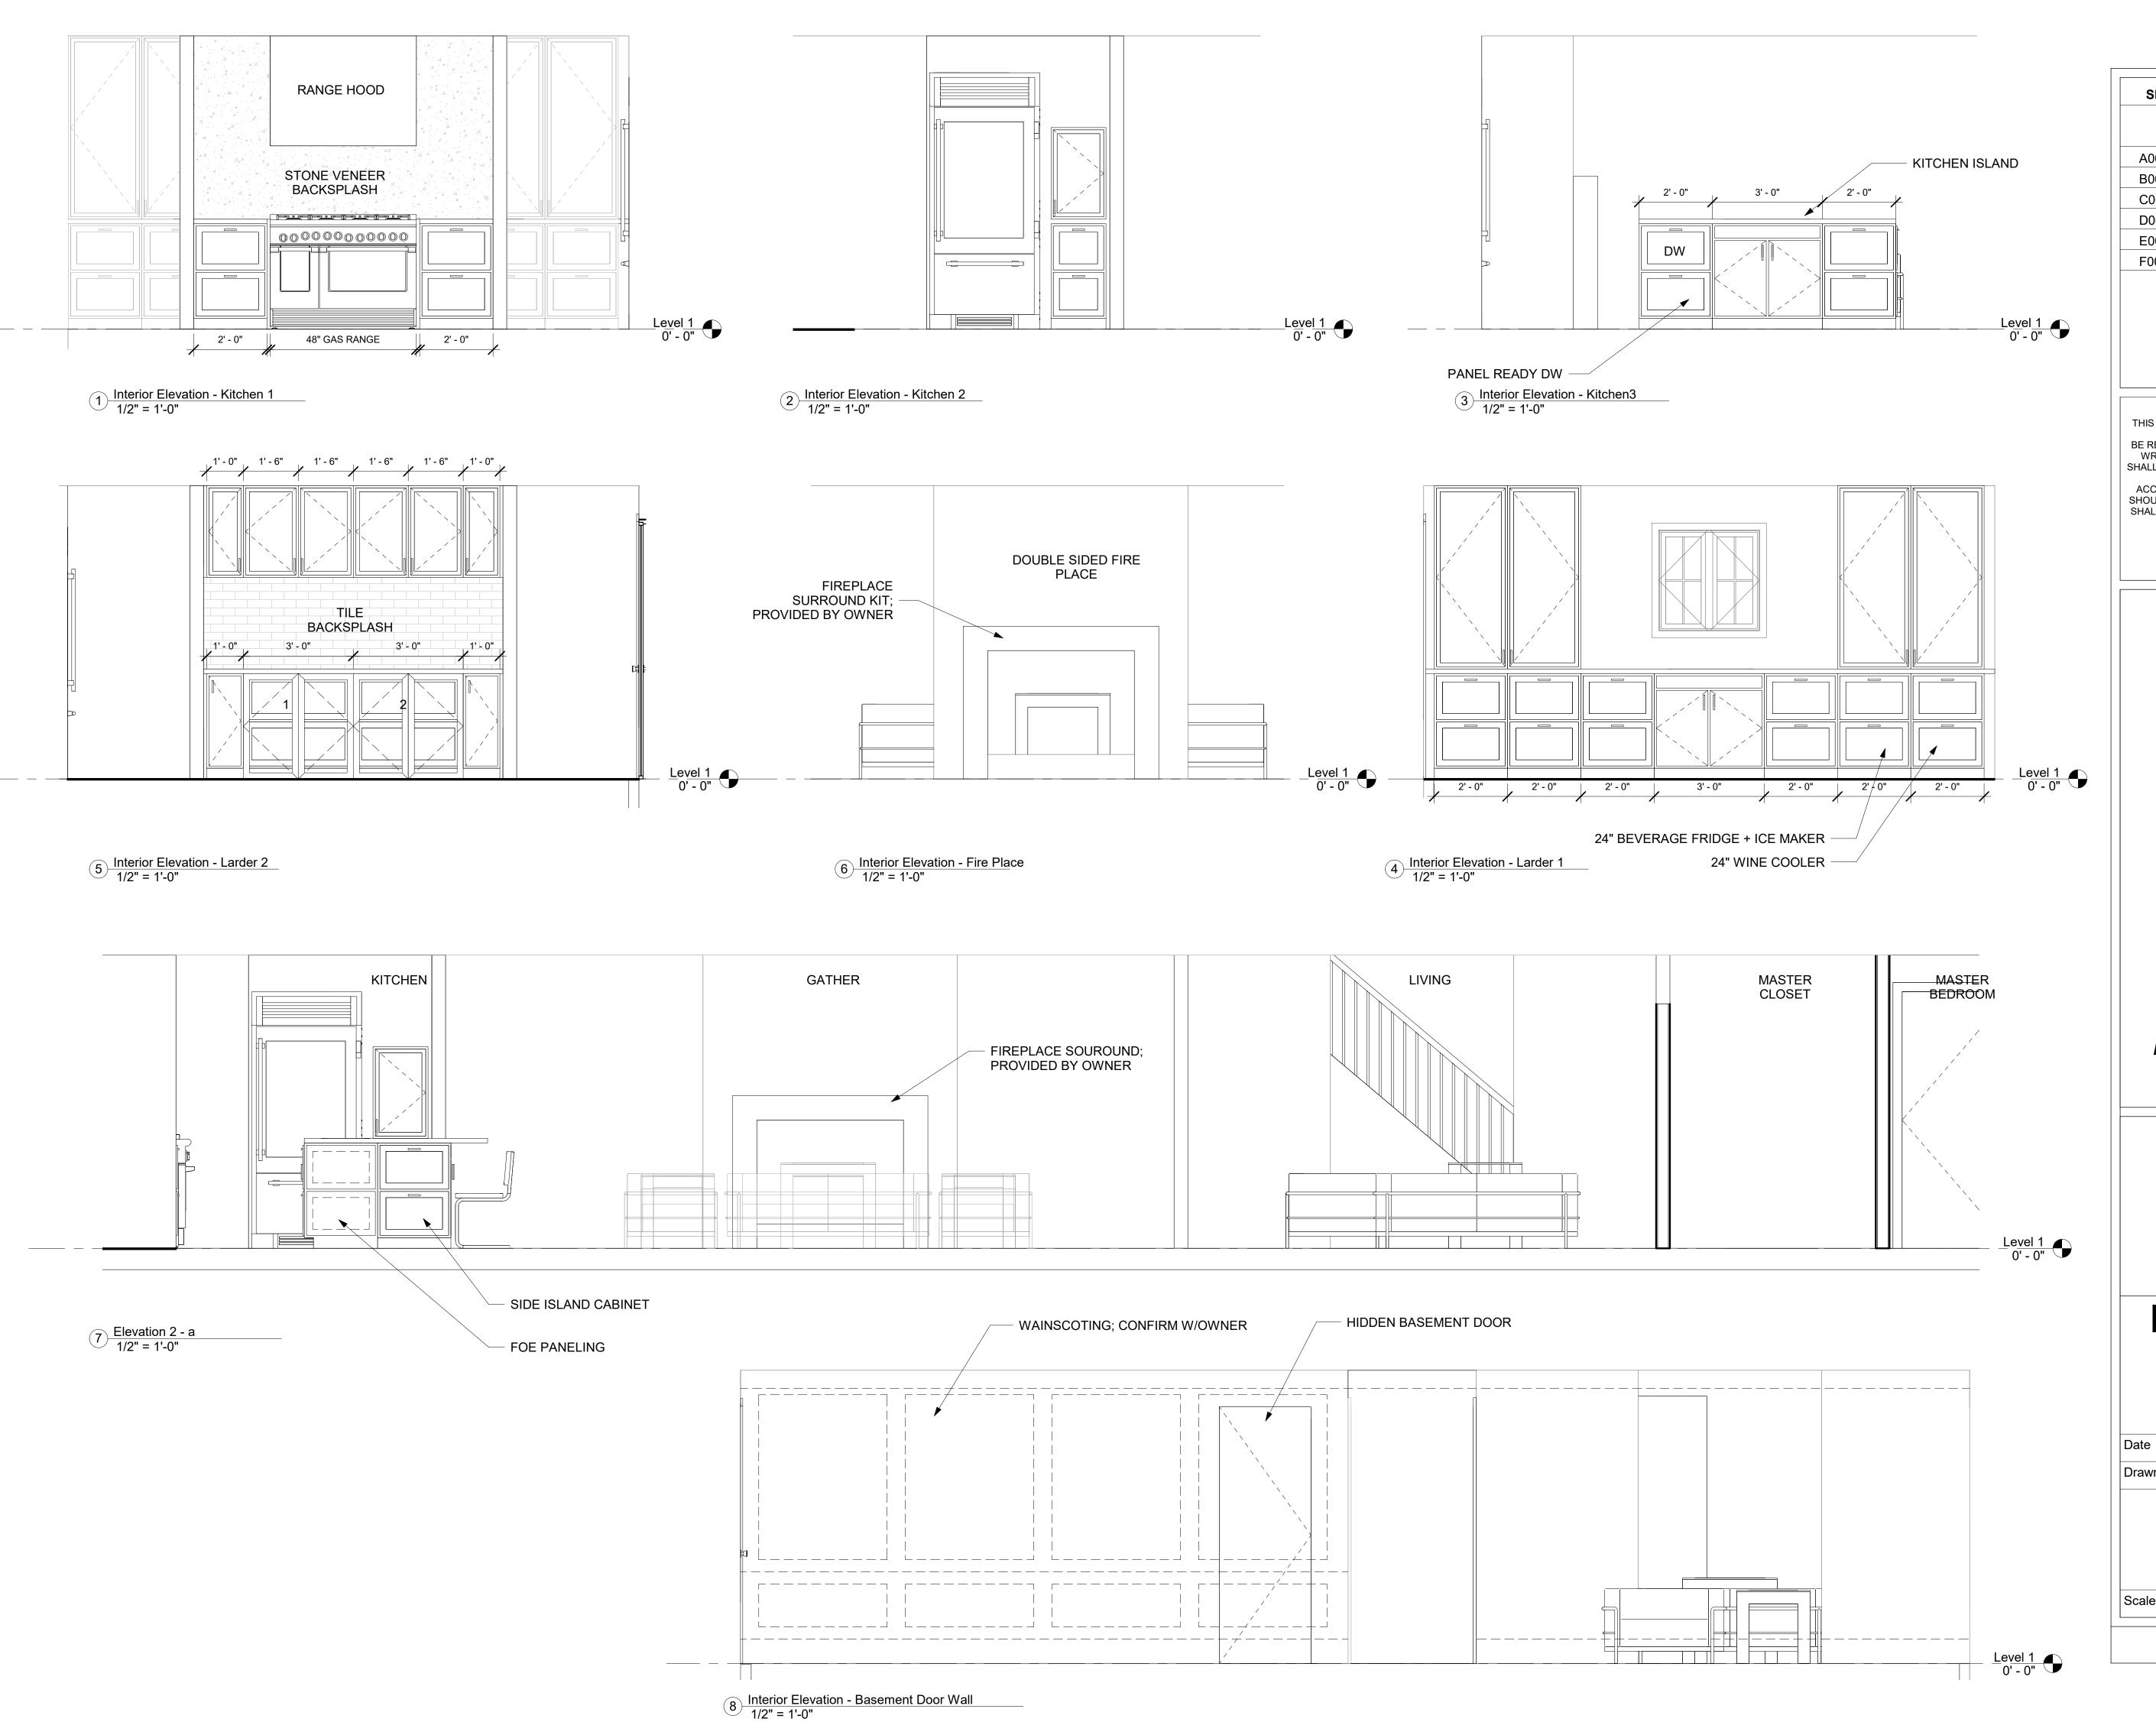
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## Window & Door Schedule

05/26/2023
Author
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F001

ale 3/4" = 1'-0"



Sheet #		Title	Date Issued	
A000's	Cover Sheet &	Perspectives	06/02/2023	
B000's	Existing & Prop	<b>i</b>		
C000's	Existing & Prop			
D000's	Electrical Plans			
E000's	Foundation & F	raming Plans		
F000's	Schedules			

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## Interior Elevations

Date 05/26/2023
Drawn By Author

G001

1/2" = 1'-0"