

Development Services Center 178 Sams Street Decatur, GA 30030 www.dekalbcountyga.gov/planning 404-371-2155 (o); 404-371-4556 (f)

Chief Executive Officer
Michael Thurmond

DEPARTMENT OF PLANNING & SUSTAINABILITY

Interim Director
Cedric Hudson

Application for Certificate of Appropriateness

Date Received: Application	n No.:
Address of Subject Property:	
Applicant:	E-Mail:
Applicant Mailing Address:	
Applicant Phone:	Fax:
Applicant's relationship to the owner: Owner □ Architect: □	Contractor/Builder
Owner(s):	Email:
Owner(s):	Email:
Owner(s) Mailing Address:	
Owner(s) Telephone Number:	
Approximate age or date of construction of the primary structure	e on the property and any secondary structures affected by this project:
Nature of work (check all that apply):	
	ing a building Other building Other environmental
Description of Work:	

This form must be completed in its entirety and be accompanied by supporting documents, such as plans, list of materials, color samples, photographs, etc. All documents should be in PDF format, except for photographs, which may be in JPEG format. Email the application and supporting material to plansustain@dekalbcountyga.gov and rlbragg@dekalbcountyga.gov An incomplete application will not be accepted.

Signature of Applicant:



Authorization of a Second Party to Apply for a Certificate of Appropriateness

This form is required if the individual making the request is **not** the owner of the property.

I/ We:
being owner(s) of the property at:
hereby delegate authority to:
to file an application for a certificate of appropriateness in my/our behalf.
Signature of Owner(s): /s/ Nic Prouker
Date

Please review the following information

Approval of this Certificate of Appropriateness does not release the recipient from compliance with all other pertinent county, state, and federal regulations.

Before making any changes to your approved plans, contact the preservation planner (404/371- 2155). Some changes may fall within the scope of the existing approval, but others will require review by the preservation commission. If work is performed which is not in accordance with your certificate, a Stop Work Order may be issued.

If your project requires that the county issue a Certificate of Occupancy at the end of construction, an inspection may be made to verify that the work has been completed in accord with the Certificate of Appropriateness. If the work as completed is not the same as that approved in the Certificate of Appropriateness you will not receive a Certificate of Occupancy. You may also be subject to other penalties including fines and/or required demolition of the non-conforming work.

If you do not commence construction within twelve months of the date of approval, your Certificate of Appropriateness will become void and you will need to apply for a new certificate if you still intend to do the work.



DEKALB COUNTY HISTORIC PRESERVATION COMMISSION

2023 Calendar

This calendar is subject to change. Please visit the **Department of Planning and Sustainability** website for the current calendar, agenda, and applications.

Applications Accepted	<u>Filing Deadline</u>	Sign Must Be Posted	HPC Meeting Date	<u>Last Date to File</u> <u>Appeal</u> (approximate)
December 12	December 23	January 07	January 17	February 02
January 17	January 30	February 11	February 21	March 09
February 13	February 24	March 10	March 20	April 04
March 13	March 24	April 07	April 17	May 02
April 10	April 21	May 05	May 15	May 30
May 15	May 26	June 10	June 20	July 05
June 12	June 23	July 07	July 17	August 01
July 17	July 28	August 11	August 21	September 5
August 14	August 25	September 08	September 18	October 03
September 11	September 22	October 06	October 16	October 31
October 16	October 27	November 03	November 13	December 05
November 13	November 24	December 08	December 18	January 02

Tuesday meeting due to holiday



How to Obtain a Certificate of Appropriateness

- 1. Contact the DeKalb County Department of Planning and Sustainability for an application form. You may make your request by email plansustain@dekalbcountyga.gov AND rlbragg@dekalbcountyga.gov. telephone (404) 371-2247, or fax (404) 371-2813, or visit the website at https://www.dekalbcountyga.gov/planning-and-sustainability/forms
- 2. Complete and submit the application. Please provide as much supporting material as possible,(plans, material, color samples, photos, etc.). All documents must be in PDF format except for photographs, which may be in JPEG format. Applications are accepted for a 10-day period each month. See page 3 (HPC Calendar). Email the application and supporting documents to plansustain@dekalbcountyga.gov AND rlbragg@dekalbcountyga.gov. If all documents are not provided the application will not be complete and will not be accepted.
- 3. The Preservation Planner will send you a sign template. You must coordinate with a sign vendor of your choice to post the sign by the required date (see HPC Calendar).
- 4. The Preservation Planner may visit the property as part of their review. The commission members may view the property from the right-of-way.
- 5. Applications will be reviewed by the DeKalb County Historic Preservation Commission at its monthly meeting. The Historic Preservation Commission meets on the third Monday at 6 p.m., via Zoom. In unusual circumstances meeting dates and location may be changed.
- 6. The Historic Preservation Commission may approve, approve with modifications or deny an application. The applicant or any affected person as defined by county code may appeal the decision to the DeKalb County Board of Commissioners. Please contact the Department of Planning and Sustainability if you wish to file an appeal. The Historic Preservation Commission is required to make a decision on an application within 45 days of the date of filing, although this time can be extended if the applicant agrees to a deferral.
- 7. Although not required, applicants are encouraged to attend the Historic Preservation Commission meetings. Applicants may make a presentation, but presentations are not required. The commissioners may have questions for the applicant.
- 8. Approval of a Certificate of Appropriateness does not release the recipient from compliance with all other county, state and federal regulations. Your application may still require a variance or other approvals.



Design Checklist for a Certificate of Appropriateness

This checklist was created to help applicants prepare a complete application. Omissions and inaccurate information can lead to deferrals and/or denials of applications. Please review the checklist with the project's architect, designer, or builder. All items will not be applicable to all projects. New construction will involve all categories. One copy of drawings at scale (plus nine reduced sets) should be submitted.

Please address questions regarding applicability to your project to the DeKalb County Preservation Planner at 404-371-2155, e-mail dccullis@dekalbcountyga.gov and rlbragg@dekalbcountyga.gov.

Applicants are also referred to the DeKalb County website, http://www.dekalbcountyga.gov/planning-and-sustainability/planning-sustainability.

I have reviewed the "Design Manual for the Druid Hills Local Historic District".	Y N
I have reviewed the DeKalb County Tree Ordinance.	Y N
I have reviewed applicable zoning codes regarding lot coverage, garage sizes, stream	Y N
buffers.	

1. General

- a. Label all drawings with the address of the site, owners' name, and contact phone number.
- b. Number all drawings.
- c. Include a graphic scale on reductions.
- d. Date all revisions.
- e. Indicate all unverified numbers with +/- signs
- f. Include photos of the existing condition of the property.

2. Site Plan (existing and proposed) to include:

- a. Topographical plan with significant trees sized and located;
- b. Setback compared to adjacent houses (ask surveyor to show corners of adjacent houses);
- c. Distance between houses;
- d. Façade width to finished face of material;
- e. Grading and elevations across site;
- f. Dirt removal or regrading if more than 18";
- g. Tree protection plan;
- h. Tree removal and replacement plan

3. Driveways and Walkways

- a. Location and relationship to house;
- b. Width;
- c. Material;
- d. Curb cut and apron width



4. Fences & Retaining Walls

- a. Placement on lot;
- b. Height of fence or wall. If retaining wall, height on both sides;
- c. Material;
- d. Railing if necessary

5. Elevations and Floor Plans: << Indicate all unverified numbers with +/- signs>>

- a. Plans for all floors (drawn to scale, ¼"=1' preferred);
- b. House orientation on site plan;
- c. Scalable elevations for front, rear, left, right;
- d. Height, grade to ridge;
- e. Streetscape comparison showing heights of two flanking houses on each side;
- f. Height from grade to first floor level at all four corners;
- g. Height from grade or finished floor line to eaves at all four corners;
- h. Ceiling heights of each floor, indicating if rough or finished;
- i. Height of space between the ceiling and finished floor above;
- j. Two people of 5'-6" and 6' height shown;
- k. Landscaping plan

6. Additions

- a. Placement shown on elevations and floor plan;
- b. Visibility from rights-of-way and paths;
- c. Photos of all facades;
- d. Design proportioned to main house;
- e. Landscaping plan;
- f. Materials and their combinations

7. Roof Plan

- a. Shape and pitch of roof;
- b. Roofing material;
- c. Overhang;
- d. Louvers and vents;
- e. Chimney height and material

8. Dormers

- a. Construction details provided;
- b. Shape and size of dormer (show dimensions on drawings);
- c. Overhang;
- d. Size of window(s), with nominal size of sash (show dimensions on drawings)

9. Skylights

- a. Profile;
- b. Visibility from right-of-way;
- c. Material (plastic lens or glass);
- d. Shown in plan and elevation to scale



10. Façade

- a. Consistency in style;
- b. Materials and their combinations

brick size and color

stone type and color

fiber-cement (e.g., Hardie-plank) or wood siding

shake or shingle

other

- c. Height of foundation at corners;
- d. Ceiling heights comparable to area of influence: basement, first floor, second floor;
- e. Detailing: soldier course, brackets, fascia board; water table;
- f. Height from grade to roof ridge;
- g. Dimensions, proportions and placement of windows, doors

11. Entrance

- a. Height and width of door;
- b. Design of door (e.g., 6-panel, craftsman);
- c. Material of door;
- d. Overhang;
- e. Portico height;
- f. Size and height of columns or posts;
- g. Railing

12. Windows

- a. Consistent with original as well as the area of influence;
- b. Size and proportion similar to original;
- c. Pane orientation and size similar to original;
- d. Type (e.g., double hung, casement);
- e. Fenestration on walls visible from right-of-way;
- f. Simulated divided light (SDL) or true divided light (TDL): location of muntins between the glass, behind the glass or permanently affixed on exterior;
- g. Material of window and any cladding;
- h. Width of muntins compared to original (show dimensions on drawings);
- i. Shutters or canopies
- i. Dimensions of windows and doors.

13. Materials

- a. Show all materials and label them on drawings;
- b. Provide samples of brick or stone;
- c. Provide samples if new or unusual materials



14. Garages / Accessory Buildings

- a. Visibility from street;
- b. Placement on site;
- c. Scale, style appropriate for house;
- d. Show dimensions on drawings;
- e. Materials;
- f. Square footage appropriate for lot size;
- g. Garage door size and design
- h. Show height from grade to eaves and to top of roof

15. Demolitions

- a. Provide documentation from engineer concerning feasibility of rehabilitation;
- b. Provide photographs of structure to be demolished;
- c. Provide plan for proposed redevelopment

SITE NOTES:

- 1. TOTAL SITE AREA: 0.463 ACRES / 20,152 SF TOTAL DISTURBED AREA: 0.10 ACRES / 4,140 SF
- 2. SITE ADDRESS: 500 SOUTH WESTMINISTER WAY, DEKALB COUNTY, GA 30307
- 3. SURVEY INFORMATION TAKEN FROM SURVEYS PERFORMED BY GEORGIA LAND SURVEYING, CO. DATED 1-28-2019.
- 4. THIS SITE IS NOT LOCATED WITHIN A ZONE [A, AE, SHADED ZONE X] AS DEFINED BY F.I.R.M. COMMUNITY PANEL NUMBER 13089C066K DATED AUGUST 15, 2019 FOR INCORPORATED DEKALB COUNTY, GEORGIA.
- ASSUMES NO RESPONSIBILITY FOR THE LOCATIONS, SIZES, MATERIALS, OR DEPTH FOR THE UTILITIES SHOWN OR DISCREPANCIES TO THE ENGINEER OF RECORD. THE CONTRACTOR SHALL ALSO HAVE THE RESPONSIBILITY BEFORE STARTING ANY WORK TO MAKE SUCH EXPLORATIONS AND PROBES NECESSARY TO ASCERTAIN ANY SEWER LINES, WATER SUPPLY LINES, GAS LINES, ELECTRICAL LINES, CABLE LINES, TELEPHONE LINES, OR OTHER UTILITY LINE.
- ALL FUTURE CONSTRUCTION MUST CONFORM TO THE APPROPRIATE CITY, COUNTY, AND STATE STANDARDS.
- 7. CONTRACTOR SHALL CONTACT THE UTILITY LOCATOR AS REQUIRED BY GEORGIA LAW AND HAVE ALL UTILITIES MARKED PRIOR TO ANY CONSTRUCTION ACTIVITY. CONTRACTOR WILL HAVE PRIVATE UTILITY LOCATOR LOCATE ALL UTILITIES WITHIN THE CONSTRUCTION LIMITS NOT COVERED BY THE UTILITY PROTECTION CENTER.
- 8. THE CONTRACTOR SHALL IMMEDIATELY NOTIFY THE ENGINEER OF ANY DISCREPANCIES OR ERRORS THAT HE MAY DISCOVER IN THESE PLANS.
- 9. CONTRACTOR TO PROVIDE ALL NECESSARY BARRICADES, GUARDS, LIGHTS, AND OTHER INSTALLATIONS REQUIRED TO PROTECT PERSONS AND PROPERTY DURING THE ENTIRE CONSTRUCTION PROCESS.
- 11. UNDERGROUND UTILITIES SERVING OR CROSSING THE PREMISES MAY EXIST THAT ARE NOT SHOWN. CRESCENT VIEW ENGINEERING IS UNABLE TO CERTIFY TO THE ACCURACY OR COMPLETENESS OF THE UTILITY INFORMATION SHOWN. ALL UNDERGROUND UTILITY LOCATIONS MUST BE FIELD VERIFIED PRIOR TO ANY CONSTRUCTION ACTIVITY BY THE UTILITY PROTECTION CENTER AT 1-800-282-7411 FOR RIGHT OF WAY AREA AND BY A PRIVATE UTILITY LOCATOR FOR UTILITIES NOT LOCATED WITHIN THE RIGHT OF WAY.
- 12. THE CONTRACTOR MUST OBTAIN ADDITIONAL "RIGHT OF WAY" PERMIT FOR ALL NECESSARY WORK DONE IN THE RIGHT OF WAY.
- 13. ALL APPROPRIATE EASEMENTS, STATE WATER BUFFERS, STREAM BUFFERS, AND/OR FLOOD PLAIN BUFFERS THAT APPLY TO THIS PROPERTY ARE SHOWN ON THESE PLANS
- 14. TO THE BEST OF OUR KNOWLEDGE, THERE NO CEMETERIES, ARCHITECTURAL, OR ARCHEOLOGICAL LANDMARKS EXIST ON SITE. IN THE EVENT THAT THESE LANDMARKS ARE DISCOVERED DURING CONSTRUCTION, THE ENGINEER MUST BE CONTACTED IMMEDIATELY FOR REVIEW AND AMENDING THE CONSTRUCTION PLANS
- 15. THIS PLAN WAS PREPARED FOR PERMIT APPROVAL ONLY. ACTUAL CONSTRUCTION SHOULD BE BASED ON STAKING BY A REGISTERED LAND SURVEYOR. THE FOOTPRINT IS BASED ON AN ARCHITECTURAL PLAN BY OTHERS. THE ARCHITECTURAL PLAN SHOULD BE USED FOR HOUSE POSITIONING AND LOCATION.

DEKALB COUNTY NOTES:

- GRADE TO DRAIN AWAY FROM FOUNDATION
- 2. ALL GRADED SLOPES TO BE AT A 3:1 SLOPE OR GREATER.
- ALL LAND DISTURBANCE TO BE STABILIZED WITH VEGETATION UPON COMPLETION OF DEMOLITION. ALL TREES TO REMAIN AND HAVE PROPER PROTECTION UNLESS APPROVED PLANS INDICATE OTHERWISE. CALL FOR FINAL INSPECTION AT 404-371-4913.
- 4. ALL CONSTRUCTION MUST CONFORM TO DEKALB COUNTY STANDARDS.
- PRIOR TO COMMENCING LAND DISTURBING ACTIVITY, THE LIMITS OF DISTURBANCE SHALL BE CLEARLY AND ACCURATELY DEMARCATED WITH STAKES, RIBBONS OR OTHER APPROPRIATE MEANS, THE LOCATION AND EXTENT OF ALL AUTHORIZED LAND DISTURBING ACTIVITY SHALL BE DEMARCATED FOR THE DURATION OF THE CONSTRUCTION ACTIVITY.
- 6. ALL EROSION CONTROL MEASURES SHALL BE IN PLACE PRIOR TO COMMENCING CONSTRUCTION AND SHALL BE MAINTAINED IN PROPER WORKING ORDER UNTIL ALL DISTURBED AREAS ARE STABILIZED.
- 7. A COPY OF THE APPROVED LAND DISTURBANCE PLAN SHALL BE PRESENT ON SITE WHENEVER LAND DISTURBANCE ACTIVITY IS IN PROGRESS.
- 8. FINAL ON-SITE INSPECTION REQUIRED PRIOR TO RELEASE OF THE CERTIFICATE OF OCCUPANCY, CERTIFIED AS-BUILTS WILL ALSO BE REQUIRED.
- 9. EROSION AND SEDIMENTATION CONTROL MEASURES WILL BE MAINTAINED AT ALL TIMES. IF FULL IMPLEMENTATION OF THE APPROVED PLAN DOES NOT PROVIDE FOR EFFECTIVE EROSION AND SEDIMENT CONTROL, ADDITIONAL EROSION AND SEDIMENT CONTROL MEASURES SHALL BE IMPLEMENTED TO CONTROL OR TREAT THE SEDIMENT SOURCE.
- 10. ADDITIONAL EROSION CONTROLS SHALL BE INSTALLED AS DEEMED NECESSARY BY THE IN-SITE INSPECTOR.
- 11. ALL LOTS/SITES WITH 2' OF FILL OR GREATER WILL REQUIRE A COMPACTION CERTIFICATE BY A PROFESSIONAL REGISTERED ENGINEER PRIOR OR A BUILDING PERMIT AND OR PRIOR TO FOOTERS BEING POURED.
- 12. LOCATE AND FIELD STAKE ALL UTILITIES, EASEMENTS, PIPES, FLOOD LIMITS, STREAM BUFFERS, AND TREE SAVE AREAS PRIOR TO ANY LAND DISTURBING ACTIVITIES.
- 13. ALL TREE PROTECTION AREAS TO BE PROTECTED FROM SEDIMENTATION.
- 14. ALL TREE PROTECTION DEVICES TO BE INSTALLED PRIOR TO LAND DISTURBANCE AND MAINTAINED UNTIL FINAL LANDSCAPING.
- 15. ALL TREE PROTECTION FENCING TO BE INSPECTED DAILY AND REPAIRED OR REPLACED AS NEEDED
- 16. A FINAL AS-BUILT LOT SURVEY REQUIRED PRIOR TO ISSUANCE OF CERTIFICATE OF OCCUPANCY.
- 17. A FINAL AS-BUILT WATER QUALITY CERTIFICATE REQUIRED PRIOR TO CERTIFICATE OF OCCUPANCY.
- 18. WATER QUALITY BMP(s) TO BE INSTALLED AT THE TIME OF FINAL LANDSCAPING.
- 19. ALL COLLECTED WATER SHALL BE DIRECTED TO THE WATER QUALITY BMP(s).
- 20. WORK HOURS AND CONSTRUCTION DELIVERIES ARE: MONDAY-FRIDAY 7: 00am-7: 00pm SATURDAY 8: 00am-5: 00pm

STATEWATER STATEMENT:

THIS PROPERTY IS NOT LOCATED INSIDE DESIGNATED F.I.A SPECIAL FLOOD HAZARD AREA AS PER THE FLOOD INSURANCE RATE MAP #13089C0066K, DATED AUGUST 15, 2019.


THERE ARE WATERS OF THE STATE OF GEORGIA LOCATED ON OR WITHIN 200 FEET OF THE SITE. ALL APPROPRIATE STATE WATER BUFFERS ARE SHOWN ON THE SITE PLANS.

24 HOUR EMERGENCY CONTACT: NIC BRANKER 919-285-1287


SINGLE FAMILY HOUSE ADDITION CONSTRUCTION DOCUMENTS FOR

500 SOUTH WESTMINISTER WAY

LAND LOT 51, DISTRICT 18 DEKALB COUNTY, GEORGIA

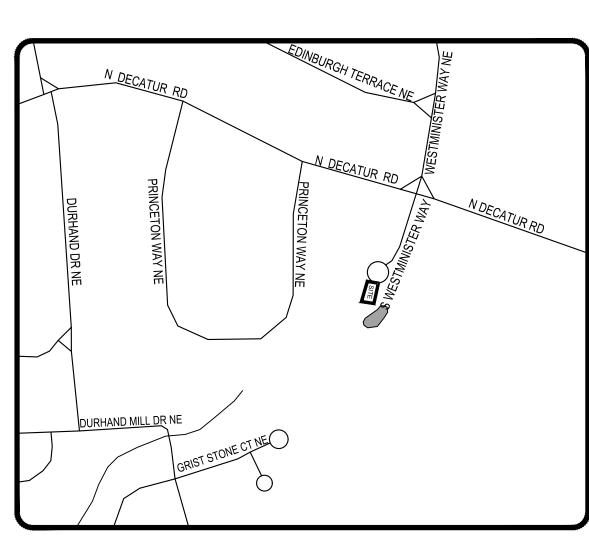

Location Map

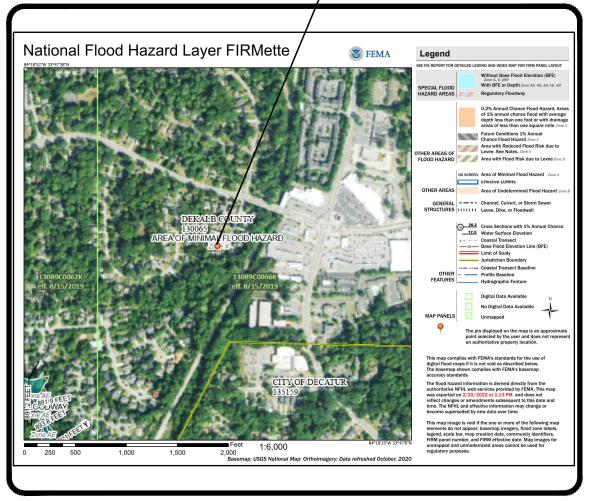

FEMA Map

ADDRESSING:

NIC BRANKER

500 SOUTH WESTMINSTER WAY

500 SOUTH WESTMINISTER WAY,

DEKALB COUNTY, GEORGIA 30312

DEKALB COUNTY, GEORGIA 30307

OWNER INFORMATION:

THIS SITE IS NOT LOCATED WITHIN A ZONE [A, AE, SHADED ZONE X] AS DEFINED BY F.I.R.M. COMMUNITY PANEL NUMBER 13089C0066K DATED AUGUST 15, 2019 FOR INCORPORATED DEKALB COUNTY, GEORGIA.

ZONING CONFORMANCE:

SITE ZONING: R-75 (RESIDENTIAL MEDIUM LOT-75) DISTRICT MINIMUM LOT SIZE: 10,000 SF

LOT WIDTH: 75 FEET, MIN AT STREET 75 FEET, MIN AT BUILDING LINE

35 FEET, MIN FOR CULDESAC

FRONT SETBACK: 45 FEET MIN (THOROUGHFARES)

35 FEET MIN (ARTERIALS) 30 FEET MIN (COLLECTOR AND ALL OTHERS)

25 FEET MIN (ALLEY ACCESS)

SIDE SETBACK: 7.5 FEET REAR SETBACK: 40 FEET

LOT COVERAGE: SHALL NOT EXCEED 35% FLOOR AREA: NO LESS THAN 1600 SQ FEET OFF-STREET PARKING: 2 SPACES

BUILDING HEIGHT: NO MORE THAN 35 FEET

GEORGIA SOIL AND WATER

CONSERVATION COMMISSION

0000045830

EXPIRES: 11/10/2025

EXPIRATION 11-10-25

OPEN SPACE: 20%

GEORGE H BALTZ III

CERTIFICATION NUMBER:

ISSUED: 09/25/2007

THE PROPOSED PLANS CALL FOR AN ADDITION OF A TWO STOREY GARAGE WITH A DECK AND A SWIMMING

CONSTRUCTION NARRATIVE:

POOL. CONFORMING TO R-75 ZONING. ALL PHASED EROSION CONTROL BMPS ARE TO REMAIN IN PLACE UNTIL THE SITE IS 100% STABILIZED.

"I CERTIFY UNDER THE PENALTY OF LAW THAT THIS PLAN WAS PREPARED AFTER A SITE VISIT TO THE LOCATIONS DESCRIBED HEREIN BY MYSELF OR MY AUTHORIZED AGENT. UNDER MY DIRECT SUPERVISION"



03-15-23 DATE

DEKALB COUNTY TREE NOTES:

- NO ONE SHALL ENCROACH, PLACE SOLVEMENTS, BUILDING, MACHINERY, BUILDING DEBRIS OR ANY OTHER MATERIAL WITHIN 6' OUTSIDE THEE PERIPHERY OF THE CRZ OR WITHIN ANY TREE SAVE AREA, TRANSITIONAL BUFFER ZONE, STREAM BUFFER, OR STATE BUFFER ZONE.
- 2. ALL TREE FENCE AND OTHER TREE PROTECTION DEVICES MUST REMAIN IN
- 3. A TREE THAT IS DESIGNATED TO BE SAVED, BUT IS DAMAGED DURING CONSTRUCTION, SHALL BE REPLACED WITH 4" CALIPER TREES EQUAL TO THE UNIT VALUE OF THE TREE REMOVED. ANY SPECIMEN TREE DAMAGED SHALL BE REPLACED WITH 4" CALIPER TREES EQUAL TO 1.5 TIMES THE DBH OF THE
- ALL PROTECTION AREAS TO BE PROTECTED FROM SEDIMENTATION.
- 5. ALL TREE PROTECTION DEVICES, INCLUDING CRITICAL ROOTZONE(CRZ) PROTECTION, TO BE INSTALLED PRIOR TO THE START OF THE LAND DISTURBANCE, AND MAINTAINED UNTIL FINAL LANDSCAPING.
- 6. ALL TREE PROTECTION FENCING TO BE INSPECTED DAILY, AND REPAIRED OR REPLACED AS NEEDED.
- NO PARKING, STORAGE OR OTHER CONSTRUCTION ACTIVITIES ARE TO OCCUR WITHIN TREE PROTECTION AREAS(CRZ).
- ALL REQUIRED VEGETATION MUST BE MAINTAINED FOR TWO GROWING SEASONS AFTER THE DATE OF FINAL INSPECTION.
- TREE PROTECTION SIGNS ARE TO BE PLACED AT LEAST EVERY 50' ALONG THE LENGTH OF THE TREE PROTECTION FENCE. THE SIGNS SHOULD BE IN LANGUAGE SO THAT ALL WORKERS ON SITE ARE ABLE TO UNDERSTAND.

PRE-CONSTRUCTION IMPERVIOUS AREA:

PRE-CONSTRUCTION LOT COVERAGE	
AREA	SF
EXISTING HOUSE	2561
EXISTING DECKS	318
EXISTING CONCRETE DRIVEWAY	2276
EXISTING CONCRETE SIDEWALK	50
EXISTING FRONT PORCH	13
STAIRS	63
TOTAL PRE CONSTRUCTION IMPERVIOUS AREA	5281
LOT COVERAGE %	26.21%


POST-CONSTRUCTION IMPERVIOUS AREA:

SITE LOCATION	SF
EXISTING HOUSE	2561
EXISTING DECKS	317
REMAINING CONCRETE DRIVEWAY	2106
EXISTING CONCRETE SIDEWALK	50
EXISTING FRONT PORCH	13
EXISTING STAIRS	63
PROPOSED GARAGE	560
PROPOSED DRIVEWAY ADDITION	190
PROPOSED POOL	618
PROPOSED DECK	260
PROPOSED POOL WALKWAY	136
PROPOSED WALL	57
PROPOSED POOL EQUIPMENT	15
PROPOSED TURF DECK WALKWAY	0
TOTAL PROPOSED IMPERVIOUS AREA	1836
TOTAL POST CONSTRUCTION IMPERVIOUS AREA	6946
LOT COVERAGE %	34.47%


LEGEND

COVER SURVEY **DEMOLITION PLAN** SITE PLAN STORMWATER PLAN **ES&PC PLAN C-3** TREE PLAN CONSTRUCTION DETAILS

SHEET #

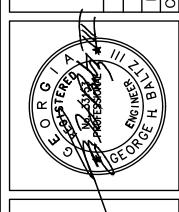

CVE PI # 22-139

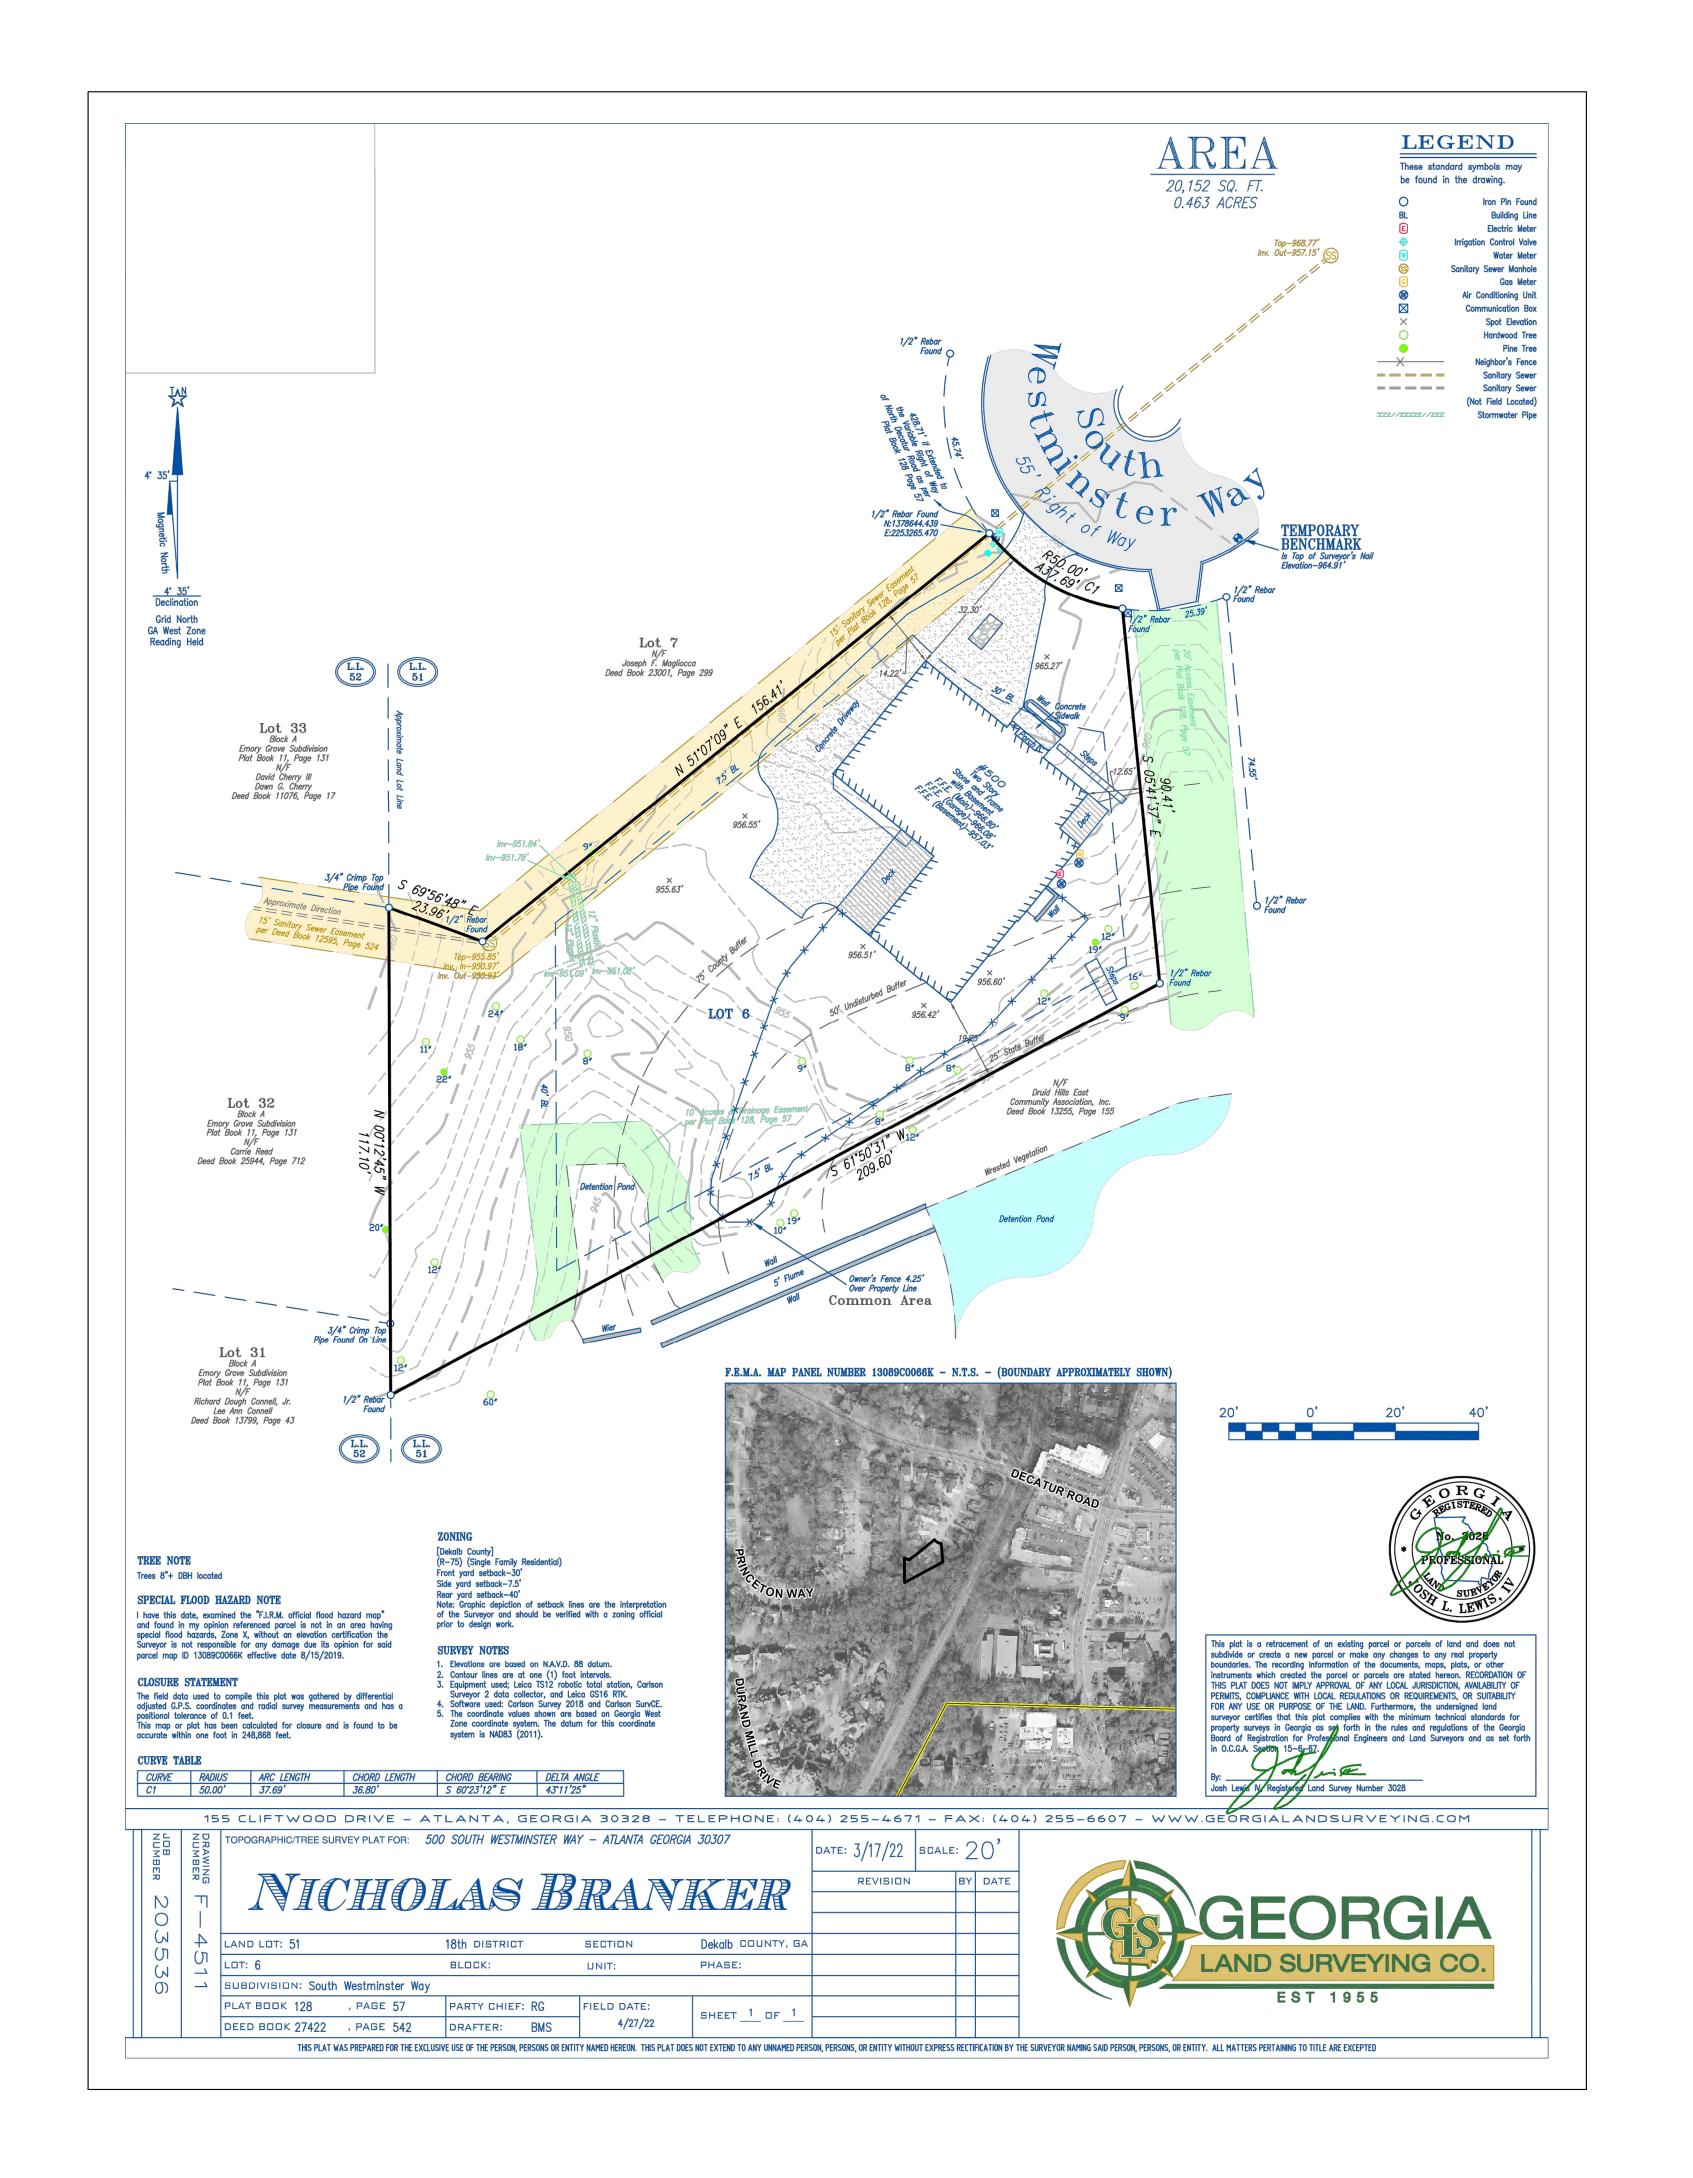

DEKALB COUNTY NOTES:

- 1. GRADE TO DRAIN AWAY FROM FOUNDATION.
- 2. ALL GRADED SLOPES TO BE AT A 3:1 SLOPE OR GREATER.
- 3. ALL LAND DISTURBANCE TO BE STABILIZED WITH VEGETATION UPON COMPLETION OF DEMOLITION. ALL TREES TO REMAIN AND HAVE PROPER PROTECTION UNLESS APPROVED PLANS INDICATE OTHERWISE. CALL FOR FINAL INSPECTION AT
- 404-371-4913.
 4. ALL CONSTRUCTION MUST CONFORM TO DEKALB COUNTY STANDARDS.
- 5. PRIOR TO COMMENCING LAND DISTURBING ACTIVITY, THE LIMITS OF DISTURBANCE SHALL BE CLEARLY AND ACCURATELY DEMARCATED WITH STAKES, RIBBONS OR OTHER APPROPRIATE MEANS, THE LOCATION AND EXTENT OF ALL AUTHORIZED LAND DISTURBING ACTIVITY SHALL BE DEMARCATED FOR THE DURATION OF THE CONSTRUCTION ACTIVITY.
- 6. ALL EROSION CONTROL MEASURES SHALL BE IN PLACE PRIOR TO COMMENCING CONSTRUCTION AND SHALL BE MAINTAINED IN PROPER WORKING ORDER UNTIL ALL DISTURBED AREAS ARE STABILIZED.
- 7. A COPY OF THE APPROVED LAND DISTURBANCE PLAN SHALL BE PRESENT ON SITE WHENEVER LAND DISTURBANCE ACTIVITY IS IN PROGRESS.
- 8. FINAL ON—SITE INSPECTION REQUIRED PRIOR TO RELEASE OF THE CERTIFICATE OF OCCUPANCY, CERTIFIED AS—BUILTS WILL ALSO BE REQUIRED.
- 9. EROSION AND SEDIMENTATION CONTROL MEASURES WILL BE MAINTAINED AT ALL TIMES. IF FULL IMPLEMENTATION OF THE APPROVED PLAN DOES NOT PROVIDE FOR EFFECTIVE EROSION AND SEDIMENT CONTROL, ADDITIONAL EROSION AND SEDIMENT CONTROL MEASURES SHALL BE IMPLEMENTED TO CONTROL OR TREAT THE SEDIMENT SOURCE.
- 10. ADDITIONAL EROSION CONTROLS SHALL BE INSTALLED AS DEEMED NECESSARY BY THE IN-SITE INSPECTOR.
- 11. ALL LOTS/SITES WITH 2' OF FILL OR GREATER WILL REQUIRE A COMPACTION CERTIFICATE BY A PROFESSIONAL REGISTERED ENGINEER PRIOR OR A BUILDING PERMIT AND OR PRIOR TO FOOTERS BEING POURED.
- 12. LOCATE AND FIELD STAKE ALL UTILITIES, EASEMENTS, PIPES, FLOOD LIMITS, STREAM BUFFERS, AND TREE SAVE AREAS PRIOR TO ANY LAND DISTURBING ACTIVITIES.

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- 15. ALL TREE PROTECTION FENCING TO BE INSPECTED DAILY AND REPAIRED OR REPLACED AS NEEDED.
- 16. A FINAL AS—BUILT LOT SURVEY REQUIRED PRIOR TO ISSUANCE OF CERTIFICATE OF OCCUPANCY.

 17. A FINAL AS—BUILT WATER QUALITY CERTIFICATE REQUIRED PRIOR TO CERTIFICATE
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 19. ALL COLLECTED WATER SHALL BE DIRECTED TO THE WATER QUALITY BMP(s).
 20. WORK HOURS AND CONSTRUCTION DELIVERIES ARE:
- MONDAY-FRIDAY 7: 00am-7: 00pm SATURDAY 8: 00am-5: 00pm
- 21.ALL DEMOLITION DEBRIS TO BE HAULED OFF SITE
 22.DUMPSTERS AND/OR TEMPORARY SANITARY FACILITIES SHALL NOT BE LOCATED IN
 STREET, TREE PROTECTION AREA, OR RIGHT OF WAY.

GENERAL DEMOLITION NOTES:


- BE ADVISED THIS IS NOT AN EXHAUSTIVE LIST OF DEMOLITION ITEMS.
 CONTRACTOR SHALL BECOME FAMILIAR WITH THE SITE AND THE COMPLETE DESIGN INTENT OF THE CONSTRUCTION DOCUMENTS. ANY QUESTIONS, CONCERNS, OR IDEAS CONCERNING THE INTENT OR EXECUTION OF THE DESIGN DOCUMENTS MUST BE BROUGHT TO THE OWNER BEFORE PERFORMING ANY CONSTRUCTION ACTIVITY.
- 1) REMOVE PORTION OF EXISTING CONCRETE DRIVEWAY
- 2 LOCATE AND PROTECT ALL EXISTING UTILITIES

PRE-CONSTRUCTION IMPERVIOUS AREA:

AREA	SF
EXISTING HOUSE	2561
EXISTING DECKS	318
EXISTING CONCRETE DRIVEWAY	2276
EXISTING CONCRETE SIDEWALK	50
EXISTING FRONT PORCH	13
STAIRS	63
TOTAL PRE CONSTRUCTION IMPERVIOUS AREA	5281
LOT COVERAGE %	26.21%



NO TREES ARE TO BE REMOVED DURING DEMOLITION

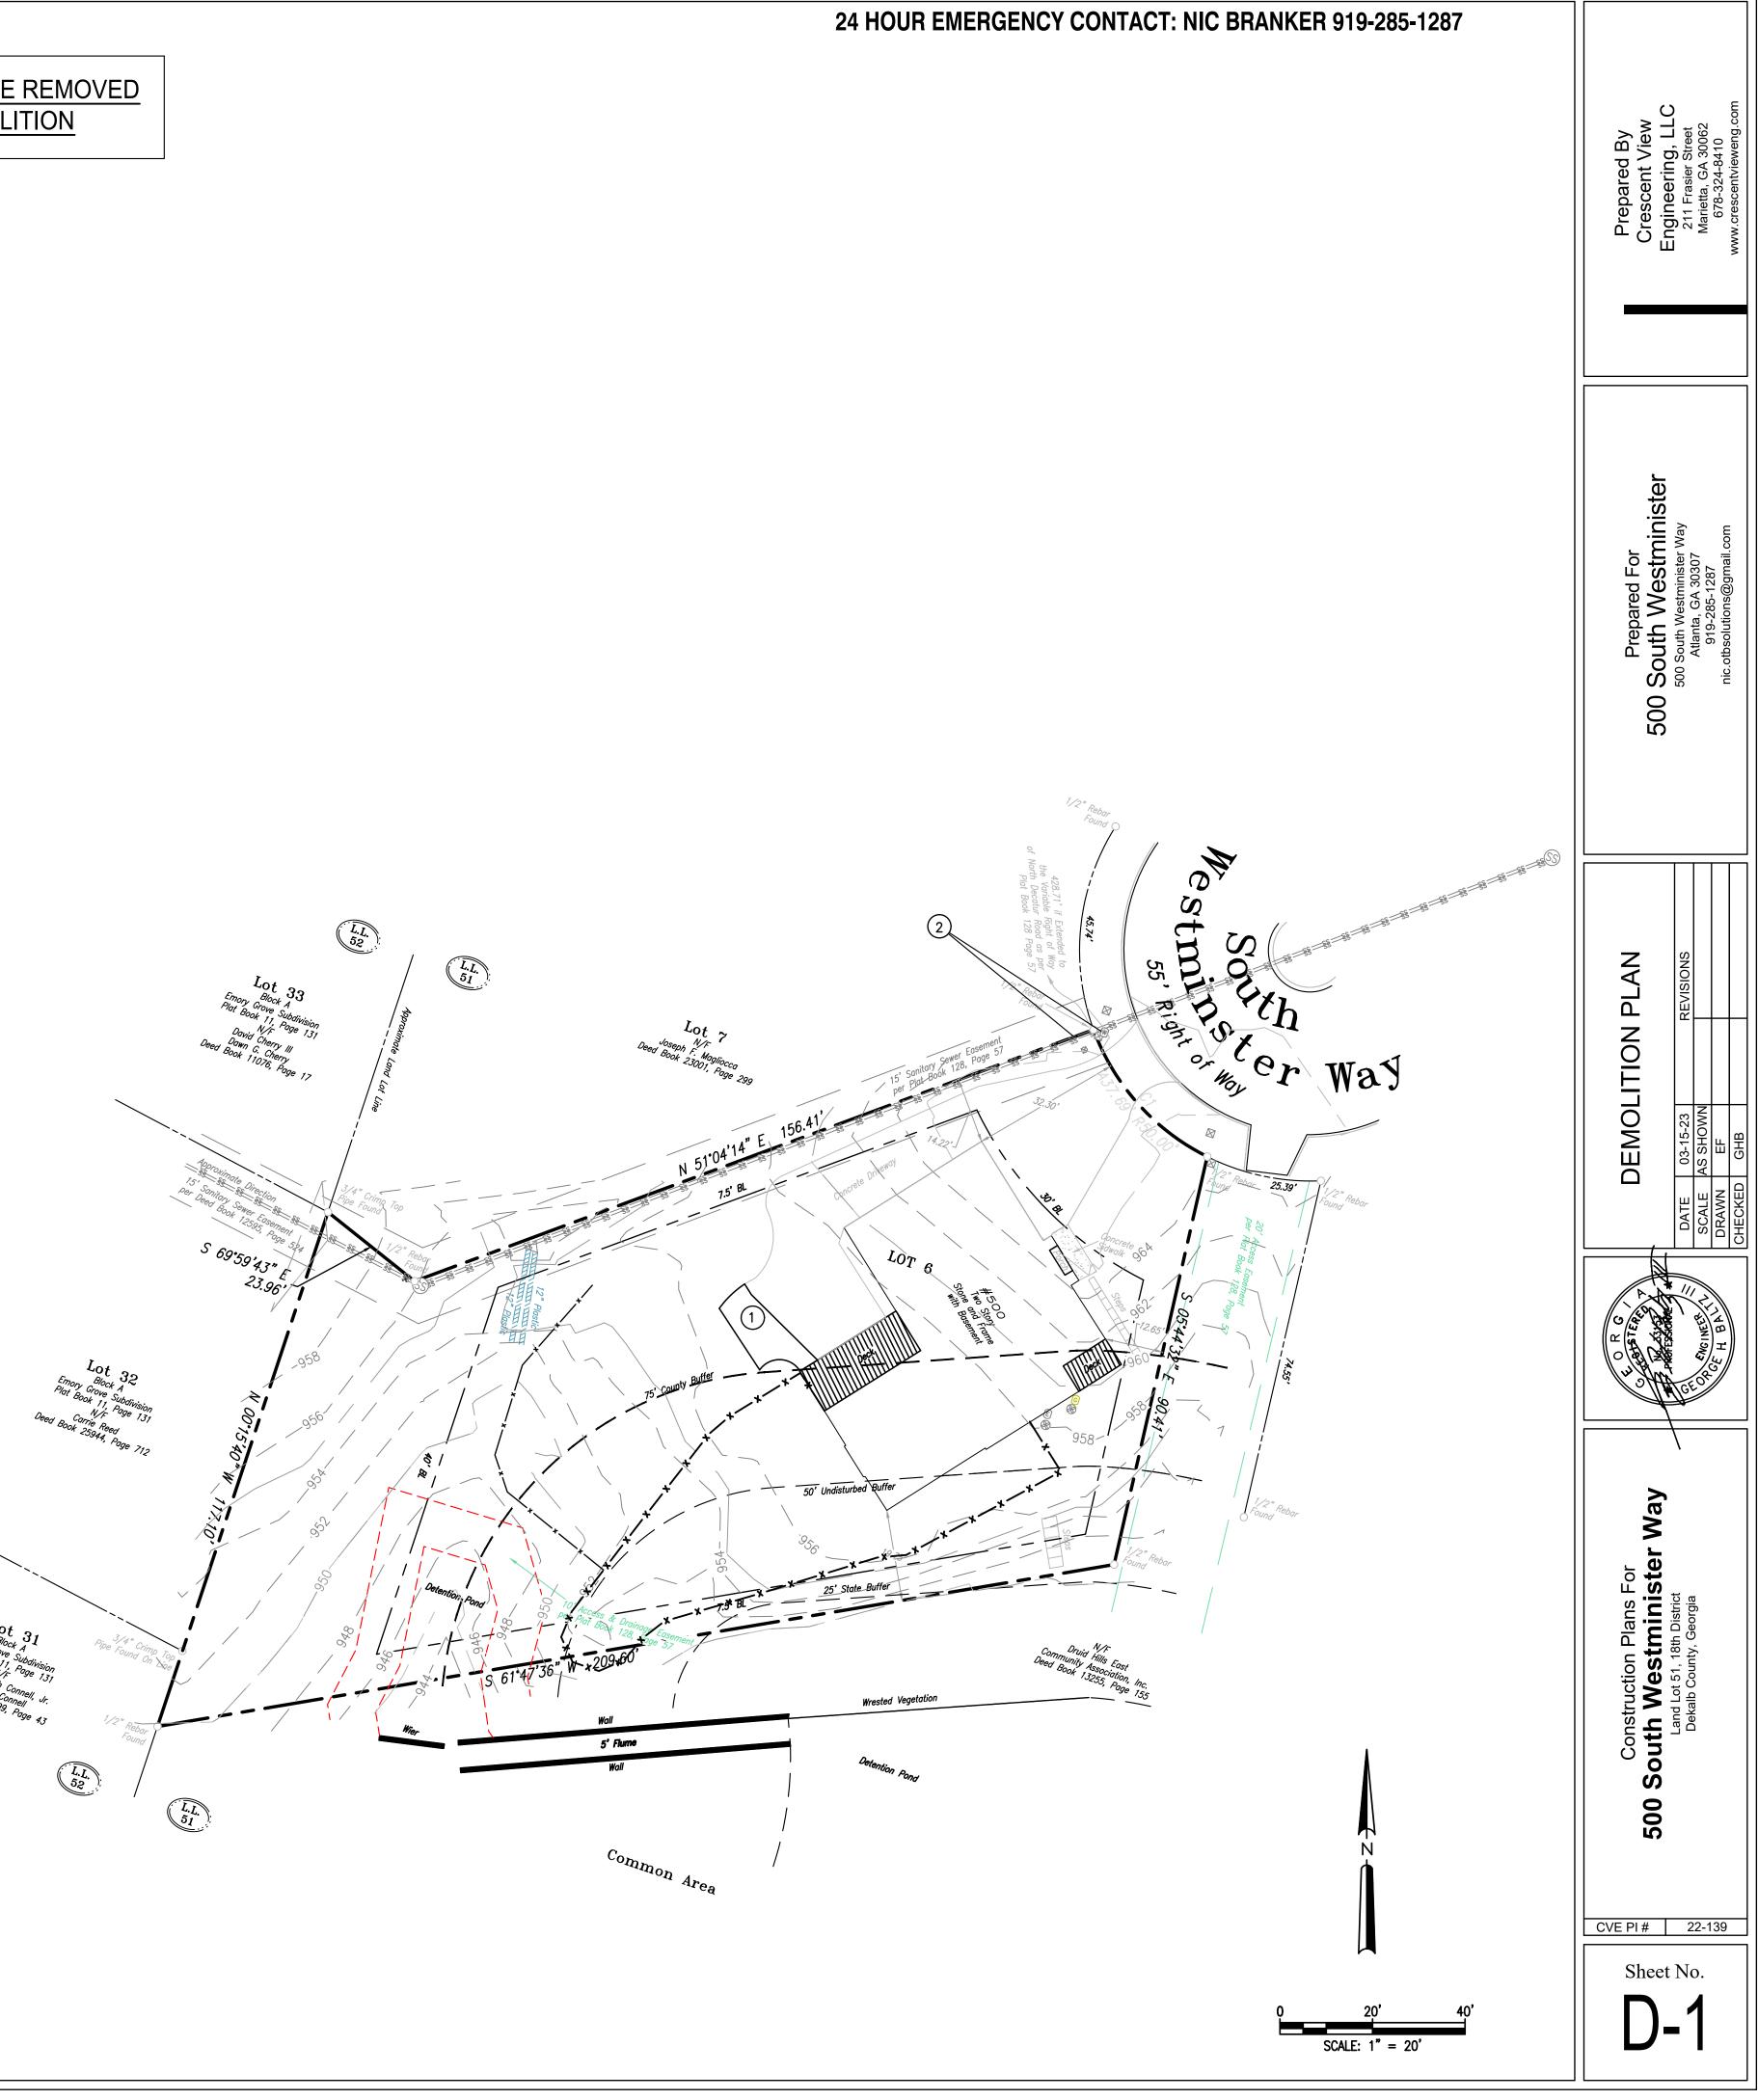

SITE NOTES:

- TOTAL SITE AREA: 0.463 ACRES / 20,152 SF TOTAL DISTURBED AREA: 0.10 ACRES / 4,140 SF
- 2. SITE ADDRESS: 500 SOUTH WESTMINISTER WAY, DEKALB COUNTY, GA 30307
- SURVEY INFORMATION TAKEN FROM SURVEYS PERFORMED BY GEORGIA LAND SURVEYING, CO, DATED 1-28-19.
- 4. THIS SITE IS LOCATED WITHIN A ZONE [A, AE, SHADED ZONE X] AS DEFINED BY F.I.R.M. COMMUNITY PANEL NUMBER 13089C0066K DATED AUGUST 15, 2019 FOR INCORPORATED
- THE EXISTING UTILITIES SHOWN ON THE PLANS ARE SHOWN FOR THE OWNERS CONVENIENCE. THE ENGINEER ASSUMES NO RESPONSIBILITY FOR THE LOCATIONS, SIZES, MATERIALS, OR DEPTH FOR THE UTILITIES SHOWN OR THE UTILITIES WHICH MAY EXIST ON THE SITE BUT ARE NOT SHOWN. THE CONTRACTOR SHALL HAVE THE RESPONSIBILITY TO VERIFY THE LOCATION OF ALL UTILITIES SHOWN ON THE PLANS AND REPORT ANY DISCREPANCIES TO THE ENGINEER OF RECORD, THE CONTRACTOR SHALL ALSO HAVE THE RESPONSIBILITY BEFORE STARTING ANY WORK TO MAKE SUCH EXPLORATIONS AND PROBES NECESSARY TO ASCERTAIN ANY SEWER LINES, WATER SUPPLY LINES, GAS LINES, ELECTRICAL LINES, CABLE LINES, TELEPHONE LINES, OR OTHER UTILITY LINE.
- 6. ALL FUTURE CONSTRUCTION MUST CONFORM TO THE APPROPRIATE CITY, COUNTY, AND STATE STANDARDS.
- CONTRACTOR SHALL CONTACT THE UTILITY LOCATOR AS REQUIRED BY GEORGIA LAW AND HAVE ALL UTILITIES MARKED PRIOR TO ANY CONSTRUCTION ACTIVITY. CONTRACTOR WILL HAVE PRIVATE UTILITY LOCATOR LOCATE ALL UTILITIES WITHIN THE CONSTRUCTION LIMITS NOT COVERED BY THE UTILITY PROTECTION CENTER.
- 3. THE CONTRACTOR SHALL IMMEDIATELY NOTIFY THE ENGINEER OF ANY DISCREPANCIES OR ERRORS THAT HE MAY DISCOVER IN THESE PLANS.
- O. CONTRACTOR TO PROVIDE ALL NECESSARY BARRICADES, GUARDS, LIGHTS, AND OTHER INSTALLATIONS REQUIRED TO PROTECT PERSONS AND PROPERTY DURING THE ENTIRE CONSTRUCTION PROCESS.
- 10. ALL CONSTRUCTION MUST CONFORM TO THE APPROPRIATE DEKALB COUNTY AND STATE OF GEORGIA STANDARDS.
- 11. UNDERGROUND UTILITIES SERVING OR CROSSING THE PREMISES MAY EXIST THAT ARE NOT SHOWN. CRESCENT VIEW ENGINEERING IS UNABLE TO CERTIFY TO THE ACCURACY OR COMPLETENESS OF THE UTILITY INFORMATION SHOWN. ALL UNDERGROUND UTILITY LOCATIONS MUST BE FIELD VERIFIED PRIOR TO ANY CONSTRUCTION ACTIVITY BY THE UTILITY PROTECTION CENTER AT 1-800-282-7411 FOR RIGHT OF WAY AREA AND BY A PRIVATE UTILITY LOCATOR FOR UTILITIES NOT LOCATED WITHIN THE RIGHT OF WAY.
- 12. THE CONTRACTOR MUST OBTAIN ADDITIONAL "RIGHT OF WAY" PERMIT FOR ALL NECESSARY WORK DONE IN THE RIGHT OF WAY.
- 13. ALL APPROPRIATE EASEMENTS, STATE WATER BUFFERS, STREAM BUFFERS, AND/OR FLOOD PLAIN BUFFERS THAT APPLY TO THIS PROPERTY ARE SHOWN ON THESE PLANS
- 14. TO THE BEST OF OUR KNOWLEDGE, THERE NO CEMETERIES, ARCHITECTURAL, OR ARCHEOLOGICAL LANDMARKS EXIST ON SITE. IN THE EVENT THAT THESE LANDMARKS ARE DISCOVERED DURING CONSTRUCTION, THE ENGINEER MUST BE CONTACTED IMMEDIATELY FOR REVIEW AND AMENDING THE CONSTRUCTION PLANS
- 15. THIS PLAN WAS PREPARED FOR PERMIT APPROVAL ONLY. ACTUAL CONSTRUCTION SHOULD BE BASED ON STAKING BY A REGISTERED LAND SURVEYOR. THE FOOTPRINT IS BASED ON AN ARCHITECTURAL PLAN BY OTHERS. THE ARCHITECTURAL PLAN SHOULD BE USED FOR HOUSE POSITIONING AND LOCATION.

DEKALB COUNTY NOTES:

- 1. GRADE TO DRAIN AWAY FROM FOUNDATION.
- 2. ALL GRADED SLOPES TO BE AT A 3:1 SLOPE OR GREATER.
- 3. ALL LAND DISTURBANCE TO BE STABILIZED WITH VEGETATION UPON COMPLETION OF DEMOLITION. ALL TREES TO REMAIN AND HAVE PROPER PROTECTION UNLESS APPROVED PLANS INDICATE OTHERWISE. CALL FOR FINAL INSPECTION AT 404-371-4913.
- 4. ALL CONSTRUCTION MUST CONFORM TO DEKALB COUNTY STANDARDS.
- 5. PRIOR TO COMMENCING LAND DISTURBING ACTIVITY, THE LIMITS OF DISTURBANCE SHALL BE CLEARLY AND ACCURATELY DEMARCATED WITH STAKES, RIBBONS OR OTHER APPROPRIATE MEANS, THE LOCATION AND EXTENT OF ALL AUTHORIZED LAND DISTURBING ACTIVITY SHALL BE DEMARCATED FOR THE DURATION OF THE CONSTRUCTION ACTIVITY.
- 6. ALL EROSION CONTROL MEASURES SHALL BE IN PLACE PRIOR TO COMMENCING CONSTRUCTION AND SHALL BE MAINTAINED IN PROPER WORKING ORDER UNTIL ALL DISTURBED AREAS ARE
- 7. A COPY OF THE APPROVED LAND DISTURBANCE PLAN SHALL BE PRESENT ON SITE WHENEVER LAND DISTURBANCE ACTIVITY IS IN PROGRESS.
- 8. FINAL ON-SITE INSPECTION REQUIRED PRIOR TO RELEASE OF THE CERTIFICATE OF OCCUPANCY, CERTIFIED AS-BUILTS WILL ALSO BE REQUIRED.
- 9. EROSION AND SEDIMENTATION CONTROL MEASURES WILL BE MAINTAINED AT ALL TIMES. IF FULL IMPLEMENTATION OF THE APPROVED PLAN DOES NOT PROVIDE FOR EFFECTIVE EROSION AND SEDIMENT CONTROL, ADDITIONAL EROSION AND SEDIMENT CONTROL MEASURES SHALL BE IMPLEMENTED TO CONTROL OR TREAT THE SEDIMENT SOURCE.
- 10. ADDITIONAL EROSION CONTROLS SHALL BE INSTALLED AS DEEMED NECESSARY BY THE IN-SITE
- 11. ALL LOTS/SITES WITH 2' OF FILL OR GREATER WILL REQUIRE A COMPACTION CERTIFICATE BY A PROFESSIONAL REGISTERED ENGINEER PRIOR OR A BUILDING PERMIT AND OR PRIOR TO FOOTERS BEING POURED.
- 12. LOCATE AND FIELD STAKE ALL UTILITIES, EASEMENTS, PIPES, FLOOD LIMITS, STREAM BUFFERS, AND TREE SAVE AREAS PRIOR TO ANY LAND DISTURBING ACTIVITIES.
- 13. ALL TREE PROTECTION AREAS TO BE PROTECTED FROM SEDIMENTATION.
- 14. ALL TREE PROTECTION DEVICES TO BE INSTALLED PRIOR TO LAND DISTURBANCE AND MAINTAINED UNTIL FINAL LANDSCAPING.
- 15. ALL TREE PROTECTION FENCING TO BE INSPECTED DAILY AND REPAIRED OR REPLACED AS
- 16. A FINAL AS-BUILT LOT SURVEY REQUIRED PRIOR TO ISSUANCE OF CERTIFICATE OF
- 17. A FINAL AS-BUILT WATER QUALITY CERTIFICATE REQUIRED PRIOR TO CERTIFICATE OF OCCUPANCY.
- 18. WATER QUALITY BMP(s) TO BE INSTALLED AT THE TIME OF FINAL LANDSCAPING.
- 19. ALL COLLECTED WATER SHALL BE DIRECTED TO THE WATER QUALITY BMP(s).
- 20. WORK HOURS AND CONSTRUCTION DELIVERIES ARE: MONDAY-FRIDAY 7: 00am-7: 00pm SATURDAY 8: 00am-5: 00pm

POST-CONSTRUCTION IMPERVIOUS AREA:

POST-CONSTRUCTION LOT COVERAGE	
SITE LOCATION	SF
EXISTING HOUSE	2561
EXISTING DECKS	317
REMAINING CONCRETE DRIVEWAY	2106
EXISTING CONCRETE SIDEWALK	50
EXISTING FRONT PORCH	13
EXISTING STAIRS	63
PROPOSED GARAGE	560
PROPOSED DRIVEWAY ADDITION	190
PROPOSED POOL	618
PROPOSED DECK	260
PROPOSED POOL WALKWAY	136
PROPOSED WALL	57
PROPOSED POOL EQUIPMENT	15
PROPOSED TURF DECK WALKWAY	0
TOTAL PROPOSED IMPERVIOUS AREA	1836
TOTAL POST CONSTRUCTION IMPERVIOUS AREA	6946
LOT COVERAGE %	34.47%

STREAM BUFFER CALCULATIONS:

FENCE

,	Stream Buffer Encroachme	nt Chart	
uffer / Impervious Setback	Pre Construction (SF)	Post Construction (SF)	Difference (SF)
tate Buffer: 0'-25'	0	0	0
Indisturbed Buffer : 25'-50'	86	86	0
ounty Buffer: 50'-75'	1144	1728	584

24 HOUR EMERGENCY CONTACT: NIC BRANKER 919-285-1287



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CVE PI # 22-139 Sheet No.

SCALE: 1" = 20'

EXISTING SANITARY SEWER EASEMENT 957.75 PROPOSED FENCE TO POOL SERVE AS POOL **EQUIPMENT** C-5 ENCLOSURE EXISTING DRIVEWAY TW: 956.50 BW: 956.00 TW: 956.50 BW: 952.50 LIMITS OF DISTURBANCE TW: 956.50 BW: 950.50 EXISTING HOUSE - EXISTING FENCE FOR BOX TO REMAIN - EXISTING STAIRS Wrested Vegeta - PROPOSED TURF POOL DECK L.L. ELEV = 957.00- EXISTING DECK TW: 956.50 TO REMAIN BW: 952.00 PROPOSED FENCE TO CONNECT TO EXISTING

EXISTING WATER METER TO BE -

USED FOR NEW CONSTRUCTION

FOUND IN THE FIELD AND

ZONING CONFORMANCE:

SITE ZONING: R-75 (RESIDENTIAL MEDIUM LOT-75) DISTRICT MINIMUM LOT SIZE: 10,000 SF

LOT WIDTH: 75 FEET, MIN AT STREET 75 FEET, MIN AT BUILDING LINE 35 FEET, MIN FOR CULDESAC FRONT SETBACK: 45 FEET MIN (THOROUGHFARES)

35 FEET MIN (ARTERIALS) 30 FEET MIN (COLLECTOR AND ALL OTHERS)

25 FEET MIN (ALLEY ACCESS) SIDE SETBACK: 7.5 FEET

REAR SETBACK: 40 FEET

OPEN SPACE: 20%

LOT COVERAGE: SHALL NOT EXCEED 35% FLOOR AREA: NO LESS THAN 1600 SQ FEET

OFF-STREET PARKING: 2 SPACES BUILDING HEIGHT: NO MORE THAN 35 FEET

STATEWATER STATEMENT:

THIS PROPERTY IS NOT LOCATED INSIDE DESIGNATED F.I.A SPECIAL FLOOD HAZARD AREA AS PER THE FLOOD INSURANCE RATE MAP #13089C0066K, DATED AUGUST 15, 2019.

THERE ARE WATERS OF THE STATE OF GEORGIA LOCATED ON OR WITHIN 200 FEET OF THE SITE. ALL APPROPRIATE STATE WATER BUFFERS ARE SHOWN ON THE SITE PLANS.

WATER QUALITY NOTES:

THE TRENCH IS NORMALLY COVERED WITH TOPSOIL AND MANAGED TURF OR OTHER HERBACEOUS VEGETATION. AS AN ALTERNATIVE, THE AREA ABOVE THE SURFACE OF A TRENCH MAY BE COVERED WITH PEA GRAVEL (OR LARGER DEPENDING ON THE INFLOW RATES) TO ALLOW FOR INCIDENTAL LATERAL INFLOW ALONG THE EDGE OF GROUND LEVEL IMPERVIOUS SURFACES. THE DOWNSTREAM END OF THE PIPE MUST BE STABILIZED AND CAN BE LANDSCAPED FOR AESTHETICS.

<u>MAINTENANCE</u>

- INSPECT GUTTERS AND DOWNSPOUTS REMOVING ACCUMULATED LEAVES AND DEBRIS, CLEANING LEAF REMOVAL
- IF APPLICABLE, INSPECT PRETREATMENT DEVICES FOR SEDIMENT ACCUMULATION.
- INSPECT THE TRENCH FOLLOWING A LARGE RAINFALL EVENT TO INSURE OVERFLOW IS OPERATING AND FLOW IS NOT CAUSING PROBLEMS.

CONSTRUCTION STEPS

- REVIEW POTENTIAL TRENCH AREAS AND LAYOUT. THE TRENCH SHOULD SLOPE BETWEEN 0.5% AND 6% AWAY FROM THE STRUCTURE AND SHOULD NOT BE LOCATED: (1.) BENEATH AN IMPERVIOUS (PAVED) SURFACE; (2.) ABOVE AN AREA WITH A WATER TABLE OR BEDROCK LESS THAN TWO FEET BELOW THE TRENCH BOTTOM; (3.) OVER OTHER UTILITY LINES; OR (4.) ABOVE A SEPTIC FIELD. INSURE OUTLET DAYLIGHTS AT LEAST TEN FEET FROM PROPERTY LINE.
- IF SOIL IS A CONCERN PERFORM INFILTRATION TEST. IF THE RATE IS LESS THAN 0.25 IN/HR THIS METHOD CANNOT BE USED. IF THE RATE IS MORE THAN 0.50 IN/HR THE LENGTH OF THE DITCH MAY BE DECREASED 10% FOR EVERY 0.50 IN/HR INFILTRATION RATE INCREASE ABOVE 0.50 IN/HR
- MEASURE ELEVATIONS AND LAY OUT THE TRENCH TO THE REQUIRED DIMENSIONS MARKING THE ROUTE AND REQUIRED EXCAVATION DEPTHS. OFTEN A LEVEL LINE (TORPEDO LEVEL) IS USED.
- PLACE AND TAMP GRAVEL IN DITCH TO PLANNED DEPTH PLACING THE PIPE THREE INCHES DEEP IN THE UPPER PORTION OF THE GRAVEL, THEN PLACE AND GENTLY TAMP GRAVEL UNTIL IT COVERS THE PIPE.
- PLACE DRAINAGE FABRIC OVER TOP OF PIPE AND STONE.
- PLACE TOPSOIL AND SOD OR PEA GRAVEL.
- CUT AND ROUTE DOWNSPOUTS OR OTHER RAINWATER DELIVERY COMPONENTS. ADD STRAP AND SUPPORT AS
- CREATE A SAFE OVERFLOW AT LEAST 10 FEET FROM YOUR PROPERTY EDGE AND INSURE IT IS PROTECTED FROM EROSION.

WATER QUALITY CALCULATIONS:

POST-CONSTRUCTION LOT COVERAGE			
AREA	SF	NOT/TREATED	BMP LOCATION
EXISTING HOUSE	2561	NOT TREATED	N/A
EXISTING DECKS	317	NOT TREATED	N/A
REMAINING CONCRETE DRIVEWAY	2106	NOT TREATED	N/A
EXISTING CONCRETE SIDEWALK	50	NOT TREATED	N/A
EXISTING FRONT PORCH	13	NOT TREATED	N/A
EXISTING STAIRS	63	NOT TREATED	N/A
PROPOSED GARAGE	560	TREATED	TRENCH
PROPOSED DRIVEWAY ADDITION	190	TREATED	TRENCH
PROPOSED POOL	618	TREATED	TRENCH
PROPOSED DECK	260	TREATED	TRENCH
PROPOSED POOL WALKWAY	136	TREATED	TRENCH
PROPOSED WALL	57	TREATED	TRENCH
PROPOSED POOL EQUIPMENT	15	TREATED	TRENCH
PROPOSED TURF DECK/WALKWAY	0	NOT TREATED	N/A
TREATED IMPERVIOUS AREA	1836	SF	
TOTAL IMPERVIOUS AREA	6946	SF	

Water Quality / Runoff Reduction	Calcula	tions
Per GSWMM Section 2.2.4.1		
Water Quality Volume (WQv)		
Runoff Reduction (RRv)		
Site Area (A) =	20152	SF
Treated Impervious Area =	1836	SF
% impervious (I) =	10	%
RRv = (P.Rv.A)/12	235	CF
Rv = 0.05 + I*(0.009)	0.140	
WQv = 1.2*Rv*A/12	282.1	CF


WQ Calculations		1.2" required for required area impervious	
	1000		
Required Treated Impervious Area =	1836.0	SF	
Required WQ Volume =	282.1	CF	
Pipe Volume			
Diameter of Pipe	3.0	FT	
Length of Pipe	18.0	FT	
Volume of Pipe	127.2	CF	
Gravel Volume			
All volume to be provided in stone storage infiltration		<u>th 40% void</u>	
Length of Trench	18.0	FT	
Width of Trench	8.0	FT	
Depth of Trench	4.0	FT	
Volume of Gravel = ((L x W x D) - Pipe Vol) x 0.4 =	179.5	CF	
Provided Volume = Gravel Vol + Pipe Vol =	306.7	CF	
Required Volume =	282.1	CF	
itequired volunic –			

WATER QUALITY DESCRIPTION:


WATER QUALITY IS PROVIDED FOR THE NEW IMPERVIOUS AREA OF 1,836 SF, WHICH INCLUDES THE PROPOSED GARAGE, POOL, AND DECK. SEE LOT COVERAGE CHART ON THIS PAGE.

THE STONE STORAGE TRENCH WILL DETAIN FOR A TOTAL OF 1,836 SF. THE TRENCH IS TO BE FILLED WITH #57 STONE (40% VOID RATIO). THE TOTAL REQUIRED VOLUME OF THE UNDERGROUND STONE STORAGE TRENCH IS 282.1 CUBIC FEET. THE TOTAL PROVIDED VOLUME OF THE UNDERGROUND STONE STORAGE TRENCH IS 303.6 CUBIC FEET. THE POSITION OF THE TRENCH IS SUCH THAT IT IS AT LEAST 10 FEET AWAY FROM THE STRUCTURES AND PROPERTY LINES. THE TRENCH IS 18 FT LONG, 8 FT WIDE, AND 4 FT DEEP. THE TRENCH CONTAINS A 3 FT DIAMETER PIPE.

THE WATER QUALITY VOLUMES PROVIDED BY THE BMP SHOWN EXCEED THE WQ STORAGE REQUIREMENTS.

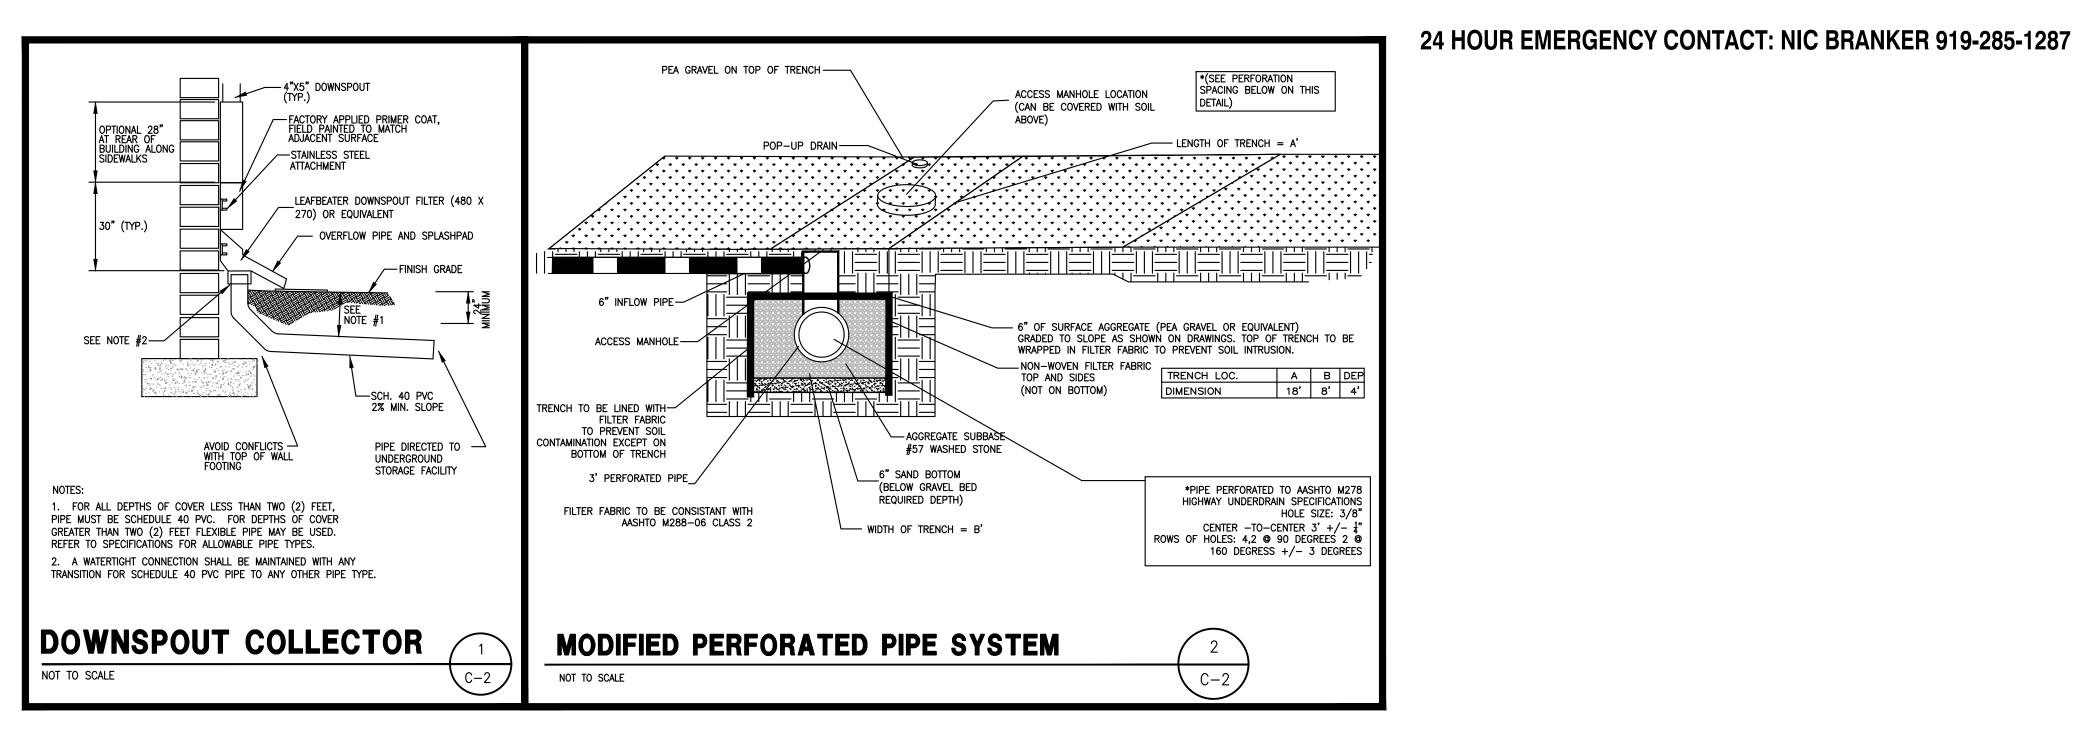

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Westminis uth

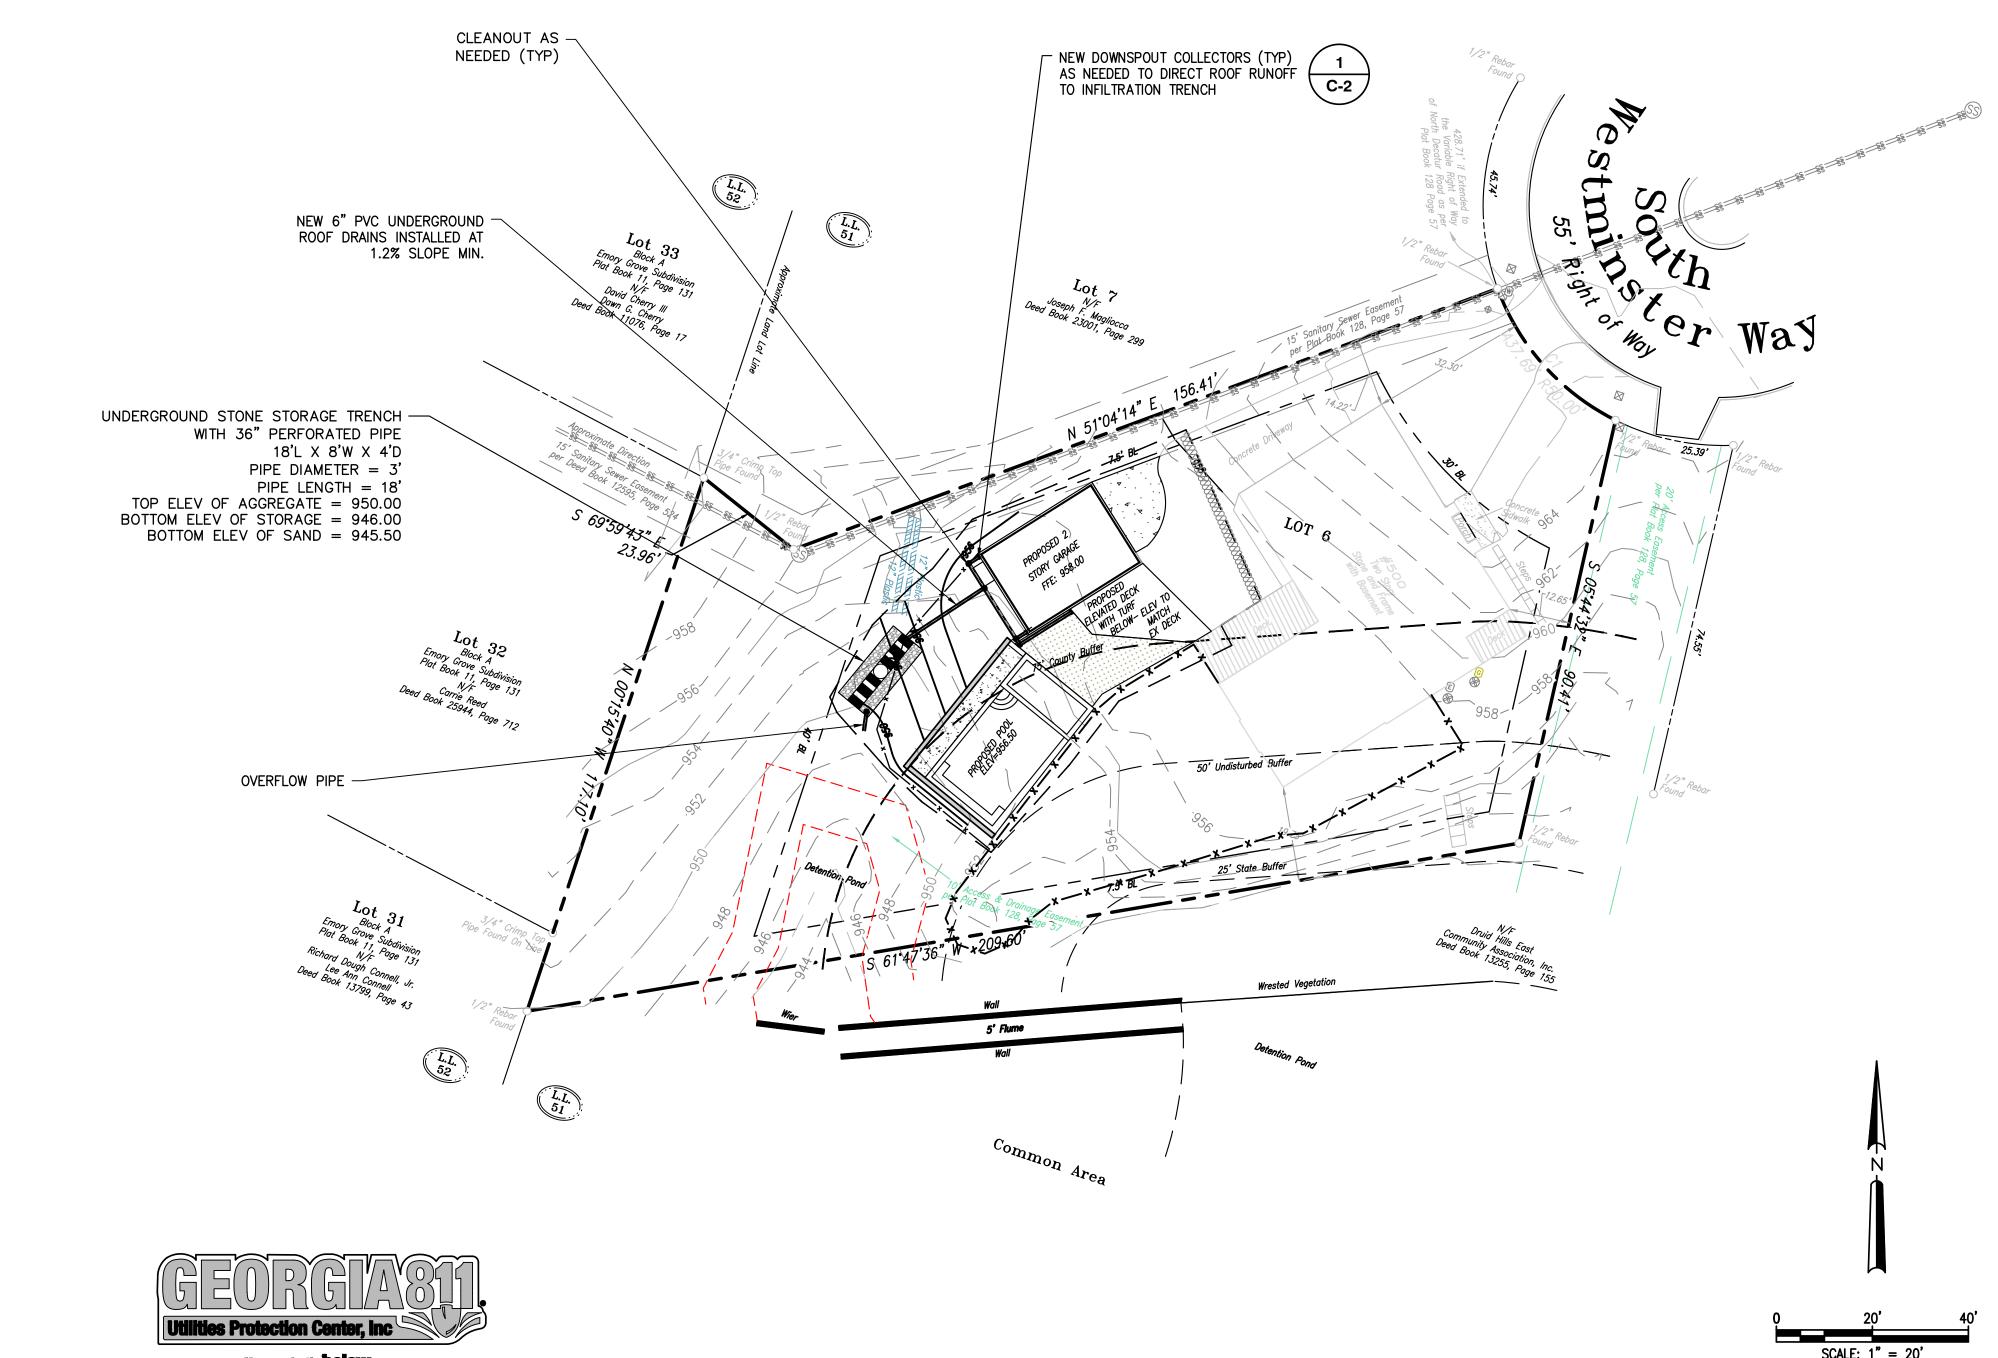CVE PI # 22-139

GRADING NOTES:

- 1. APPROVED EROSION CONTROL DEVICES MUST BE INSTALLED PRIOR TO ANY DETENTION BMP INSTALLATION (NOT PART OF THIS PLAN)
- 2. SURVEY INFORMATION TAKEN FROM SURVEYS PERFORMED BY GEORGIA LAND SURVEYING, CO, DATED 1-28-19
- 3. DISCOVERY OF UNSUITABLE SOILS OR ROCK MUST BE IMMEDIATELY REPORTED TO THE OWNER AND ENGINEER. ALL EARTHWORK MUST NOT PROCEED AT THAT POINT UNTIL OWNER RELEASES THE CONTRACTOR TO PROCEED.
- 4. THE CONTRACTOR IS SPECIFICALLY CAUTIONED THAT THE LOCATION OF UTILITIES AND/OR ELEVATION OF EXISTING UTILITIES AS SHOWN ON THESE PLANS ARE BASED ON RECORDS PROVIDED TO THE ENGINEER. INFORMATION SHOWN IS NOT TO BE RELIED ON AS BEING EXACT OR COMPLETE. THE CONTRACTOR MUST CALL THE APPROPRIATE UTILITY COMPANY AT LEAST 48 HOURS BEFORE ANY EXCAVATION TO REQUEST EXACT FIELD LOCATION OF UTILITIES.
- 5. CONTRACTOR SHALL FOLLOW ALL APPLICABLE SAFETY AND CONSTRUCTION PROCEDURES, ORDINANCES, CODES, AND STANDARDS.
- 6. CONTRACTOR SHALL CONTACT THE UTILITY LOCATOR AS REQUIRED BY GEORGIA LAW AND HAVE ALL UTILITIES MARKED PRIOR TO ANY CONSTRUCTION ACTIVITY. CONTRACTOR WILL HAVE PRIVATE UTILITY LOCATOR LOCATE ALL UTILITIES WITHIN THE CONSTRUCTION LIMITS NOT COVERED BY THE UTILITY PROTECTION CENTER.
- 7. ALL ELEVATIONS SHOWN ARE FINISHED GRADE.
- 8. THE APPROXIMATE LOCATION OF KNOWN UNDERGROUND UTILITIES HAVE BEEN SHOWN AS PROVIDED BY THE SURVEY. IT SHALL BE THE GENERAL CONTRACTOR'S RESPONSIBILITY TO FIELD VERIFY, LOCATE AND PROTECT ALL UTILITIES ON THE SITE. THE CONTRACTOR SHALL ALSO BE RESPONSIBLE FOR COORDINATING DEMOLITION, RELOCATION AND NEW UTILITY SERVICE WITH THE APPROPRIATE UTILITY. CONTRACTOR SHALL HIRE THEIR OWN UTILITY LOCATOR TO IDENTIFY ALL EXISTING UTILITIES WITHIN THE PROPOSED CONSTRUCTION AREA. ALL EXISTING SANITARY SEWER CONNECTIONS TO BE IDENTIFIED AND CONNECTED TO NEW SANITARY SEWER LINES.
- 9. BEFORE STARTING WORK CONTRACTOR SHALL MAKE SUCH EXPLORATIONS AND PROBES AS NECESSARY TO ASCERTAIN ANY ACTIVE UTILITY LINES AND MAKE SURE THESE UTILITIES CAN BE BROKEN OR CHANGED WITHOUT ANY DANGER OR DISRUPTION TO ANY NECESSARY SERVICE.
- 10. CONTRACTOR SHALL COMPLY TO THE FULLEST EXTENT WITH THE LATEST STANDARDS OF OSHA DIRECTIVES OR ANY OTHER AGENCY HAVING JURISDICTION FOR EXCAVATION AND TRENCHING PROCEDURES. THE CONTRACTOR SHALL SUPPORT SYSTEMS, SLOPING, BENCHING, AND OTHER MEANS OF PROTECTION. THIS TO INCLUDE, BUT IS NOT LIMITED TO ACCESS AND EGRESS FROM ALL EXCAVATION AND TRENCHING. CONTRACTOR IS RESPONSIBLE TO COMPLY WITH PERFORMANCE CRITERIA FOR OSHA.

ES&PC NOTES:


- 1. THE CONSTRUCTION STAGING AREA WILL BE THE PROPOSED DRIVEWAY AND SHALL BE MAINTAINED IN A CONDITION WHICH WILL PREVENT ANY POTENTIAL TRACKING OF MUD ONTO PUBLIC STREETS.
- 2. SILT FENCES AND HAY BALE BARRIERS SHALL BE CLEANED OR REPLACED AND MAINTAINED IN FUNCTIONAL CONDITION UNTIL PERMANENT EROSION CONTROL MEASURES ARE ESTABLISHED.
- 3. SILT FENCE FABRIC SHALL BE COMPRISED OF GA. DOT QUALIFIED PRODUCTS LIST 36, FOR SILT FENCE FABRIC.
- 4. ALL GRASSING SHALL BE IN ACCORDANCE WITH CHAPTER 6, SECTION III "VEGETATIVE PRACTICES" OF THE MANUAL FOR EROSION AND SEDIMENT CONTROL IN GEORGIA.
- 5. ALL OTHER WORK SHALL BE PERFORMED IN ACCORDANCE WITH THIS SAME MANUAL.
- 6. THE CONTRACTOR SHALL CLEAN OUT ALL ACCUMULATED SILT FROM THE SILT FENCING AND REMOVE THE FENCING FROM THE SITE ONCE ALL DISTURBED AREAS ARE STABILIZED WITH PERMANENT VEGETATION.
- 7. EROSION CONTROL DEVICES WILL BE IN PLACE BEFORE SITE DISTURBANCE AND WILL BE PERIODICALLY INSPECTED AND REPAIRED OR RESTORED AS NEEDED TO FUNCTION PROPERLY UNTIL PERMANENT MEASURES ARE ESTABLISHED AND PROJECT IS COMPLETE, I.E.: CONSTRUCTION EXITS AND SILT FENCES SHALL BE RE—TOPPED OR CLEANED AS SILT REDUCES THEIR EFFECTIVENESS.
- 8. ANY ADDITIONAL CONSTRUCTION OTHER THAN SHOWN ON THIS PLAN WILL REQUIRE SEPARATE AND ADDITIONAL EROSION AND SEDIMENT CONTROL MEASURES AND APPROVAL.
- 9. TEMPORARY VEGETATION AND/OR HEAVY MULCH WILL BE USED TO STABILIZE AREAS. IN NO CASE SHALL A SITE BE LEFT BARE FOR MORE THAN TWO WEEKS.
- 10. ALL DISTURBED AREAS WILL BE PERMANENTLY LANDSCAPED AND GRASSED AS SOON AS CONSTRUCTION PHASES PERMIT
- 11. ALL WORK SHALL BE PERFORMED IN ACCORDANCE WITH THE SPECIFICATION OF THE MANUAL FOR EROSION AND SEDIMENT CONTROL IN GEORGIA.
- 12. ADDITIONAL MEASURES MAY BE REQUIRED TO CONTROL EROSION AS DETERMINED NECESSARY BY INSPECTORS. THE EROSION CONTROL MEASURE CAN BE DESIGNED BY A LEVEL 1B (BLUE CARD) GASWCC CERTIFIED CONTRACTOR, UNLESS THE BMP HAS A HYDRAULIC COMPONENT. FOR ALL BMP DESIGN WITH A HYDRAULIC COMPONENT, THE BMP MUST BE DESIGNED BY A LEVEL 2 (GOLD CARD) GASWCC CERTIFIED DESIGNER. A CONSTRUCTION EXIT IS NOT PROPOSED DUE TO THE SMALL SIZE OF THE PROJECT AND THE LEVEL 1B CONTRACTOR MUST PROVIDE ALL MEASURES TO PREVENT ANY SILT FROM ENTERING THE STREAM BUFFER.

SEDIMENT STORAGE CALCULATIONS:

SILT FENCE PROVIDED = 205 LINEAR FEET OF SILT FENCE

SEDIMENT STORAGE REQUIRED = 0.10 DISTURBED AREA X 67 = 6.37 CY SEDIMENT STORAGE PROVIDED = 205 FT SILT FENCE X 0.05 = 10.25 CY



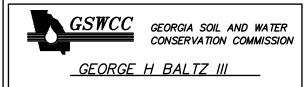

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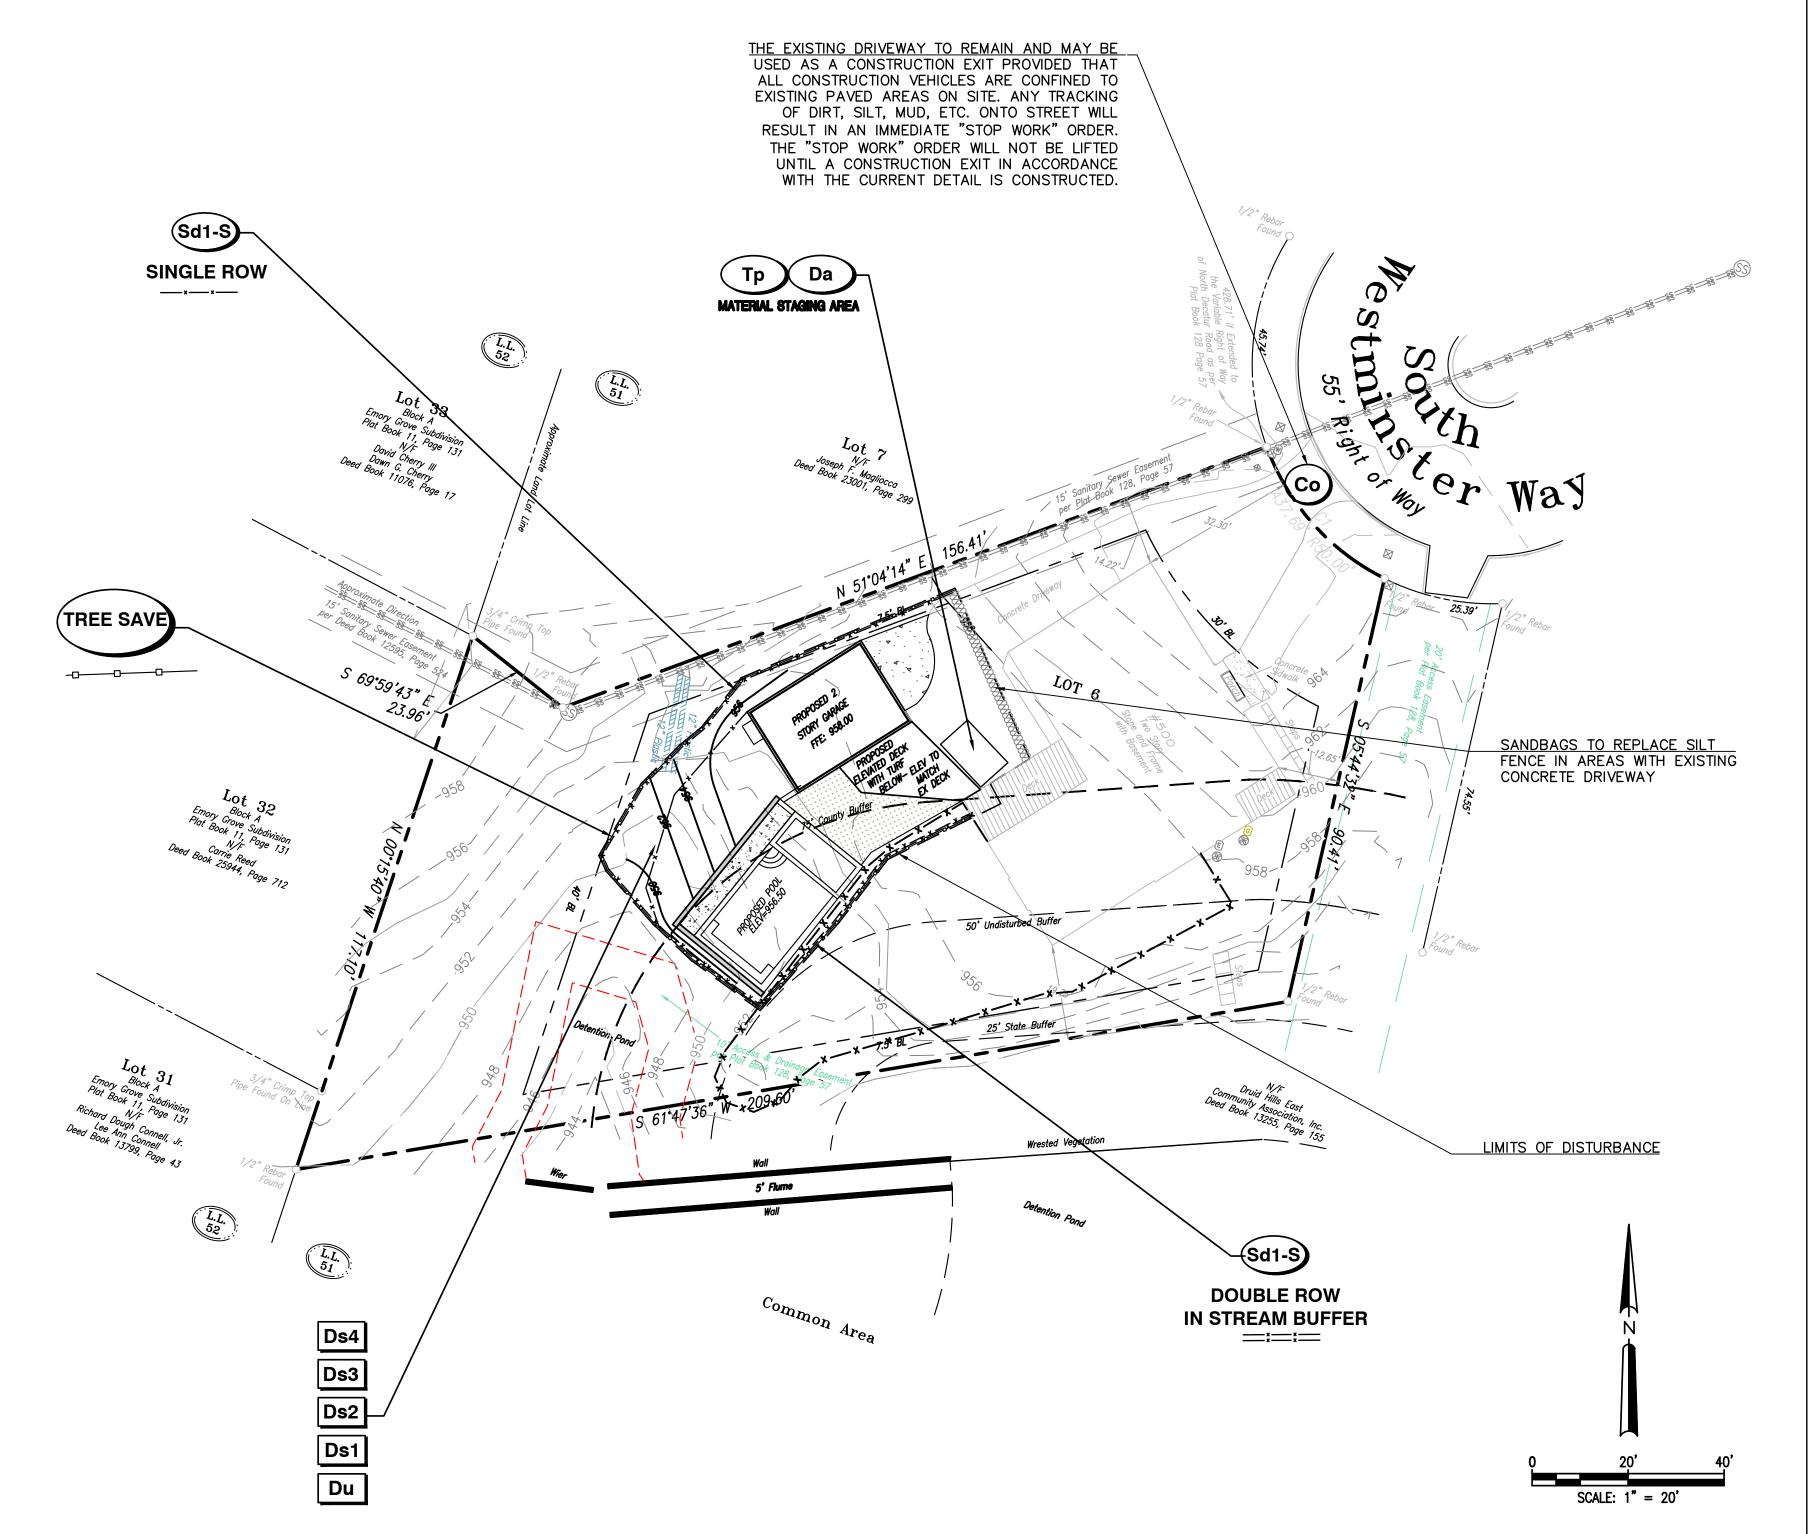
EXPIRES: 11/10/2025

CERTIFICATION NUMBER:

ISSUED: 09/25/2007

SICNED NUMBER: 0000045830 EXPIRATION 11–10–25

24 HOUR EMERGENCY CONTACT: NIC BRANKER 919-285-1287



Crescent View
Engineering, LLC
211 Frasier Street
Marietta, GA 30062
678-324-8410

Prepared For uth Westminister Way stanta, GA 30307 919-285-1287

So

500

ES&PC PLAN
3-15-23 REVISIONS
SHOWN
EF

Construction Plans For
500 South Westminister Way
Land Lot 51, 18th District
Dekalb County, Georgia

CVE PI # 22-139

ONSITE TREE CALCULATIONS:

ONSITE 1	TREES
TREE LIST - ONSITE PRIO	R TO CONSTRUCTION
TOTAL TREES	16
TOTAL INCHES	208
TOTAL UNITS	55
ONSITE LOST/DES	TROYED TREES
Size (Inches)	Туре
8	HARDWOOD
TOTAL TREES	1
TOTAL INCHES	8
TOTAL UNITS	2.4
ONSITE TREES SAVED WITH	LESS THAN 200/ INADACT
Size (Inches)	
9	Type HARDWOOD
24	HARDWOOD
18	HARDWOOD
TOTAL INCLES	3
TOTAL UNITS	51
TOTAL UNITS	13.2
ONSITE TREES SAVED	WITH NO IMPACT
Size (Inches)	Туре
12	HARDWOOD
12	HARDWOOD
11	HARDWOOD
8	HARDWOOD
8	HARDWOOD
8	HARDWOOD
12	HARDWOOD
16	HARDWOOD
12	HARDWOOD
9	HARDWOOD
22	PINE
19	PINE
TOTAL TREES	12
TOTALINCHES	149
TOTAL UNITS	39.4
ONSITE SPECIMENT TR	 FFS IMPΔCT (>20%)
Size (Inches)	Type
N/A	N/A
TOTAL TREES	0
	0
TOTAL INCHES TOTAL UNITS	0

BOUNDARY TREE CALCULATIONS:

TREES TO REMAIN = 200"

MINIMUM DENSITY REQUIREMENT MET WITH EXISTING TREES

BOUNDARY	TREES				
BOUNDARY TREES SAVED WITH LESS THAN 20% IMPACT					
Size (Inches)	Туре				
60	HW				
19	HW				
12	HW				
9	HW				
20	PINE				
TOTAL TREES	5				
TOTAL INCHES	120				
TOTAL UNITS	43.6				
JNDARY SPECIMEN TREES SAVED Size (Inches)	Туре				
Size (Inches)	Туре				
10	HW				
TOTAL TREES	1				
TOTAL INCHES	10				
TOTAL UNITS	3.2				
BOUNDARY TREES LO	ST/DESTROYED				
BOUNDARY TREES LO Size (Inches)	ST/DESTROYED Type				
Size (Inches)	Туре				
Size (Inches) N/A	Type N/A				



DEKALB COUNTY TREE NOTES:

- ALL TREE PROTECTION AREAS TO BE PROTECTED FROM SEDIMENTATION.
 ALL TREE PROTECTION DEVICES TO BE INSTALL PRIOR TO LAND DISTURBANCE AND MAINTAINED UNTIL FINAL LANDSCAPING.
- 3. ALL TREE PROTECTION FENCING TO BE INSPECTED DAILY AND REPAIRED OR REPLACED AS NEEDED.

 4. NO PARKING STORAGE OR OTHER CONSTRUCTION ACTIVITIES TO OCCUR WITHIN TREE
- 4. NO PARKING, STORAGE OR OTHER CONSTRUCTION ACTIVITIES TO OCCUR WITHIN TREE PROTECTION AREAS OR WITHIN SIX (6) FEET OF THE CRZ.
 5. ALL REQUIRED VEGETATION MUST BE MAINTAINED FOR TWO GROWING SEASONS AFTER DATE OF FINAL INSPECTION.

DEKALB COUNTY NOTES:

24 HOUR EMERGENCY CONTACT: NIC BRANKER 919-285-1287

- NO ONE SHALL ENCROACH, PLACE SOLVEMENTS, BUILDING, MACHINERY, BUILDING DEBRIS OR ANY OTHER MATERIAL WITHIN 6' OUTSIDE THEE PERIPHERY OF THE CRZ OR WITHIN ANY TREE SAVE AREA, TRANSITIONAL BUFFER ZONE, STREAM BUFFER, OR STATE BUFFER ZONE.
- ALL TREE FENCE AND OTHER TREE PROTECTION DEVICES MUST REMAIN IN FUNCTIONING CONDITION UNTIL COMPLETION OF THE PROJECT OR UNTIL THE CO IS ISSUED.
- A TREE THAT IS DESIGNATED TO BE SAVED, BUT IS DAMAGED DURING CONSTRUCTION, SHALL BE REPLACED WITH 4" CALIPER TREES EQUAL TO THE UNIT VALUE OF THE TREE REMOVED. ANY SPECIMEN TREE DAMAGED SHALL BE REPLACED WITH 4" CALIPER TREES EQUAL TO 1.5 TIMES THE DBH OF THE DAMAGED SPECIMEN.
 4. ALL PROTECTION AREAS TO BE PROTECTED FROM SEDIMENTATION.
- LANDSCAPING.
 6. ALL TREE PROTECTION FENCING TO BE INSPECTED DAILY, AND REPAIRED OR REPLACED AS


5. ALL TREE PROTECTION DEVICES, INCLUDING CRITICAL ROOTZONE(CRZ) PROTECTION, TO BE

7. NO PARKING, STORAGE OR OTHER CONSTRUCTION ACTIVITIES ARE TO OCCUR WITHIN TREE

INSTALLED PRIOR TO THE START OF THE LAND DISTURBANCE, AND MAINTAINED UNTIL FINAL

- PROTECTION AREAS(CRZ).

 8. ALL REQUIRED VEGETATION MUST BE MAINTAINED FOR TWO GROWING SEASONS AFTER THE
- DATE OF FINAL INSPECTION.
- 9. <u>THE PROTECTION SIGNS</u> ARE TO BE PLACED AT LEAST EVERY 50' ALONG THE LENGTH OF THE TREE PROTECTION FENCE. THE SIGNS SHOULD BE IN LANGUAGE SO THAT ALL WORKERS ON SITE ARE ABLE TO UNDERSTAND.

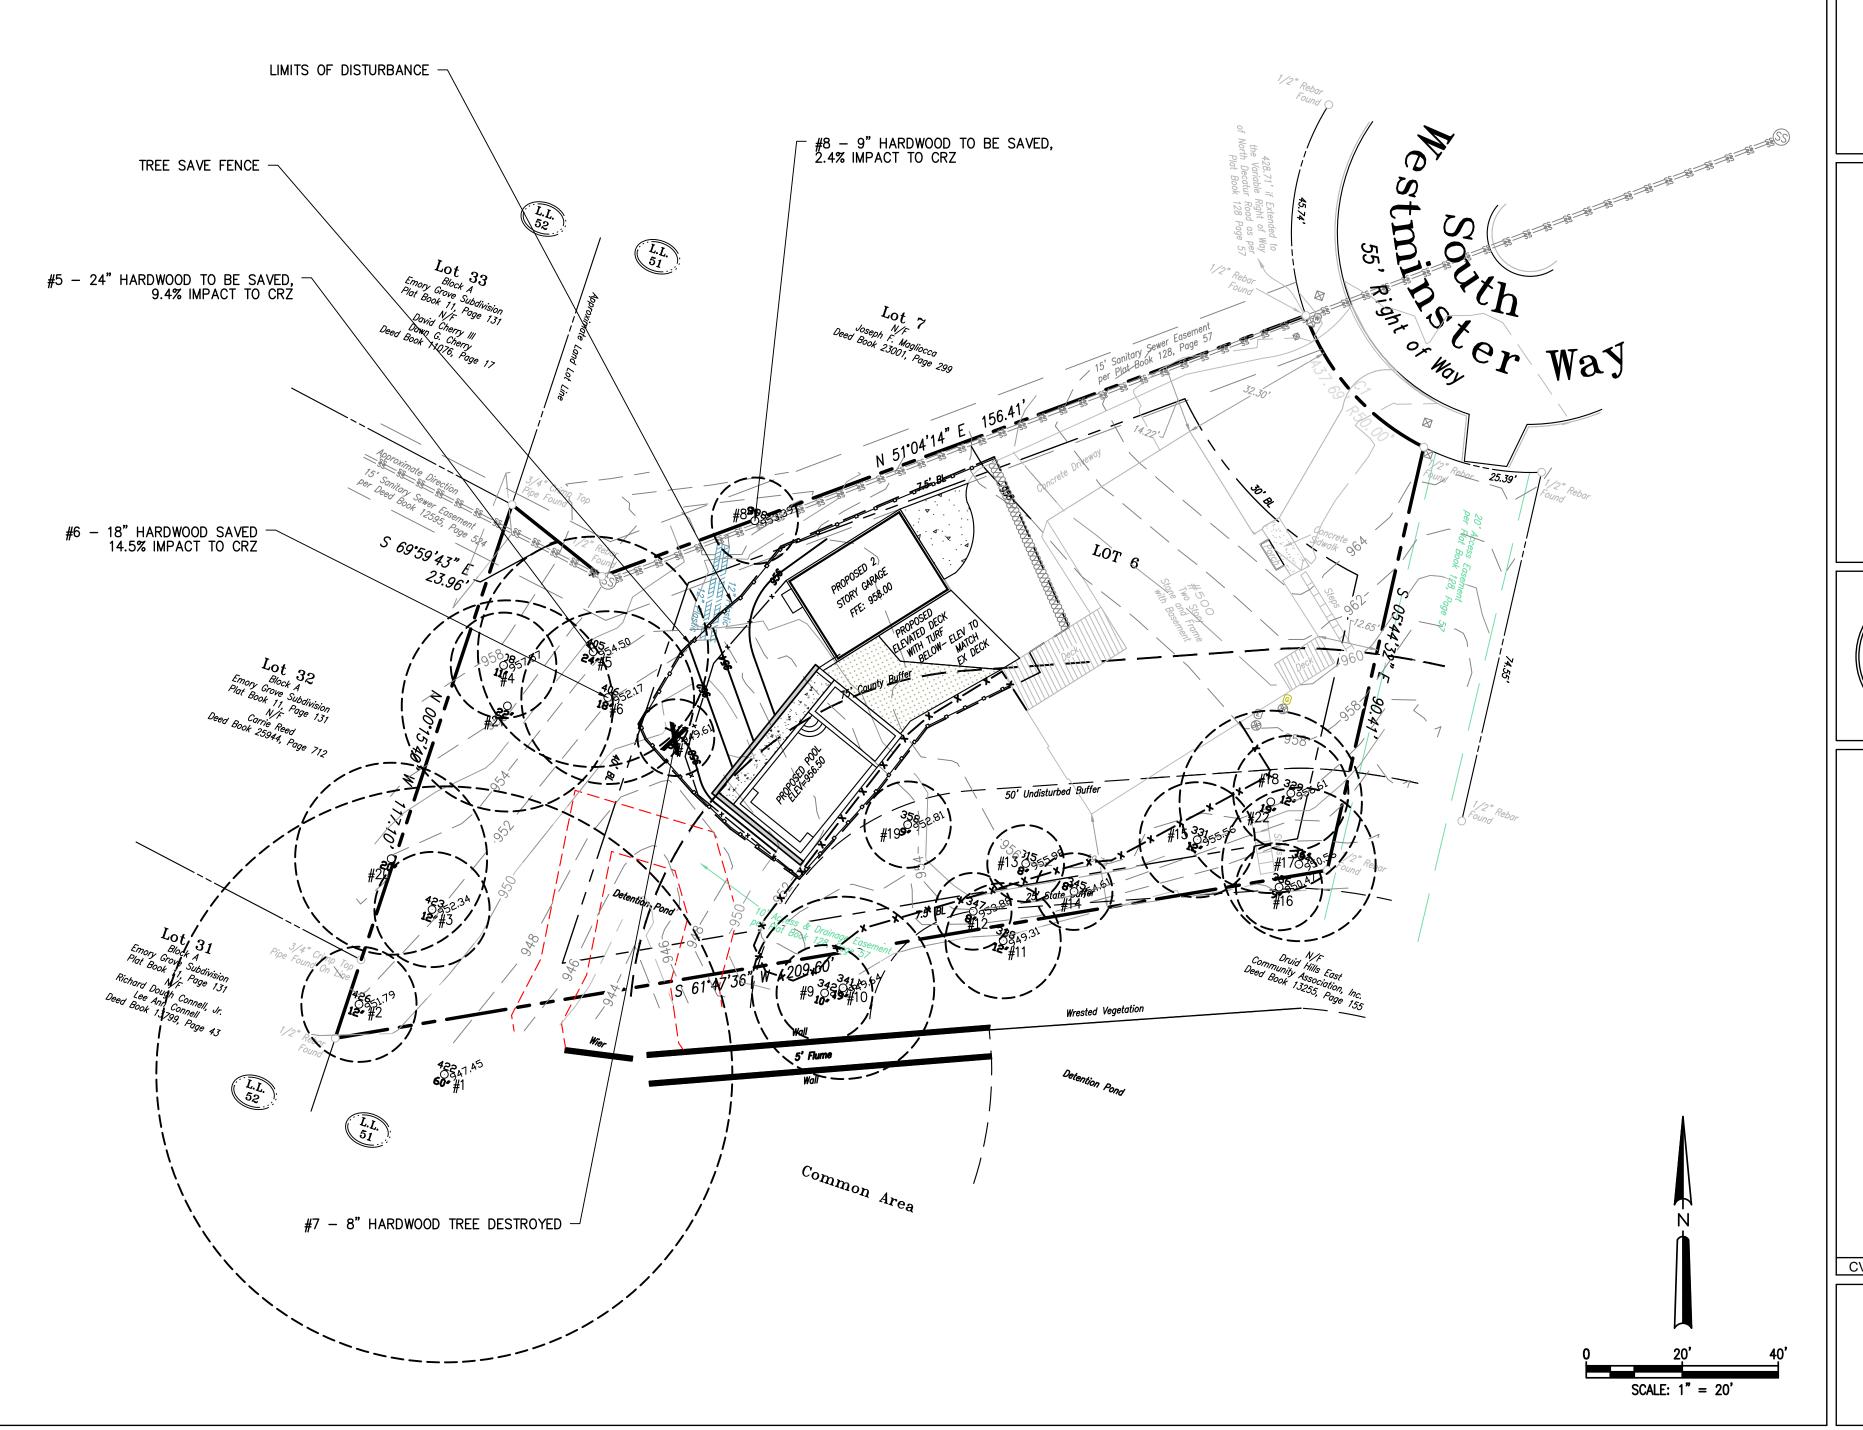

Prepared By
Crescent View
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ZVISIONS

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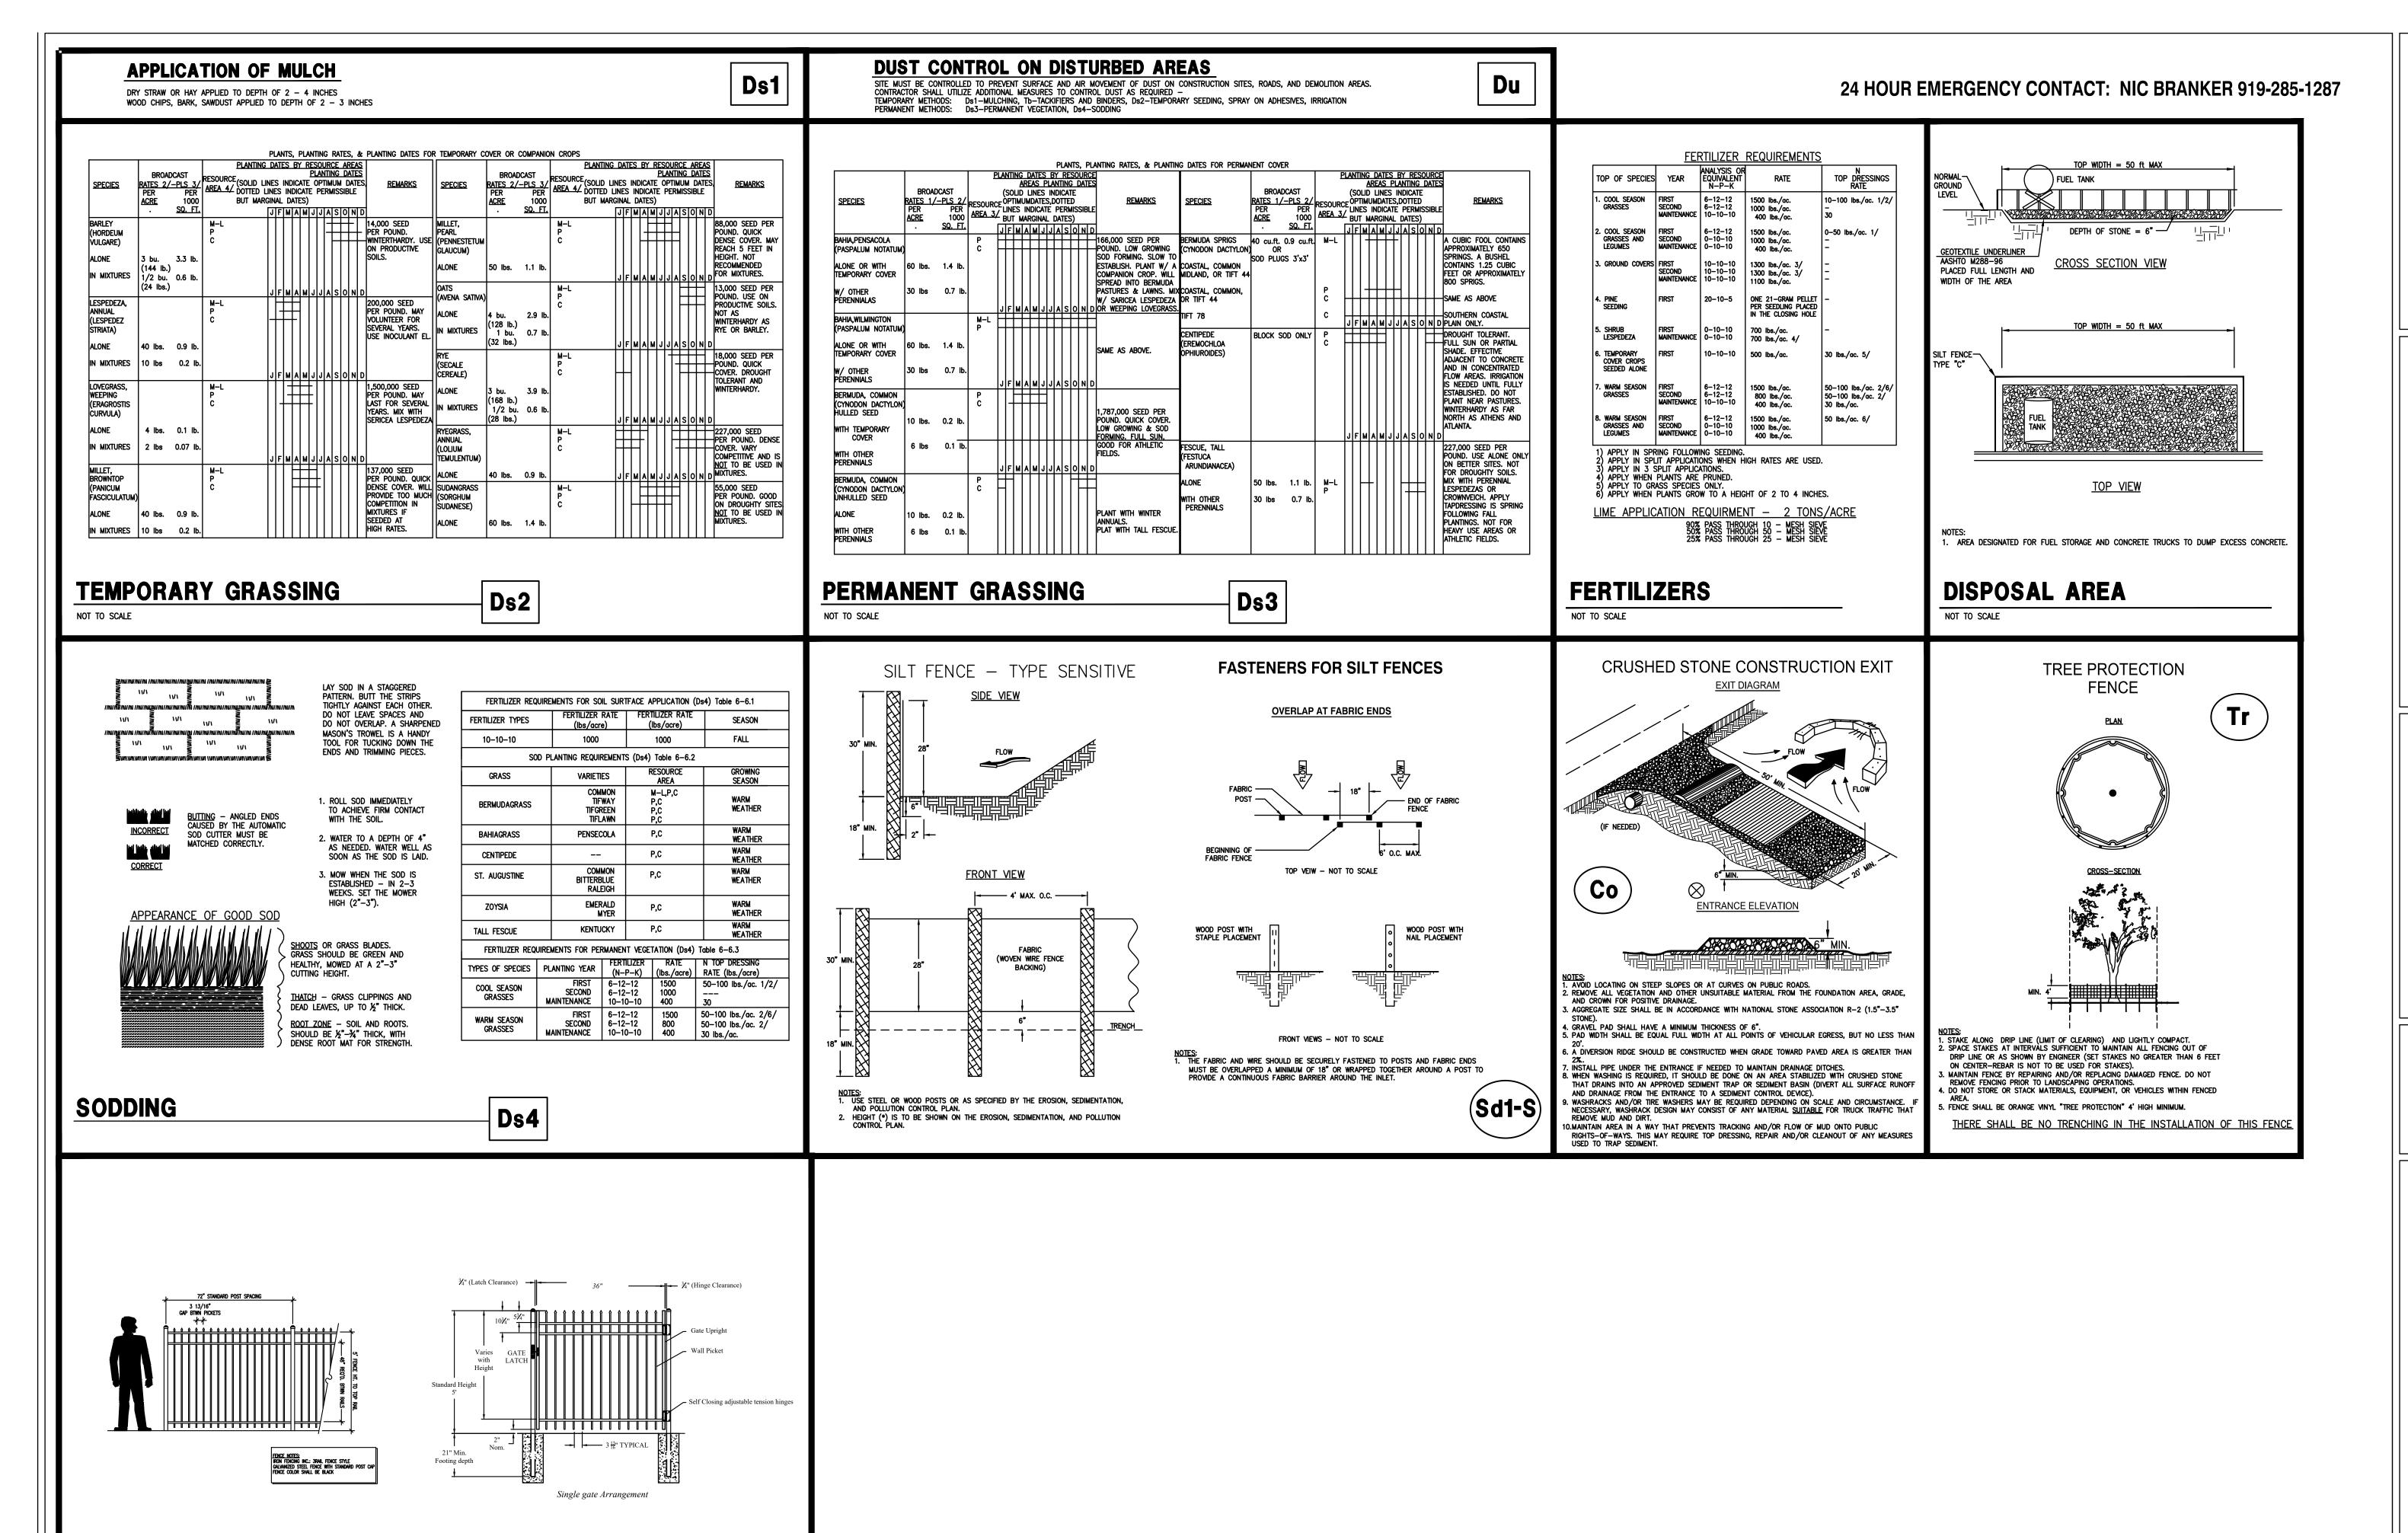
Construction Plans For

outh Westminister Way

Land Lot 51, 18th District

Dekalb County, Georgia

CVE PI # 22-139



5' HIGH DECORATIVE ALUMINUM FENCE

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Prepared For South Westminister 500 South Westminister Way Atlanta, GA 30307 919-285-1287

ON DETAILS

REVISIONS

uth Westminister Way
Land Lot 51, 18th District
Dekalb County, Georgia

CVE PI # 22-139

S

NIC BRANKER

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ADDITION @: 500 S WESTMINISTER WAY ATLANTA, GA 30307

RELEASED FOR CONSTRUCTION

JASON ALBERT 678 390 4655

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GENERAL NOTES:

THE INFORMATION SHOWN IN THESE DRAWINGS IS BASED ON ACTUAL FIELD MEASUREMENTS AND OTHER INFORMATION OF RECORD. ALL WORK DESCRIBED IN THESE PLANS SHALL BE CONSTRUCTED IN COMPLIANCE WITH THE FOLLOWING CONSTRUCTION CODES.

THE GEORGIA STATE MINIMUM CODES:

INTERNATIONAL BUILDING CODE - 2018 EDITION WITH GEORGIA STATE AMENDMENTS

INTERNATIONAL PLUMBING CODE - 2018 EDITION WITH GEORGIA STATE AMENDMENTS

INTERNATIONAL MECHANICAL CODE - 2018 EDITION WITH GEORGIA STATE AMENDMENTS

AND IPC APPENDIX F

INTERNATIONAL FUEL GAS CODE - 2018 EDITION WITH GEORGIA STATE AMENDMENTS

2020 NATIONAL ELECTRICAL CODE (NEC)

INTERNATIONAL ENERGY CONSERVATION CODE - 2015 EDITION WITH GEORGIA STATE AMENDMENTS

INTERNATIONAL RESIDENTIAL CODE FOR ONE & TWO FAMILY DWELLINGS, 2018 EDITION WITH GEORGIA STATE AMENDMENTS. AND IRC APPENDIX F

NTERNATIONAL FIRE PREVENTION CODE - 2018 EDITION WITH AMENDMENTS

THE GEORGIA EROSION AND SEDIMENTATION ACT OF 1975, THIRD EDITION 1992 NATIONAL FIRE PROTECTION ASSOCIATION (NFPA) 2018 EDITION USED BY GA DCA

OCGA TITLE 25 AND 30 AND CHAPTER 120 OF THE FIRE COMMISONER'S RULES AND REGULATIONS

THIS PLAN HAS BEEN PREPARED TO MEET PROFESSIONAL STANDARDS AND PRACTICES. HOWEVER, BUILDING CODE REQUIREMENTS VERY WITH LOCATION AND CHANGE FROM TIME TO TIME. BEFORE STARTING CONSTRUCTION, THE CONTRACTOR MUST REVIEW AND BE RESPONSIBLE FOR ALL DIMENSIONS AND OTHER

DETAILS AND SHOULD REVIEW PLANS TO INSURE THEY MEET CURRENT REQUIREMENTS. THE CONTRACTOR ASSUMES FULL RESPONSIBILITY TO VERIFY THE CONDITIONS, DIMENSIONS, AND STRUCTURAL DETAILS OF THE BUILDING, AND ASSUMES FULL LIABILITY FOR ANY PROBLEMS THAT MAY ARISE DUE TO POSSIBLE ERRORS ON THESE PLANS. ALL FEDERAL, STATE AND LOCAL CODES. ORDINANCES, REGULATIONS, ETC.,SHALL BE CONSIDERED AS PART OF SPECIFICATIONS FOR THIS BUILDING AND SHALL TAKE PRECEDENCE OVER ANYTHING SHOWN, DESCRIBED OR IMPLIED WHERE SAME ARE AT VARIANCE. USE OF THESE PLANS CONSTITUTES COMPLIANCE WITH

THESE PLANS HAVE BEEN GENERATED FOR THE CLIENTS LISTED IN THE PROJECT NAME AND ARE NOT TO BE USED, REPRODUCED, COPIED, OR DISTRIBUTED FOR ANY OTHER PROJECT WITHOUT WRITTEN PERMISSION FROM STUDIO TEN DESIGNS

ALL MEANS AND METHODS OF CONSTRUCTION SHALL CONFORM TO CODES, LAWS, AND REGULATIONS OF DEKALB COUNTY, INCLUDING BUT NOT LIMITED TO FLUES. CHIMNEY, FIREPLACE, SMOKE DETECTOR, MASONRY, WOOD CONSTRUCTION, ROOFING, PLUMBING, ELECTRICAL WIRING, EXHAUST FANS, VENTING, MECHANICAL EQUIPMENT, AND DUCTWORK, ETC., AND SUCH CODES, LAWS, AND REGULATIONS SHALL GOVERN OVER ANY

CONFLICTING INFORMATION INDICATED ON THE CONSTRUCTION DOCUMENTS.

THE DESIGNER SHALL NOT BE RESPONSIBLE FOR CONSTRUCTION MEANS, METHODS, TECHNIQUES, SEQUENCES, OR PROCEDURES, OR SAFETY PRECAUTIONS IN CONNECTION WITH THE WORK, FOR ACTS OR OMISSIONS OF THE CONTRACTORS, SUBCONTRACTORS, OR ANY OTHER PERSONS PERFORMING ANY OF THE WORK OR THE FAILURE OF ANY OF THEM TO CARRY OUT THE WORK IN ACCORDANCE WITH THE CONTRACT DOCUMENTS AND / OR IN ACCORDANCE WITH LOCAL CODES, RESTRICTIONS, AND REQUIREMENTS

EACH NOTE ON ANY PAGE SHALL BE CONSIDERED AS ONE AND CONSISTENT FOR ALL PAGES.

ALL PLAN DIMENSIONS ARE TO FACE OF FINISH PARTITIONS UNLESS OTHERWISE NOTED.

ALL DIMENSIONS GOVERN OVER SCALE

. CONTRACTOR TO CHECK AND VERIFY ALL CONDITIONS AND DIMENSIONS IN FIELD PRIOR TO CONSTRUCTION - NOTIFY DESIGNER OF ANY DISCREPANCIES PRIOR TO CONSTRUCTION EACH BEDROOM SHALL HAVE AT LEAST ONE WINDOW WHOSE CLEAR OPENING IS A MINIMUM OF 5.7 SQ. FT. THE MINIMUM CLEAR WIDTH SHALL BE 20" AND MINIMUM CLEAR HEIGHT SHALL BE 24". GRADE FLOOR BEDROOM WINDOWS MAY HAVE A MINIMUM 5.0 SQ FT CLEAR OPENING

POURED CONCRETE FOUNDATION &/OR CMU WALLS SHALL BE MIN. NOMINAL 8" THICK AND STEEL REINFORCED AS NOTED ON DETAIL SECTIONS AND AS REQUIRED BY STATE, COUNTY, AND LOCAL CODES AND RESTRICTIONS.

CONCRETE WALLS SHALL BE INSPECTED BY LICENSED ENGINEER OR ARCHITECT PRIOR TO POURING. WATERPROOFING ON CONC. WALLS MUST CONFORM TO LOCAL CODE REQUIREMENTS.

USE 1/2" DIA. MIN. GALV. ANCHOR BOLTS OR STRAPS TO SECURE SILL PLATES 6'-0" O.C. AND A MAX. 12" FROM CORNERS. PROVIDE FOAM SILL SEAL BETWEEN TOP OF FOUNDATION WALL AND SILL PLATE

ALL PENETRATIONS THROUGH FOUNDATION WALLS MUST BE SEALED GAS TIGHT. 6. PROVIDE FREE DRAINING GRANULAR BACKFILL WITH A MAX. EQUIV. FLUID PRESSURE OF 30 LBS PER SQ. FT. PER FOOT OF BACKFILL AGAINST FOUNDATION WALLS

ROOFING AND MOISTURE PROTECTION

ALL METAL & SHINGLE ROOFING SYSTEM TO BE INSTALLED IN ACCORDANCE WITH MANUFACTURER'S SPECIFICATIONS AND ACCORDING TO THE GUIDELINES ESTABLISHED FOR CERTIFIED MFGR'S 20 YEAR NO DOLLAR LIMIT (NDL) WARRANTY.

PROVIDE METAL DRIP CAP AT STARTER COURSES ABOVE GUTTERS

PROVIDE FLASHING AT ALL DOORS, WINDOWS, AND OTHER OPENINGS AND AS NECESSARY AND AS PER CODE TO PREVENT MOISTURE PENETRATION.

METAL FLASHING, COUNTER FLASHING, AND COPING SHALL BE MIN #26 GAUGE NON CORROSIVE METAL AND SHALL BE USED AT ALL STEPS, VALLEYS, AND COUNTERS

MECHANICAL/PLUMBING/ ELECTRICAL CONTRACTORS SHALL BE REQUIRED TO SEAL ALL

HORIZONTAL & VERTICAL PENETRATIONS IN THE EXTERIOR WALL CAUSED BY THEIR TRADE . GENERAL CONTRACTOR IS RESPONSIBLE TO LOCATE AND PROVIDE NECESSARY STRUCTURAL. MECHANICAL

ELECTRICAL AND PLUMBING SLEEVES, ANCHORS, VENT OPENINGS ETC., THAT MIGHT BE REQUIRED.

ALL WALL PLATES IN CONTACT W/ MASONRY OR CONC. SURFACE SHALL BE PRESSURE TREATED.

ALL STUDS TO BE 2X4 OR 2X6 STUD GRADE SPF WITH ቻ CDX PLYWOOD EXTERIOR SHEATHING OR EQUAL.

ALL JOISTS AND RAFTERS TO BE SPRUCE/PINE/FIR #2 AND BETTER. ROOF SHEATHING TO BE # THK. C.D.X. ALL FLOOR SHEATHING TO BE 3/4" T & G C.D.X. EXCEPT AREAS TO RECEIVE HARDWOOD FLOORING TO BE 1/2" C.D.X. PLYWOOD SUBFLOOR. ALL PLYWOOD SUBFLOOR TO BE GLUED TO JOISTS WITH APPROVED CONSTRUCTION ADHESIVE AND NAILED PER BLDG CODE.

MANUFACTURED TRUSS JOIST SHALL BE INSTALLED IN ACCORDANCE WITH ALL MANUFACTURER'S SPECS. TRUSS JOIST SHALL BE TRUSS JOIST MACMILLAN TJI-PRO 250 OR TJI PRO 350 OR EQUAL WITH RIM JOIST AS PER MFGR. SPECS. PROVIDE APPROVED CRUSH BLOCKS AT ALL POINT LOADS AND ALL BEARING POINTS AS RECOMMENDED BY MANUFACTURER

5. PRECAST CONC, & LAMINATED WD BEAMS AND COLUMNS TO BE BUILT AND INSTALLED IN ACCORDANCE W/ ALL MANUFACTURER'S SPECIFICATIONS AND AS REQUIRED BY LOCAL CODES, RESTRICTIONS, AND REGULATIONS.

PROVIDE APPROVED JOIST HANGERS AT ALL FLUSH JOIST-TO-JOIST AND JOIST-TO-BEAM CONNECTIONS

HEADERS IN ALL BEARING PARTITIONS AND BEARING WALLS TO BE SOLID DIMENSIONAL LUMBER SIZED AS INDICATED ON FRAMING PLANS W/ SOLID PLYWOOD BETWEEN UNLESS OTHERWISE NOTED. LAMINATED HEADERS AND BEAMS SHALL BE NAILED AS PER MANUFACTURER'S SPECIFICATIONS.

8. ALL HEADERS IN EXCESS OF 4'-0" SHALL HAVE MIN. (2) TRIMMER JACKS ON EACH SIDE 9. PROVIDE ADDITIONAL JOIST OR TRUSS UNDER INTERIOR PARTITIONS RUNNING PARALLEL TO FLOOR

JOIST AND HAVING A LENGTH GREATER THAN 6'-0". DOUBLE JOIST UNDER BATHTUBS OR SPACE JOIST AT 12" O.C.

0. ALL BEARING PARTITIONS SHALL HAVE 2 TOP PLATES - STAGGER SPLICES 4'-0" MIN. SPLICES SHALL BE CENTERED OVER TOP OF STUDS. STUDS SHALL ALIGN WITH JOISTS AND RAFTERS ABOVE AND BELOW

PROVIDE 2X FIRESTOP BLOCKING AS REQUIRED BY CODE THROUGHOUT.

HOLES BORED OR CUT INTO JOISTS SHALL NOT OCCUR WITHIN 2" OF TOP OR BOTTOM OF JOISTS NOR IN CENTER ONE THIRD OF JOIST SPAN AND THE DIAMETER OF HOLES SHALL NOT EXCEED ONE THIRD OF THE DEPTH OF THE JOIST. NOTCHES SHALL NOT OCCUR IN TENSION SIDE OF JOIST. NOTCHES IN COMPRESSION SIDE OF JOISTS SHALL NOT OCCUR IN THE CENTER ONE THIRD OF THE SPAN AND SHALL NOT EXCEED ONE SIXTH OF THE

3. WHERE THE INSTALLATION OF PLUMBING, HEATING, OR OTHER PIPES NECESSITATES THE CUTTING OF TOP PLATES MORE THAN ONE HALF THEIR WIDTH A METAL TIE NOT LESS THAN 18 GAUGE AND 1 1/2" IN WIDTH SHALL BE FASTENED TO THE PLATE ACROSS AND TO EACH SIDE OF THE OPENING WITH NOT LESS THAN (4) 16 PENNY

. THE DIAMETER OF HOLES BORED IN BEARING WALL STUDS SHALL NOT EXCEED ONE THIRD THE WIDTH OF THE STUD. WHERE STUDS ARE CUT OR BORED IN EXCESS OF ONE THIRD THE WIDTH OF THE STUD IT SHALL BE REINFORCED TO BE EQUAL IN LOAD CARRYING CAPACITY TO A STUD NOTCHED NOT MORE THAN ONE THIRD ITS DEPTH.

STEEL LINTELS: (FOR EACH 4" THICKNESS OF MASONRY WALL) UP TO 3'-11" L3 = X 3= X 5/16 4'-0" TO 5'-11" L4" X 3¹/₂" X 5/16 6'-0" TO 7'-11" L5" X 3¹/₇" X 5/16

8'-0" TO 10'-0" W8X15 W/ SUSPENDED PLATE

3'-1" TO 5'-0" 2-2X8 5'-1" TO 6'-0" 2-2X10 6'-1" TO 7'-0" 2-2X12 12"

REINFORCED CMU LINTELS: PROVIDE A MINIMUM OF 8" BEARING AT EACH END OPENING WIDTH LINTEL SIZE AND REINFORCING

WALL THICKNESS X 8" DEEP, REINFORCED W/ 2#4 BOTTOM UP TO 8" THICK, REINFORCED W/3#4 BOTTOM OVER 8" THICK WALL THICKNESS X 16" DEEP, REINFORCED BOTTOM UP TO 8" THICK, REINFORCED W/ 3#5

PRECAST CONCRETE LINTELS: PROVIDE A MINIMUM OF 8" BEARING AT EACH END

BOTTOM OVER 8" THICK & #3 STIRRUPS @ 6" o.c.

WALL THICKNESS X 8" DEEP, REINFORCED W/2#4 BOTTOM 4'-1" TO 8'-0" WALL THICKNESS X 16" DEEP, REINFORCED W/ 2#5 BOTTOM

16. THE CONTRACTOR SHALL VERIFY ALL OPENINGS BELOW LINTELS INDICATED ARE ADEQUATE TO ACCEPT DOOR FRAMES, LOUVERS ETC. ARE SHOWN ON THE ARCHITECTURAL AND MECHANICAL DRAWINGS. NOTIFY THE ARCHITECT AND STRUCTURAL ENGINEER OF ANY DISCREPANCIES PRIOR TO LINTEL INSTALLATION.

NO OPENINGS SHALL BE PLACED ABOVE ANY LINTEL WITHIN A HEIGHT LESS THAN OR EQUAL TO THE WIDTH OF THE CLEAR OPENING BELOW THE LINTEL, UNLESS SPECIFICALLY SHOWN OR APPROVED BY THE STRUCTURAL

1. ALL EXTERIOR WOOD CORNICE AND TRIM SHALL BE PRIMED ON ALL SIDES PRIOR TO INSTALLATION 2. ALL INTERIOR WALLS AND CEILINGS TO BE $\frac{1}{2}$ THICK GYPSUM WALLBOARD EXCEPT AS OTHERWISE NOTED.

3. SHOWER AND TUB WALLS ARE TO BE CERAMIC TILE ON CEMENTINOUS TILE BACKER BOARD.

INTERIOR TRIM AND MOULDINGS INCLUDING BASE, CASINGS, CROWN, CHAIRRAIL, ETC. SHALL BE AS DETAILED AND/OR AS SELECTED BY OWNER

INSULATION IN EXTERIOR WALLS, FLOORS, OR CEILINGS SHALL BE PAPER BACKED BLANKET OR ROLL TYPE FIBERGLASS WITH VAPOR BARRIER.

INSULATION IN EXT. WOOD FRAME WALLS TO BE R-13 NOM. 38 AT 2X4 WALLS AND R-19 5 1/2" AT 2X6 WALLS

INSULATION IN FLAT CEILINGS ADJACENT TO ATTIC SPACES TO BE NOM. 10" (R-30)

4. PROVIDE R-13 INSULATION W/ FOIL VAPOR BARRIER AT CONC. FOUNDATION WALLS 5. NEW DOORS AND WINDOWS ARE REQ'D TO HAVE AN R-2.8 RATING MIN.

DRAINAGE OF FOOTINGS

. UNLESS OTHERWISE NOTED, PROVIDE PERIMETER BASEMENT WALLS WITH 4" OR 6"G, DIAMETER PERFORATED, CORRUGATED PLASTIC DRAIN LAID ON 2" GRAVEL BASE W/6" -8" GRAVEL COVER WITH JOINTS COVERED WITH FILTER CLOTH FOR PERFORATED TILE.

SLOPE DRAIN TILE AS REQUIRED TO DRAIN TO STORM SEWER OR OUTFALL.

3. PUT 18" OF GRAVEL ALL AROUND FOUNDATION.

DAMPPROOFING FOR CONCRETE AND MASONRY FOUNDATIONS EXTERIOR FOUNDATION WALLS OF CONSTRUCTION ENCLOSING BASEMENTS SHALL BE PORTLAND CEMENT

THE PARING SHALL BE COVERED WITH A COAT OF APPROVED BITUMINOUS MATERIAL APPLIED AT THE RECOMMENDED RATE.

REINFORCING STEEL SHALL BE HIGH STRENGTH NEW BILLET STEEL CONFORMING TO ASTM A615 -95C, GRADE 60 (60'000 PSI).

WELDED WIRE FABRIC (WWF) SHALL CONFORM TO ASTM A - 185.

PARGING TO THE WALL FROM FOOTING TO FINISH GRADE.

ALL REINFORCING SHALL BE DETAILED FABRICATED AND PLACED IN ACCORDANCE WITH THE ACI'S "MANUAL OF STANDARD PRACTICE FOR DETAILING CONCRETE STRUCTURES" (ACI - 315).

DETAILS OF REINFORCEMENT SHALL CONFIRM TO ACI 318 - 95, ACI 315 - 74 AND CRSI STANDARDS 6. ALL REINFORCING STEEL MARKED " CONTINUOUS " SHALL BE LAPPED 36 BAR DIAMETERS ST SPLICED

AND AROUND CORNER OR INTERSECTION WITH A STANDARD 90 DEGREE BEND ON CORNER BARS. LAP WELDED WIRE MESH ONE FULL MESH AT SIDE AND END LAPS.

SLABS ON GRADE SHALL BE 4" THK. CONCRETE AND REINFORCED WITH 6"X6" W1.4XW1.4 WWF LAP MESH 8" IN EACH DIRECTION. PLACE CONCRETE OVER 4 MIL. POLYETHYLENE VAPOR BARRIER AND 4" MINIMUM OF COARSE AGGREGATE OR AS RECOMMENDED BY SOILS ENGINEER. THE AGGREGATE LAYER SHALL BE PLACED OVER FIRM NATURAL SUB GRADE OR ON COMPACTED OR AND CONTROLLED FILL. FILL UNDER SLABS SHALL BE COMPACTED IN 8" LAYERS TO 95% MAXIMUM DENSITY. USE AIR ENTRAINED CONCRETE AT ALL EXTERIOR SLABS. POUR SLABS

AT 30'-0" MAXIMUM OR AS REQUIRED TO PREVENT UNCONTROLLED CRACKING.


IN ALTERNATE PANELS WITH MAXIMUM OF 600 SQUARE FEET AND PROVIDE CONTROL & CONSTRUCTION JOINTS

TYPE: NEW CONSTRUCTION NO. OF STORIES: 2 THIS BUILDING WAS DESIGNED IN ACCORDANCE WITH THE INTERNATIONAL RESIDENTIAL CODE FOR SINGLE-FAMILY DWELLINGS - 2018 EDITION WITH 2020 GEORGIA STATE AMENDMENTS

SCOPE OF WORK NEW CONSTRUCTION OF DETACHED GARAGE WITH APARTMENT LIVING

NEW DECK CONNECTING EXISTING DECK AND NEW DETACHED GARAGE



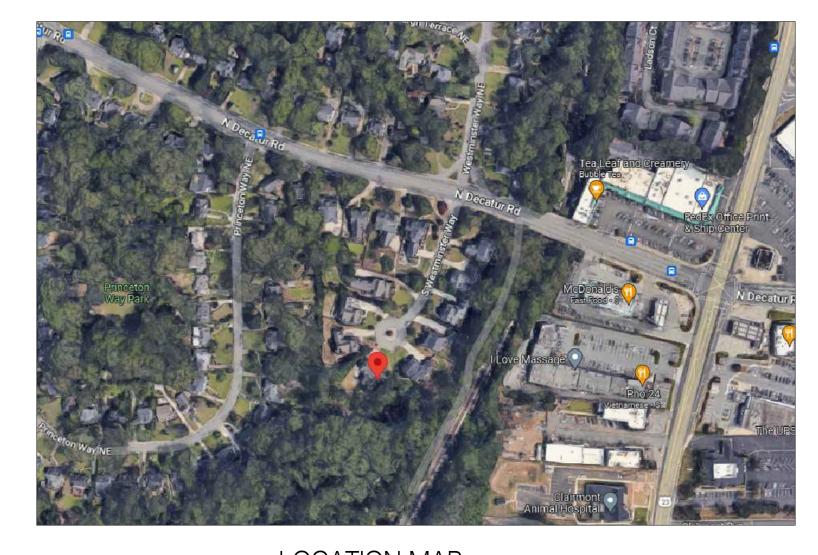

LOCATION MAP

SHEET INDEX:


CS COVER SHEET

A1 EXISTING PARTIAL FOUNDATION PLAN A2 EXISTING PARTIAL FLOOR PLANS A3 EXISTING PARTIAL ROOF & ROOF FRAMING PLAN

A4 EXISTING PARTIAL CEILING FRAMING PLANS A5 EXISTING PARTIAL EXTERIOR ELEVATIONS A6 PROPOSED FOUNDATION PLAN ATO PROPOSED FRAMING PLANS

SQ. FT. DATA

PROPOSED TOTAL PROPOSED DECK

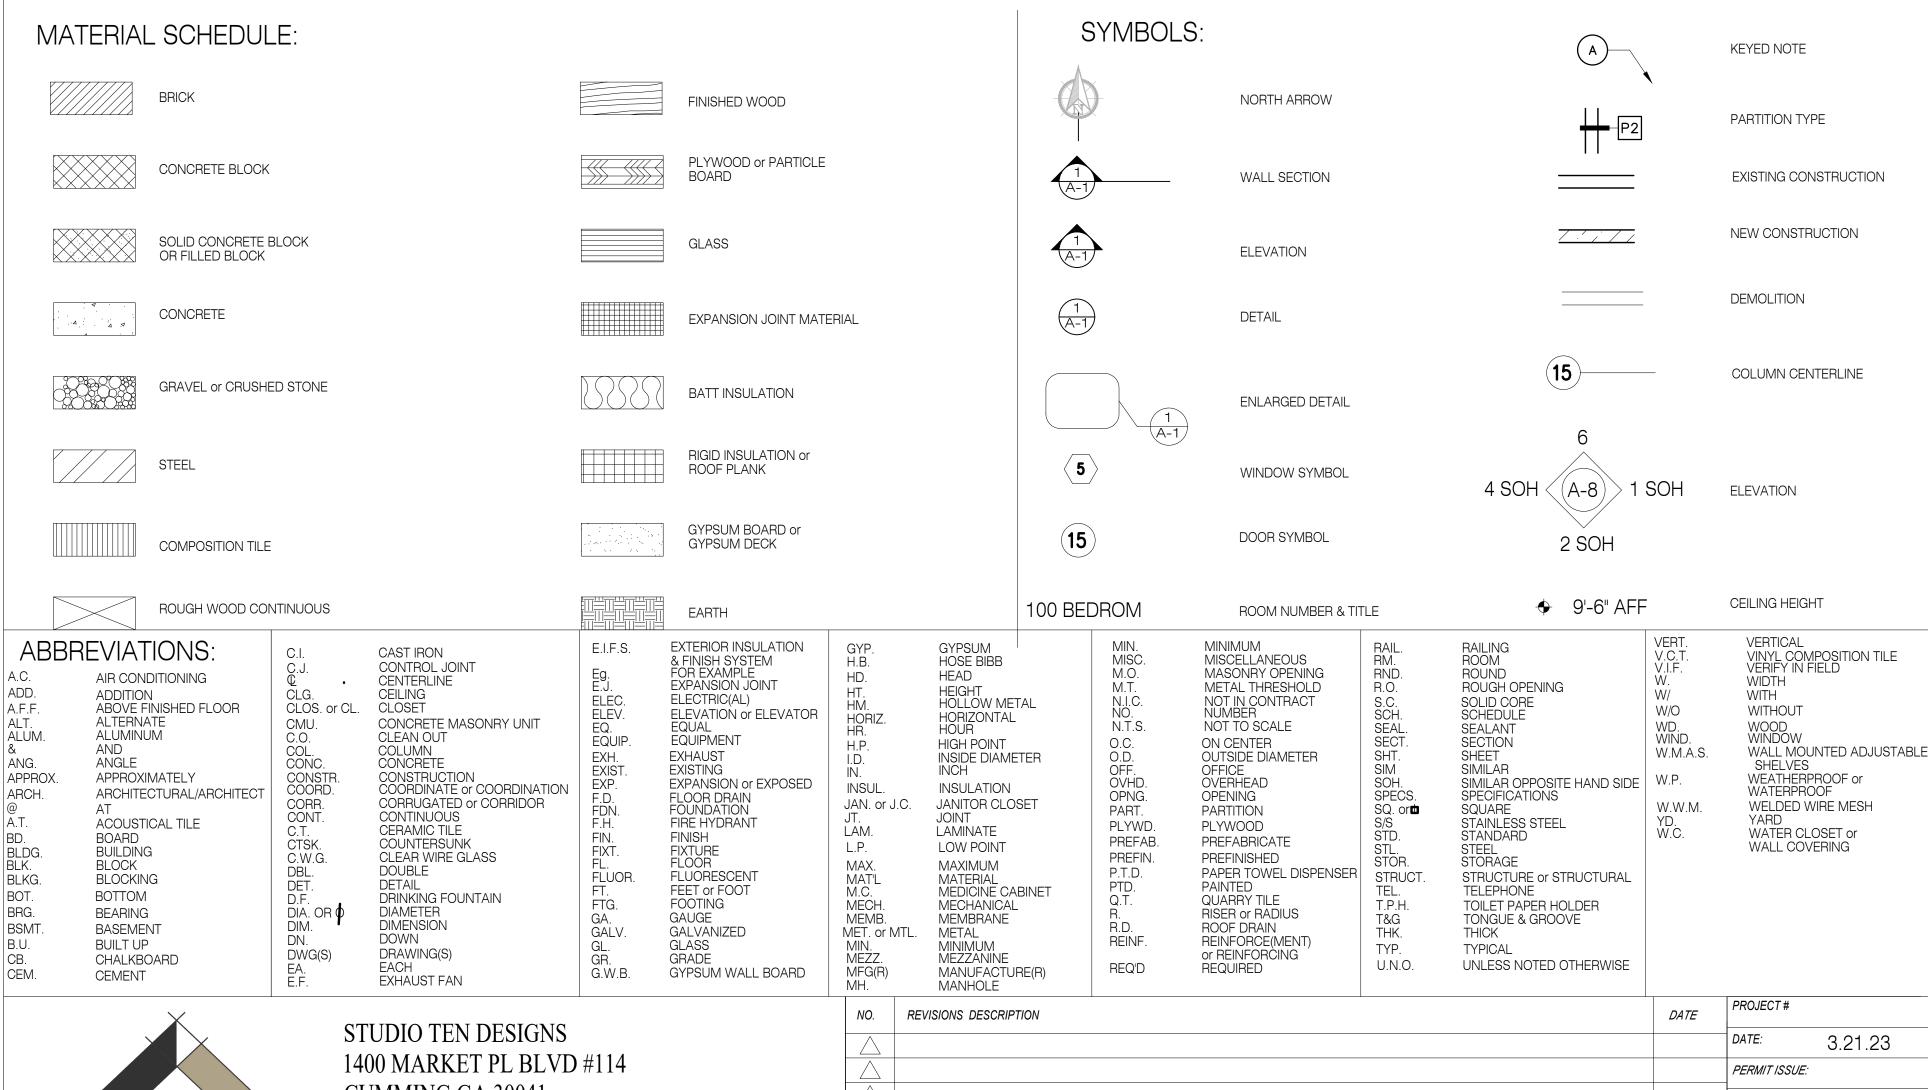



ARCHITECTURAL DESIGNS

CUMMING GA 30041

Studio Ten PHONE: 678.390.4655 EMAIL: JASON@STUDIOTENDESIGNS.COM

SLAB	
	SLAB

EXISTING PARTIAL FOUNDATION

SCALE: 1/4" = 1'-0"

ENGINEER STAMP & SEAL



STUDIO TEN DESIGNS



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PROJECT MANAGER

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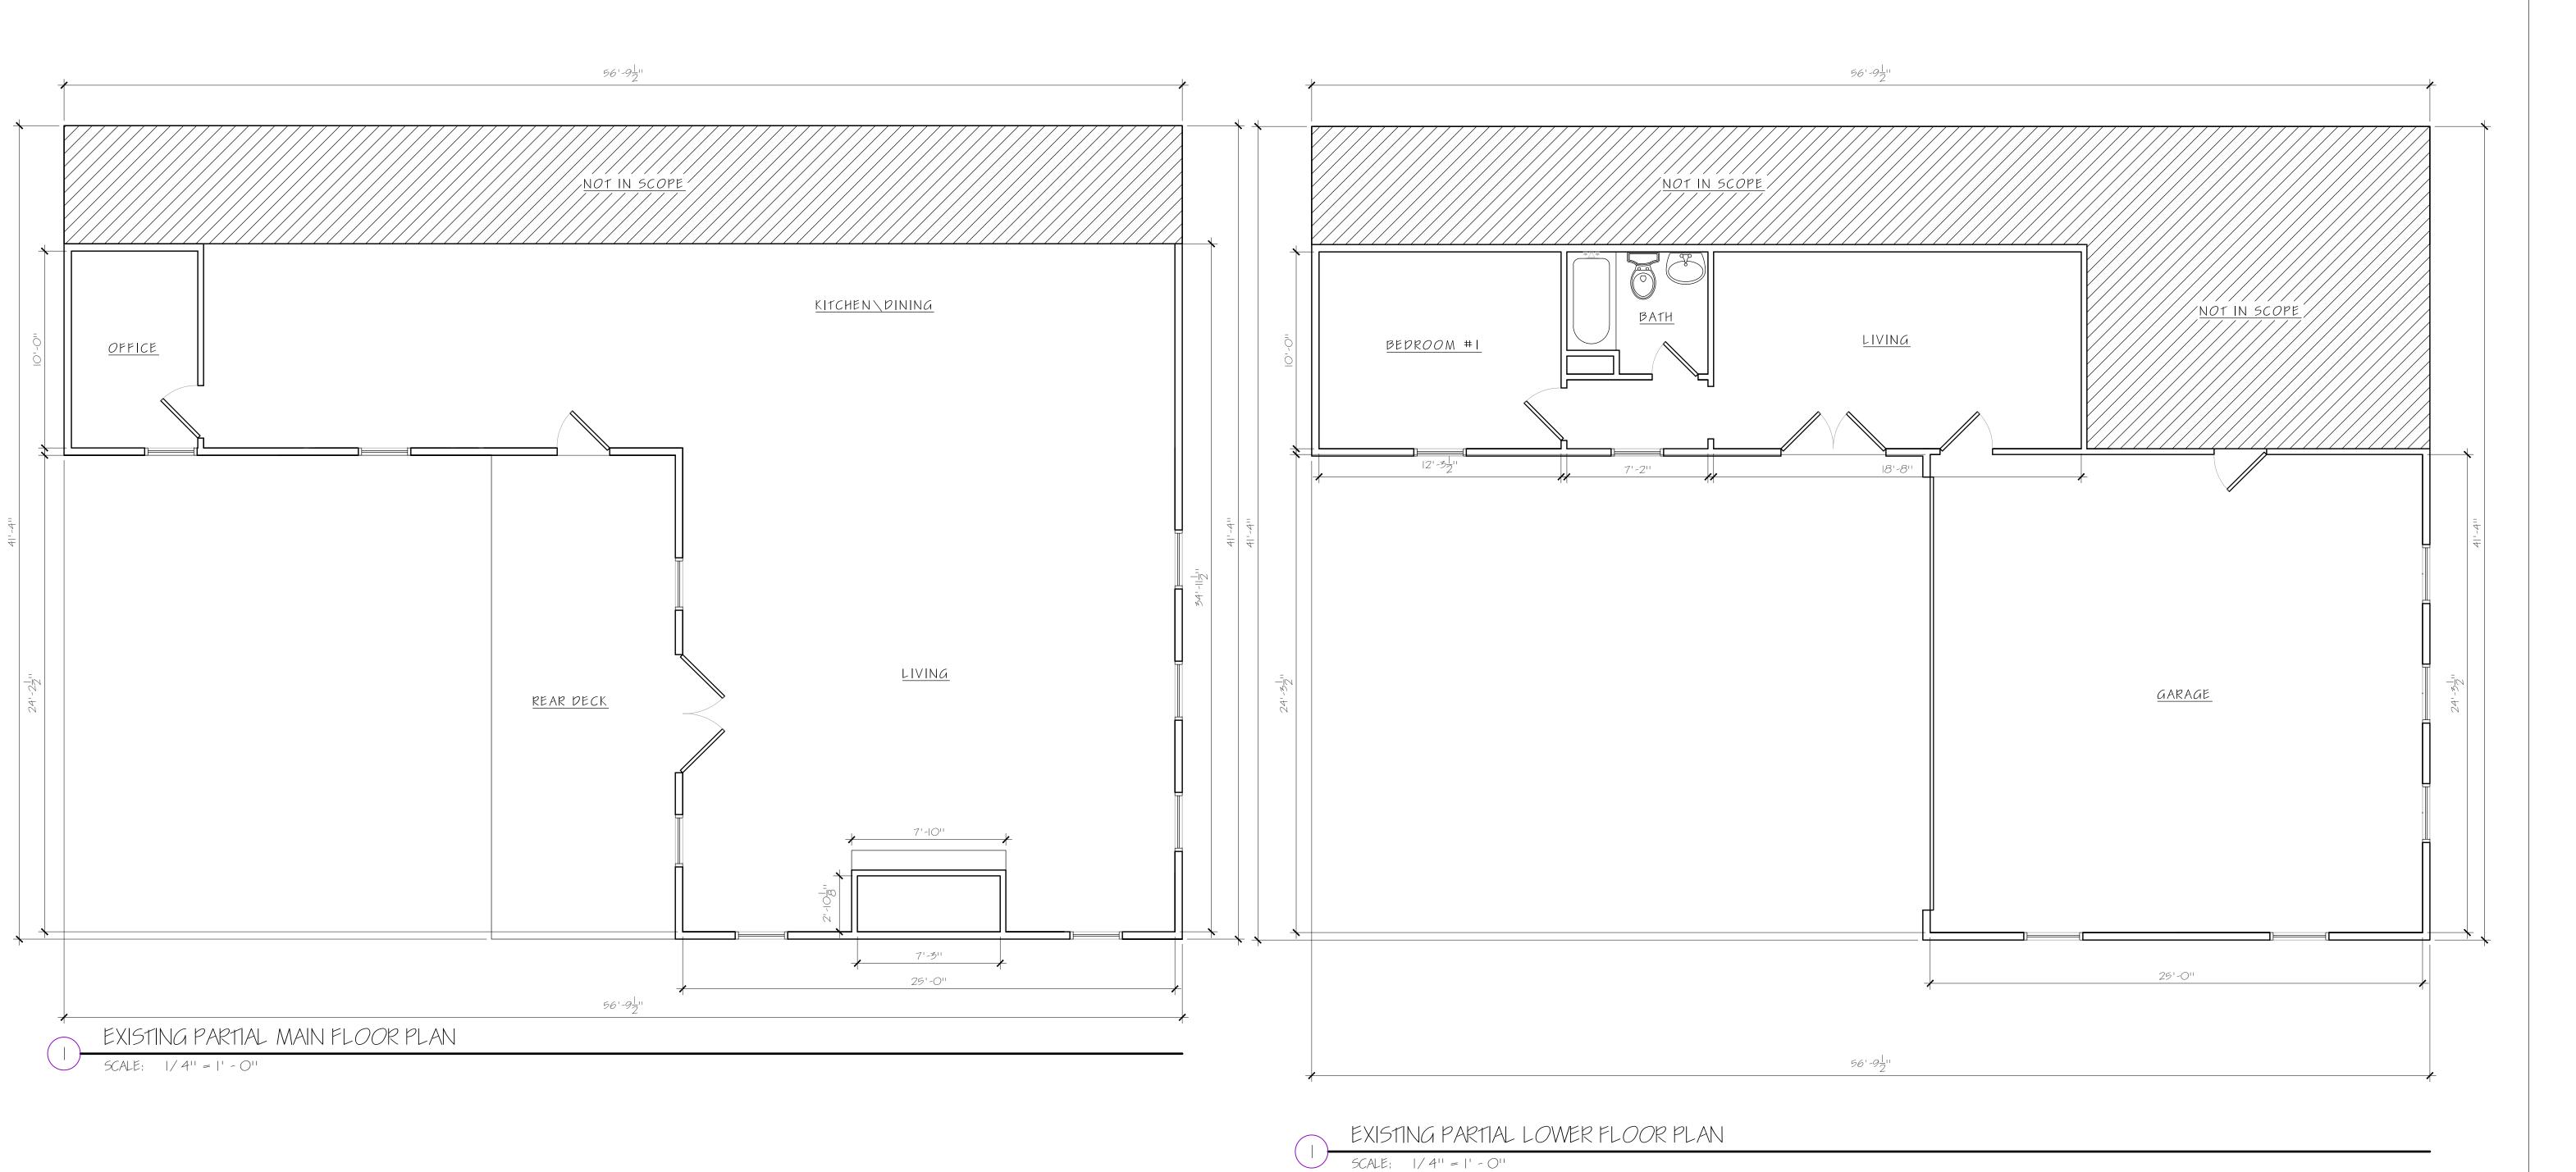
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SEPTEMBER 15, 2022 SHEET TITLE:

EXISTING

FOUNDATION PLAN





ENGINEER STAMP & SEAL:



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> REMODEL @ 500 5 WESTMINISTER WAY ATLANTA, GA 20207

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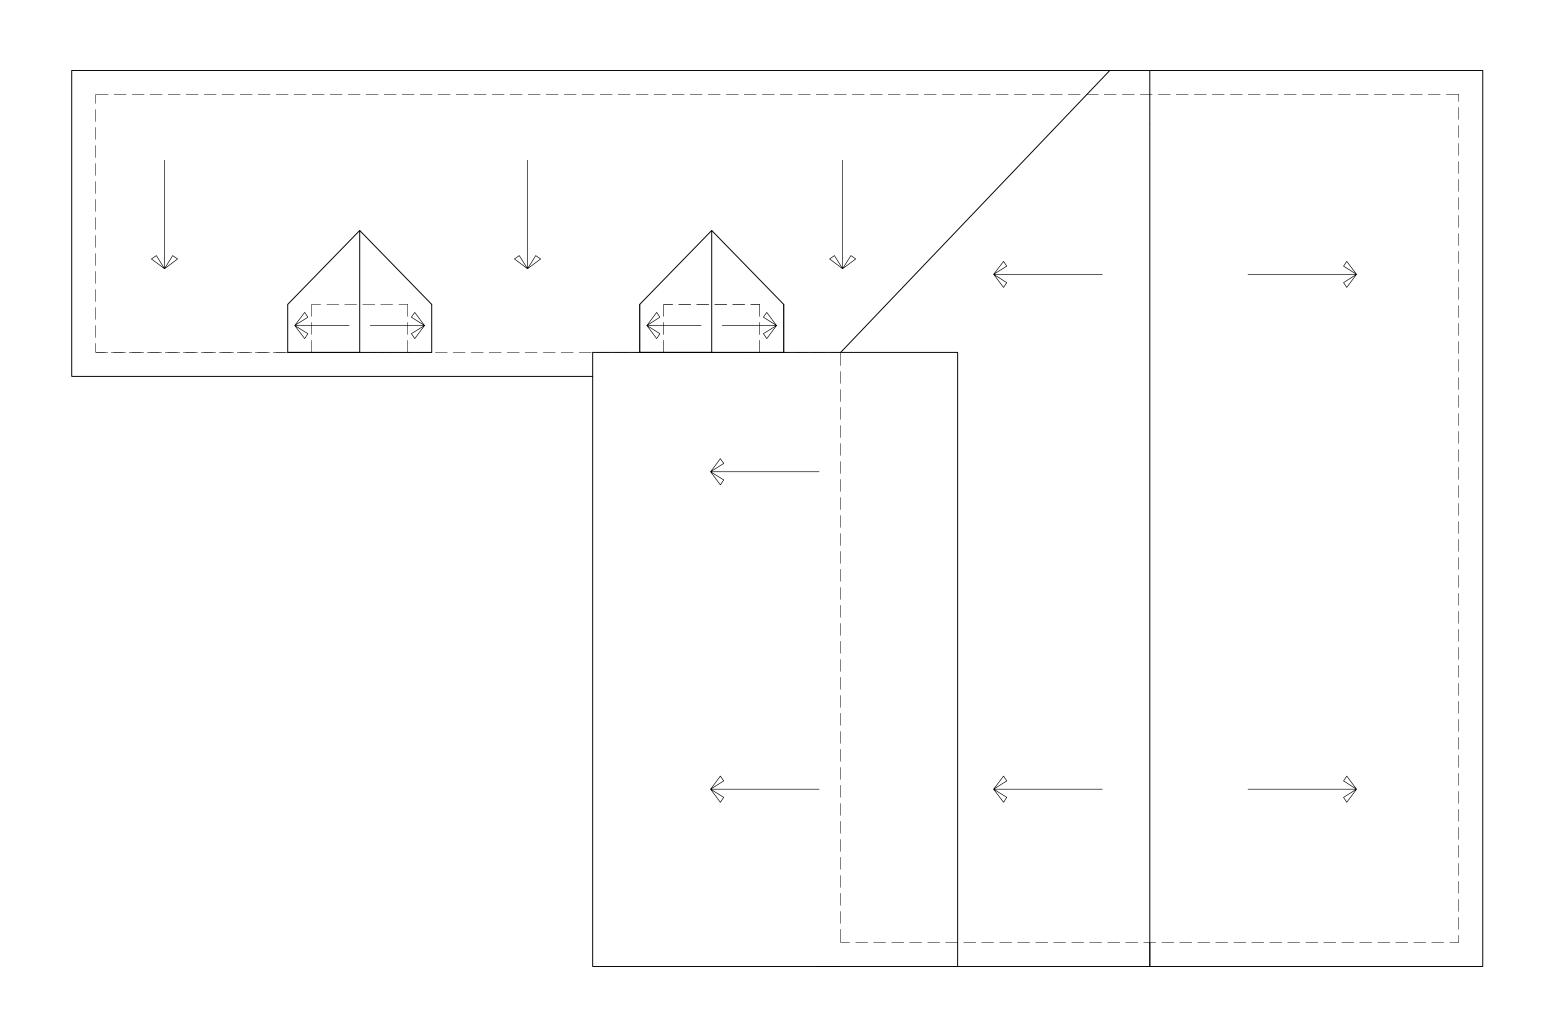
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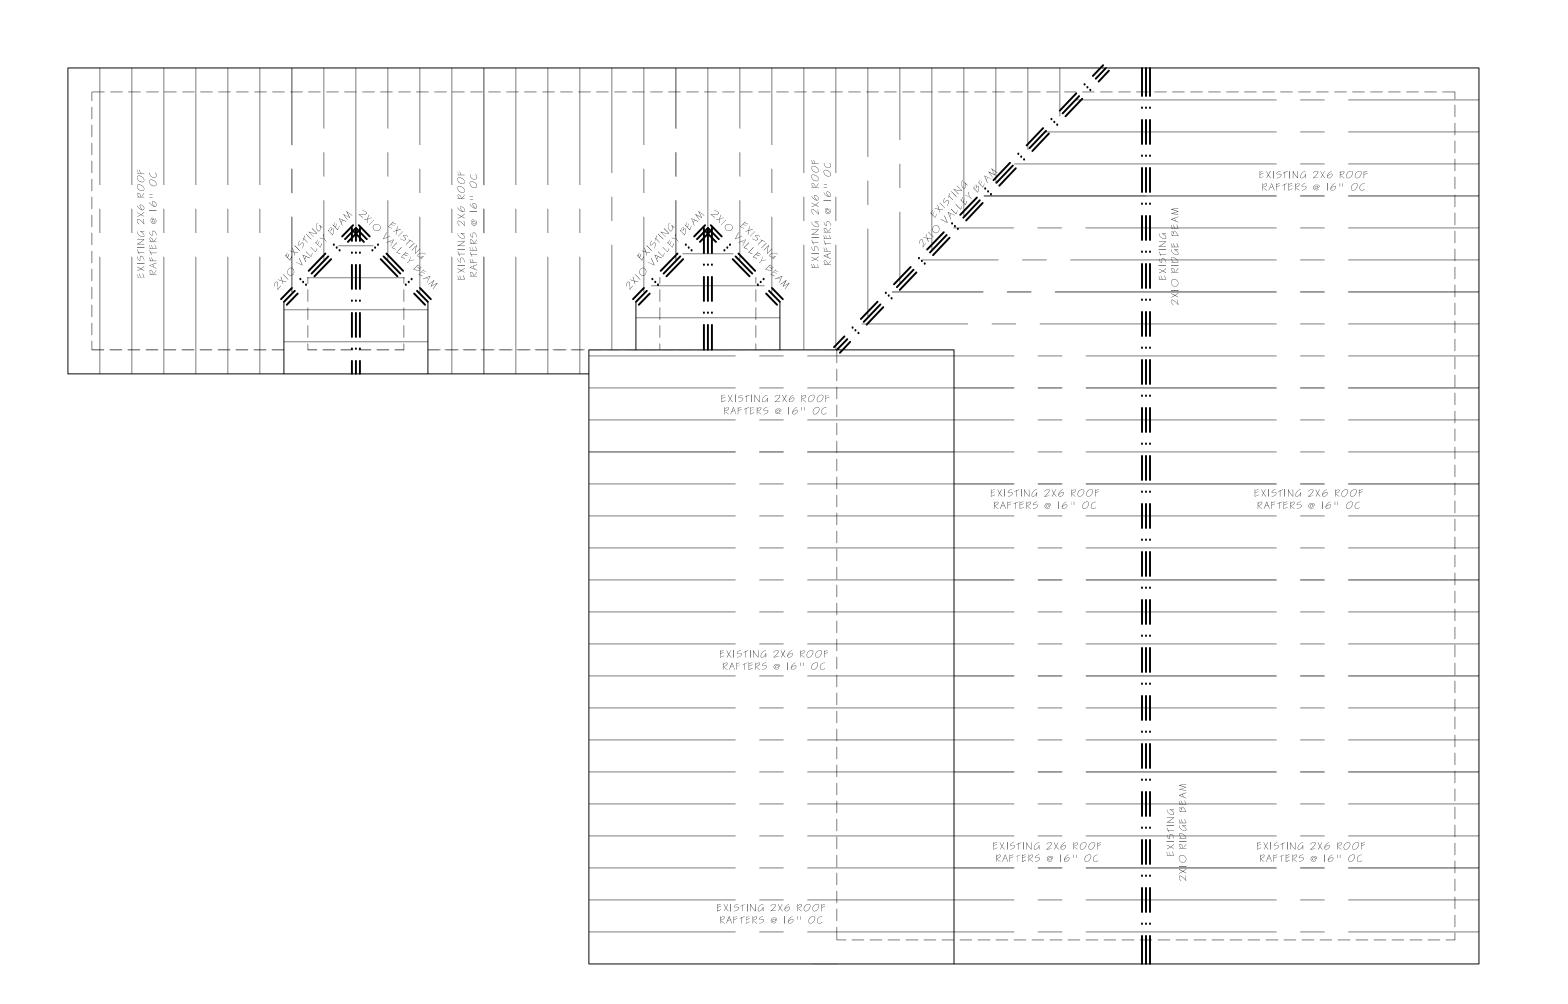
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SEPTEMBER 15, 2022 SHEET TITLE:

EXISTING FLOOR PLANS

A 7





EXISTING PARTIAL ROOF FRAMING PLAN

SCALE: 1/4" = 1'-0"

ENGINEER STAMP & SEAL



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REMOPEL 500 5 WESTMINIS ATLANTA, GA 30

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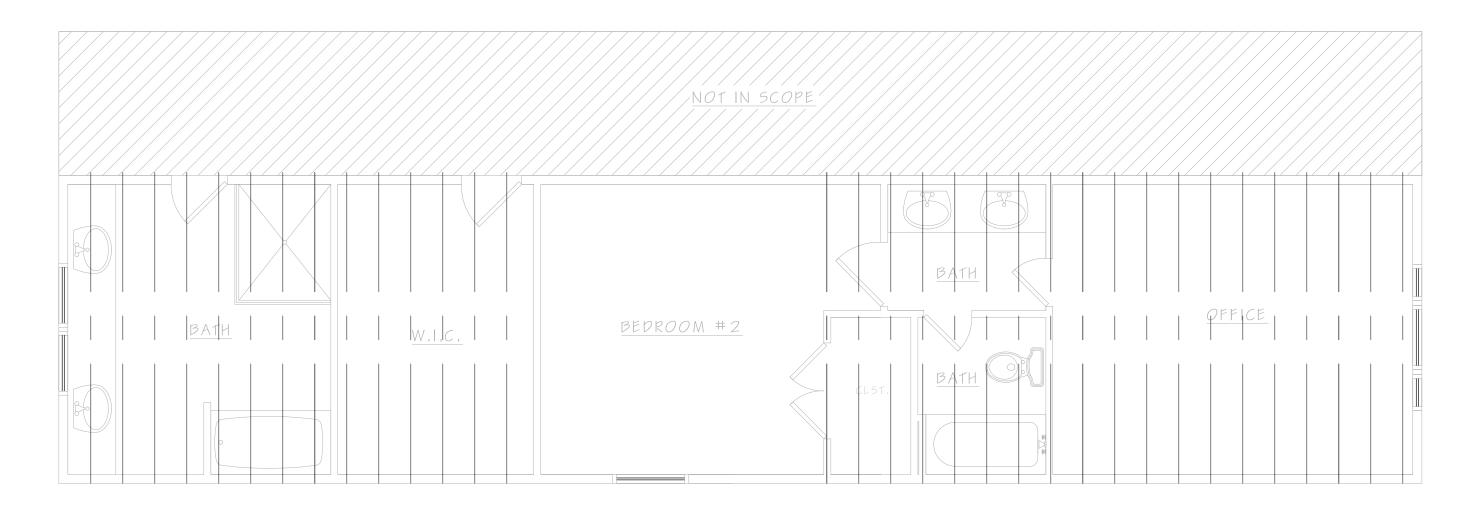
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SEPTEMBER 15, 2022 SHEET TITLE:


EXISTING ROOF & ROOF FRAMING PLAN






EXISTING PARTIAL UPPER FLOOR CEILING FRAMING PLAN

SCALE: 1/4" = 1' - 0"

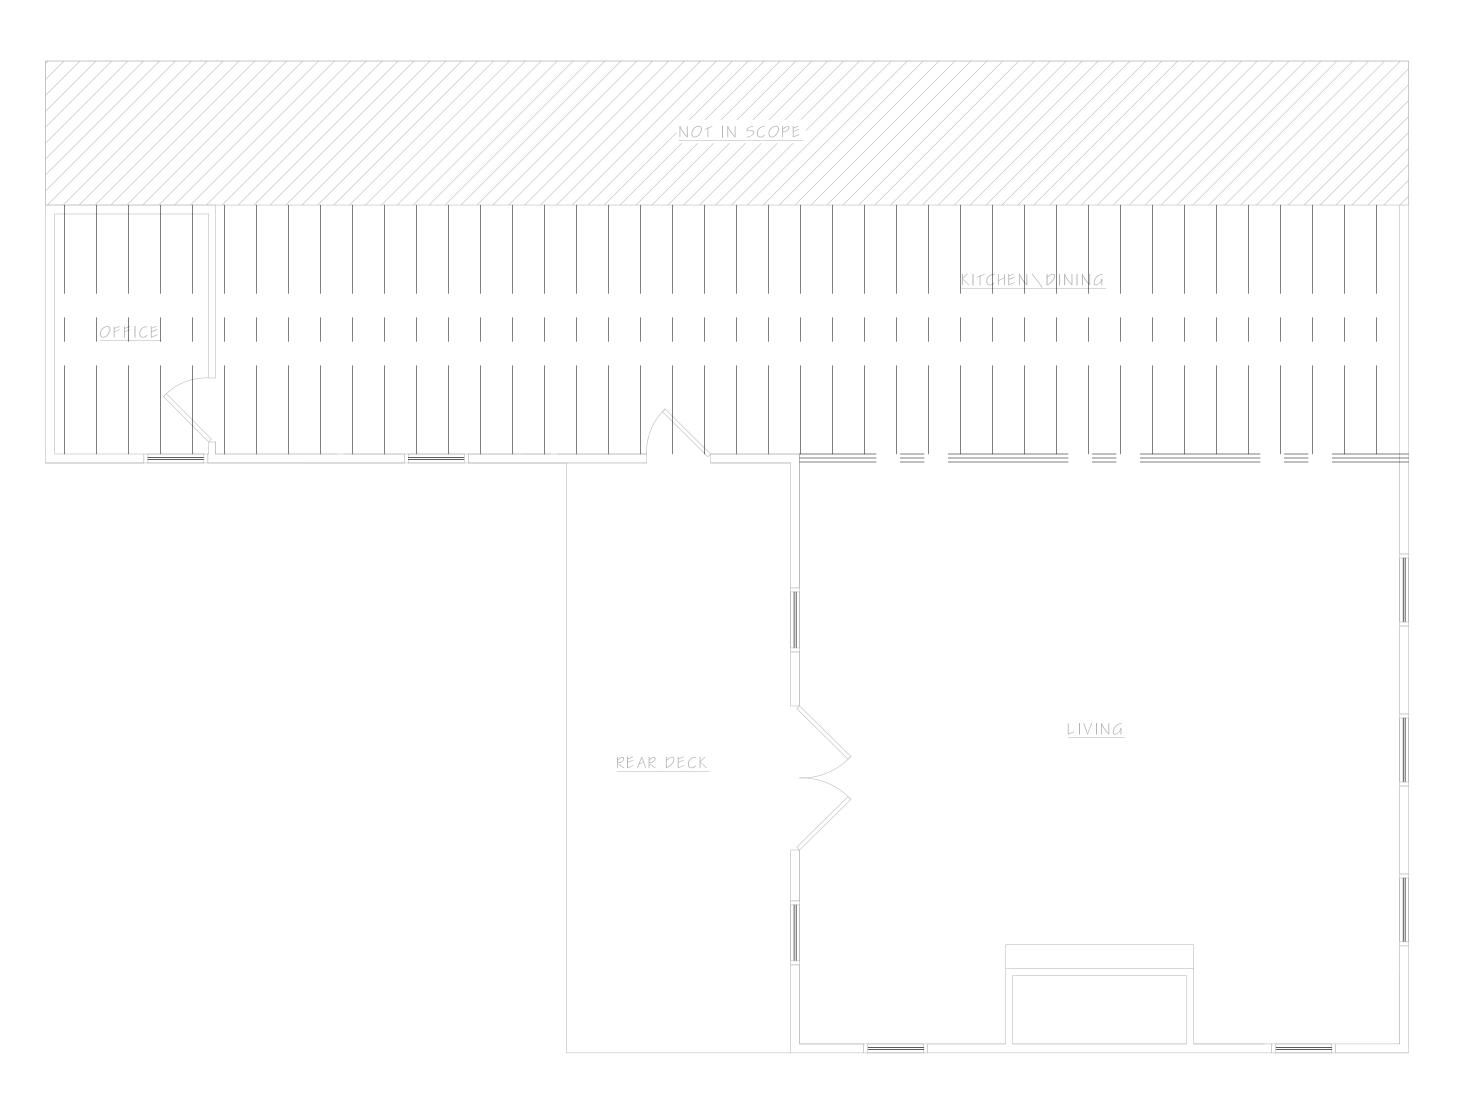

EXISTING PARTIAL MAIN FLOOR CEILING FRAMING PLAN

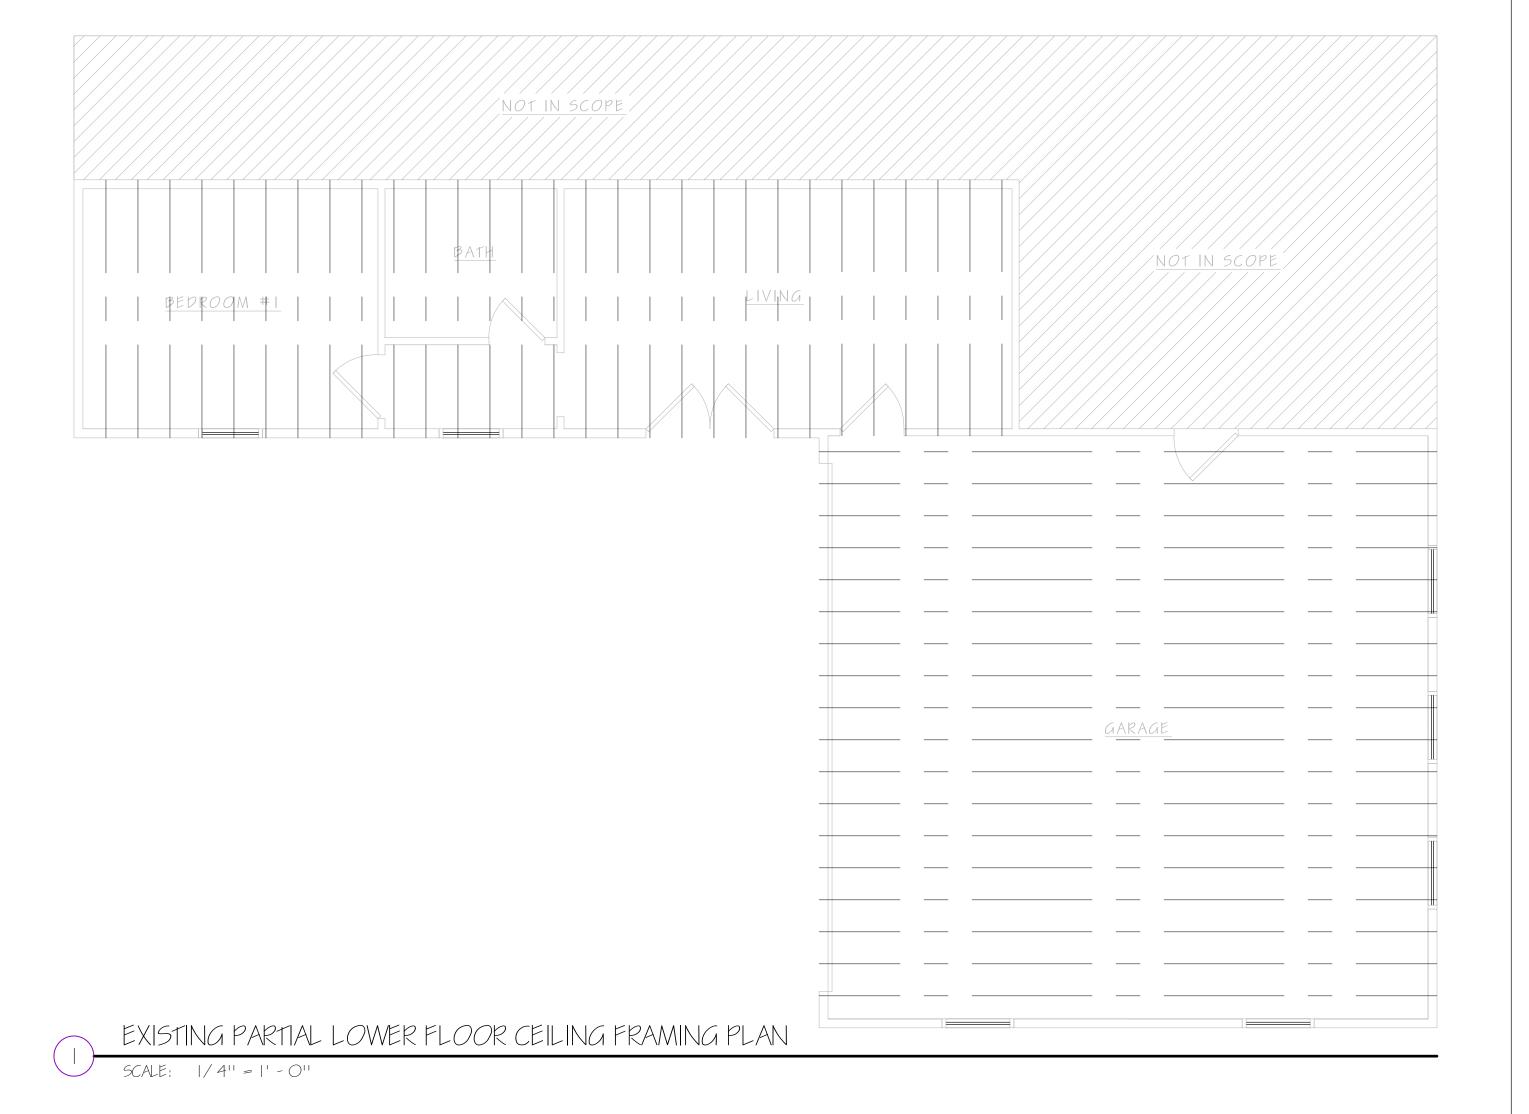

ENGINEER STAMP & SEAL



STUDIO TEN DESIGNS



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REMODEL @
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ATLANTA, GA 30307

PROJECT MANAGER


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SEPTEMBER 15, 2022 SHEET TITLE:

EXISTING CEILING FRAMING PLANS



ENGINEER STAMP & SEAL:

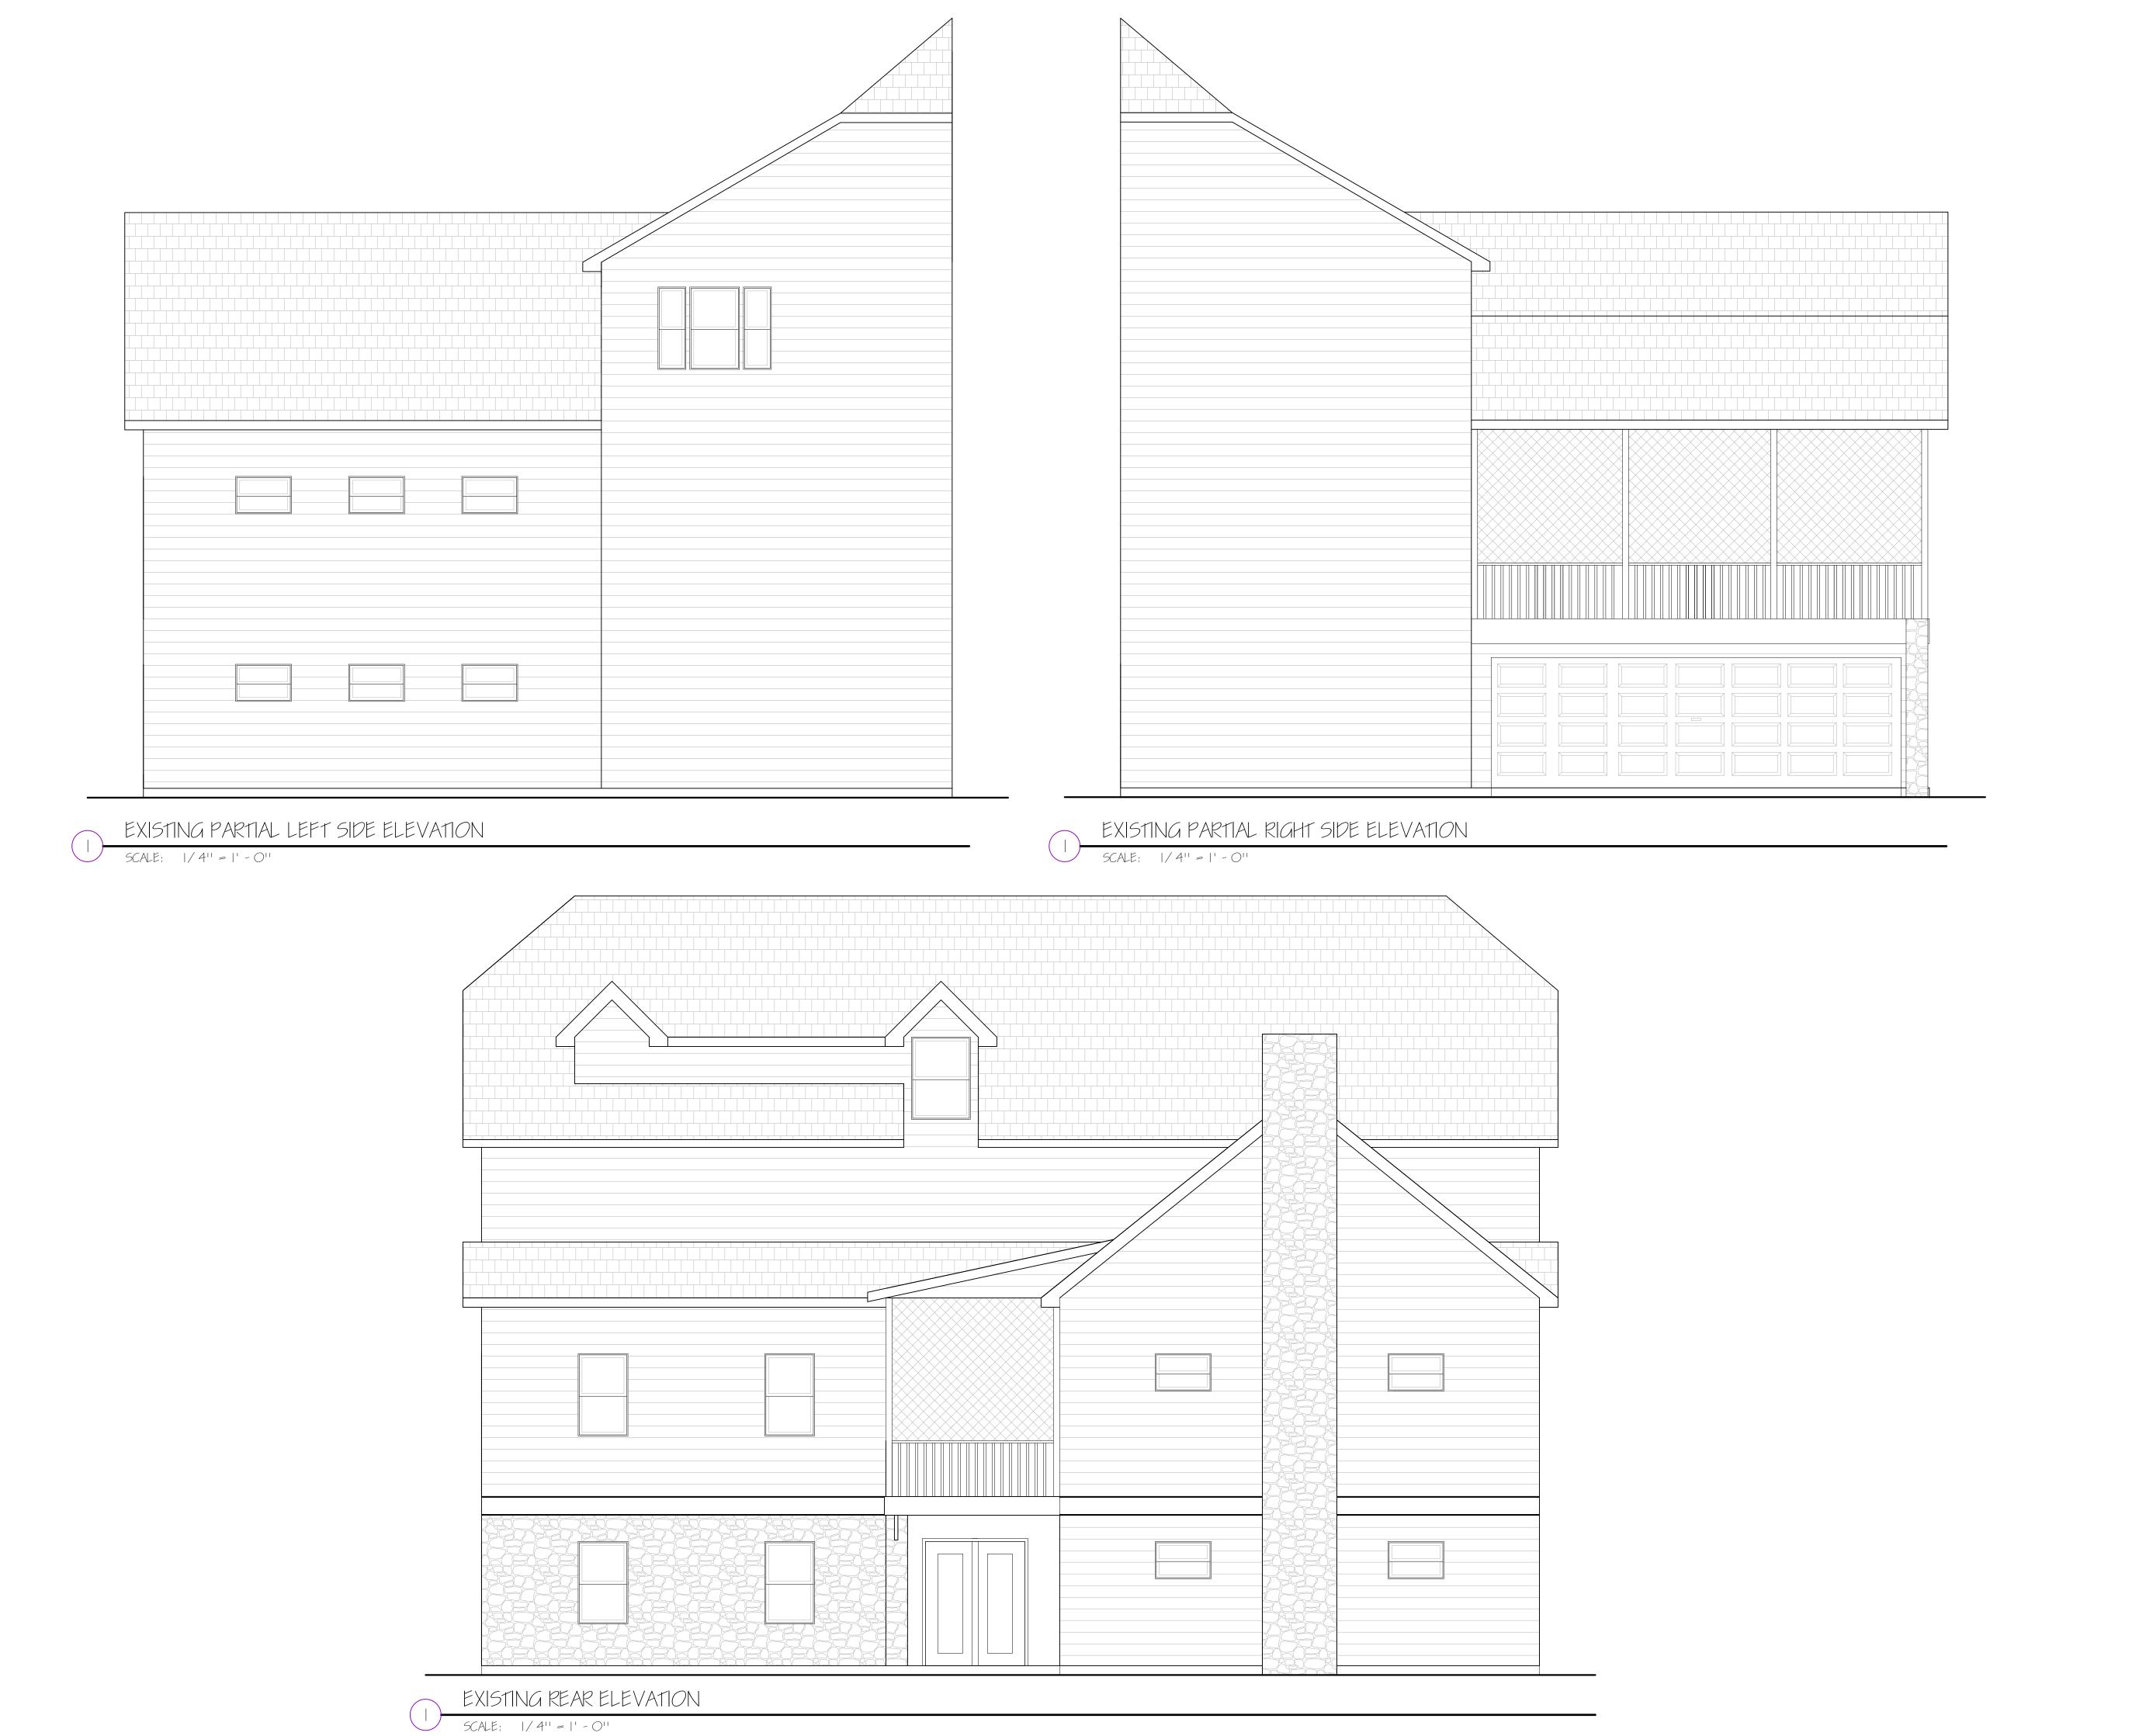

DRAWINGS BY:
STUDIO TEN DESIGNS



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PROJECT MANAGER

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SEPTEMBER 15, 2022 SHEET TITLE:

> EXISTING EXTERIOR ELEVATIONS



STUDIO TEN DESIGNS



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PROJECT MANAGER


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DOCUMENT PHASE:

RELEASED FOR CONSTRUCTION

SEPTEMBER 15, 2022 SHEET TITLE:

PROPOSED FOUNDATION PLAN

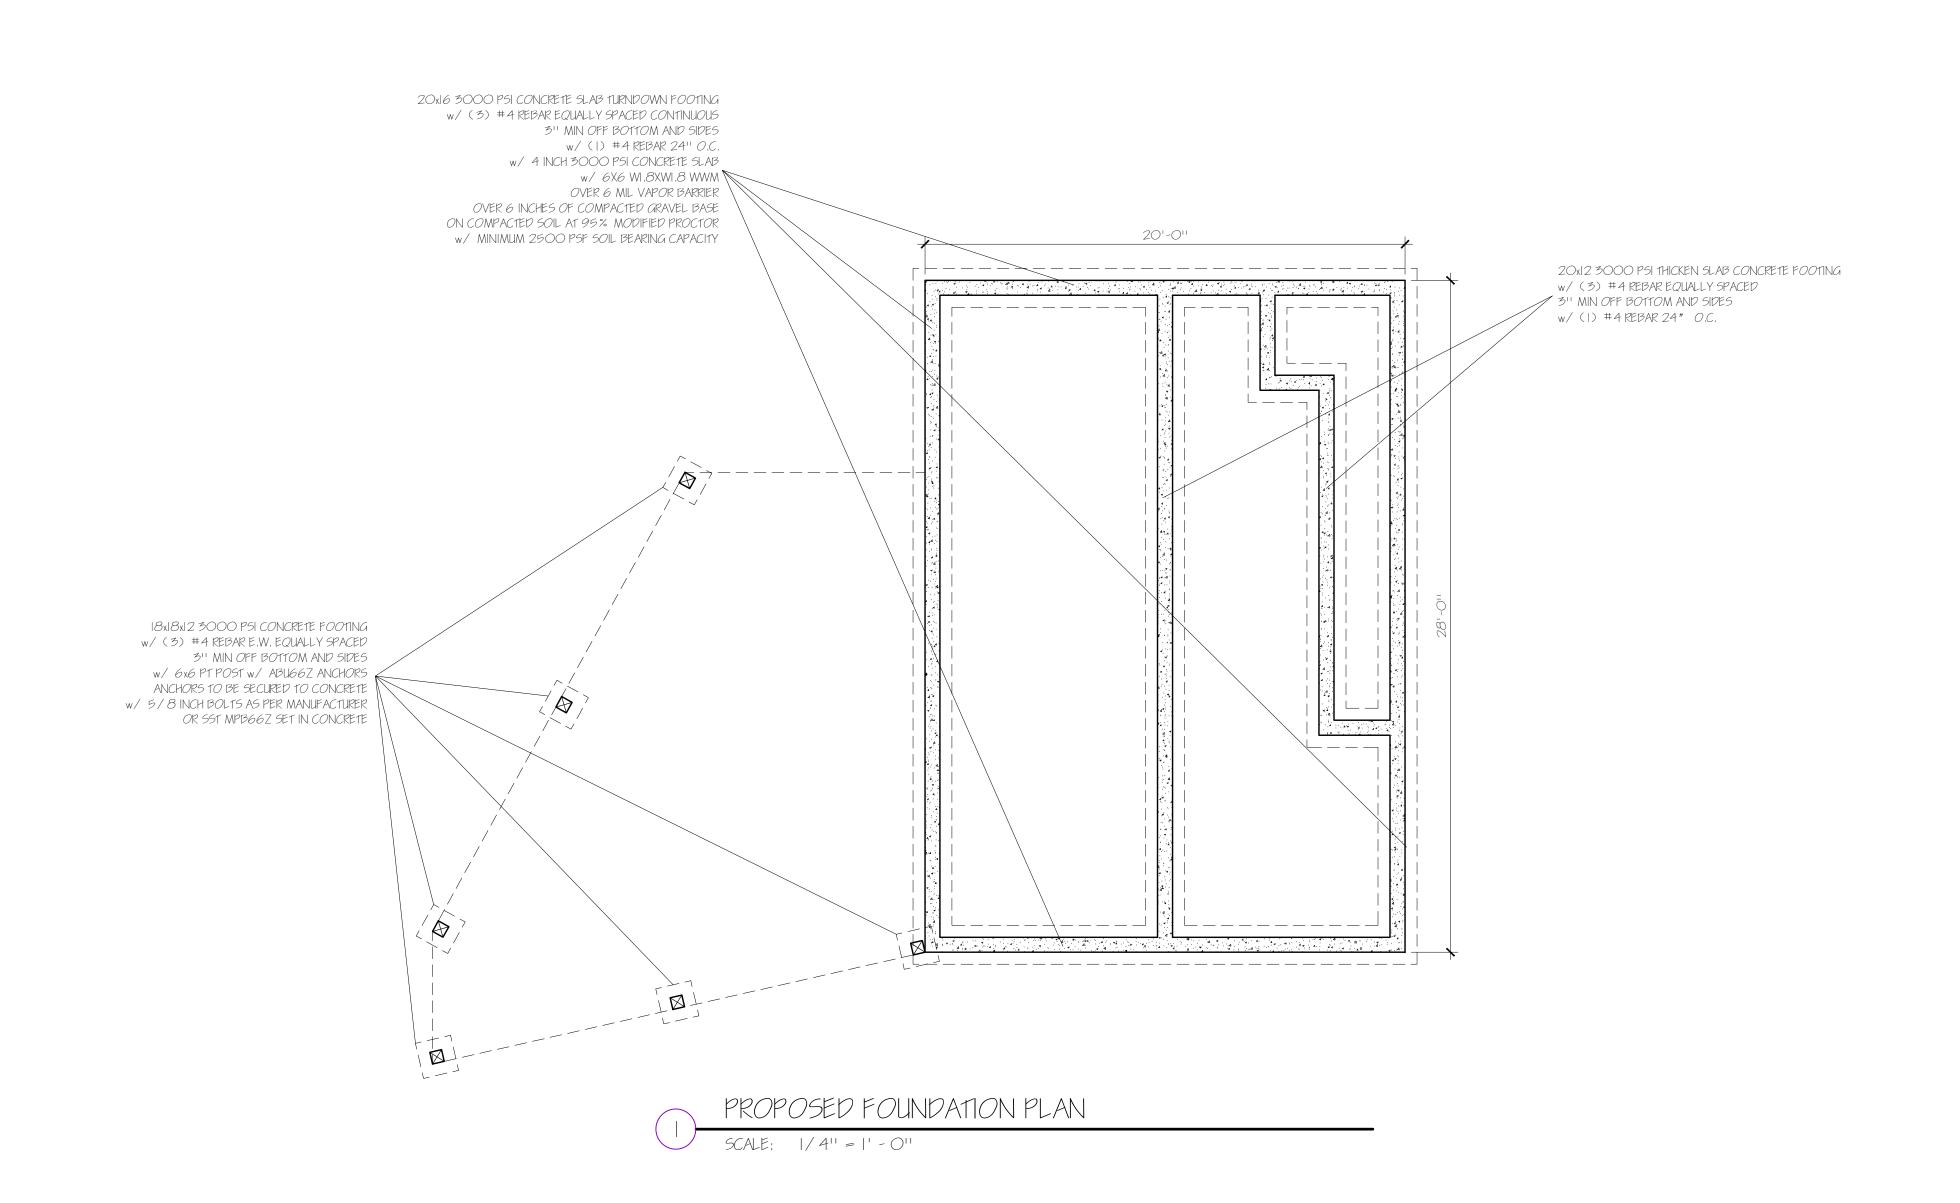

ENGINEER STAMP & SEAL



DRAWINGS BY:
STUDIO TEN DESIGNS



JASON ALBERT – 678,390,4655 JASON@STUDIOTENDESIGNS

PROJECT MANAGER

<u>DRAWN BY:</u> JASON ALBERT 678,390,4655 JASON@STUDIOTENDESIGNS.COM

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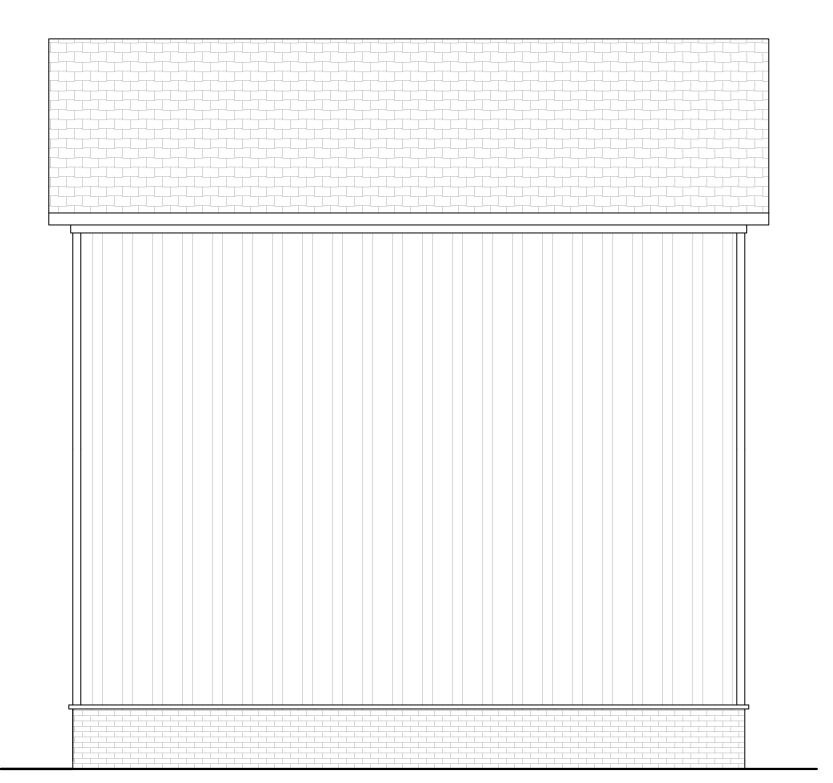
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SEPTEMBER 15, 2022 SHEET TITLE:

PROPOSED FLOOR PLANS



PROPOSED REAR ELEVATION



PROPOSED RIGHT SIDE ELEVATION

SCALE: 1/4" = 1'-0"



PROPOSED LEFT SIDE ELEVATION

SCALE: 1/4" = 1'-0"

ENGINEER STAMP & SEAL



DRAWINGS BY:
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PROJECT MANAGER


<u>DRAWN BY:</u> JASON ALBERT 678,390,4655 JASON@STUDIOTENDESIGNS.COM

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SEPTEMBER 15, 2022 SHEET TITLE:

PROPOSED EXTERIOR ELEVATIONS



PROPOSED ROOF PLAN

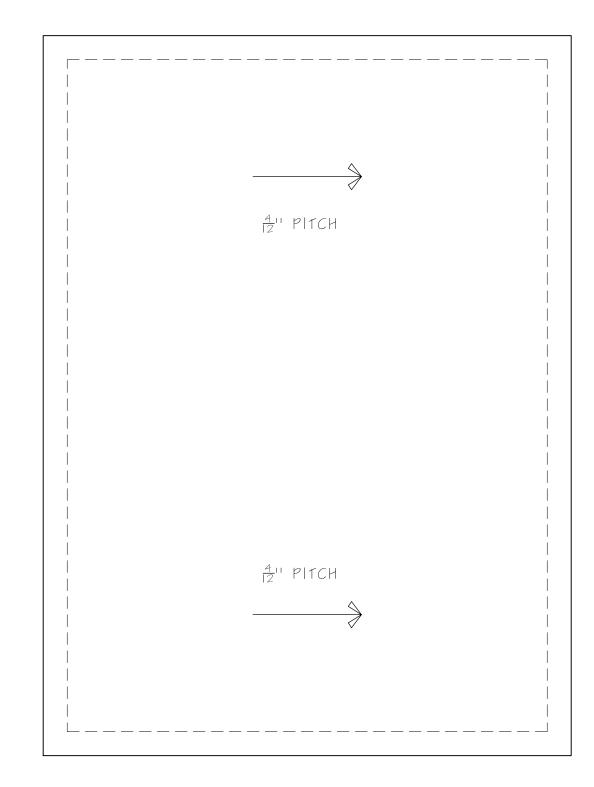SCALE: 1/4" = 1' - 0"

WIND DESIGN:

BASIC WIND SPEED, ULTIMATE

BASIC WIND SPEED, SERVICE

ENCLOSURE CLASSIFICATION

EXPOSURE

C

RISK CATEGORY II INTERNAL PRESSURE COEFFICIENT + 0.18

COMPONENTS & CLADDING

AREA ROOF (GROSS, PSF) SQ.FT ZONE I ZONE2 ZONE 3 ZONE 1,2 &3 10.00 - 28.8 -48.4 -72.8 +16.0 20.00 -28.1 -43.2 -60,3 +16.0 50.00 -27.1 -36.4 -43.8 + 16.0 100,00 -26.4 -31.3 -31.3 +16.0

WALLS (GROSS, PSF) AREA 5Q.FT ZONE 4 ZONE 5 ZONE 4&5 -35,2 + 26,4 10.00 20.00 -27.4 -32.8 + 25.2 -25.9 50,00 -29.7 + 23.7 100,00 -24.7 -27.4 + 22.5

EDGE DISTANCE, a = 3.2 FT.

SEISMIC DESIGN

RISK CATEGORY

SITE CLASS

IMPORTANCE FACTOR

SPECIAL RESPONSE ACCELERATION

SPECIAL RESPONSE COEFFICIENTS

SPECTRAL RESPONSE COEFFICIENTS

SEISMIC DESIGN CATEGORY

RESPONSE MODIFICATION FACTOR (R)

(INTERMEDIATE

RESPONSE MODIFICATION FACTOR (R) (INTERMEDIATE REINFORCED MASONRY SHEAR WALLS)

6.5 (LIGHT FRAME WOOD WALLS WITH STRUCTURAL WOOD SHEAR

PANELS)

SOIL BEARING CAPACITY 1500 PSF (ASSUME)

LIVE LOADS

ROOF 20 PSF (WITH

TRIBUTARY REDUCTIONS PER CODE)

STAIRS AND LANDINGS

HANDRAIL / GUARD RAIL

CONTROLLING OF 50

PLF OR 200 LB, POINT LOAD

LOCATED TO CAUSE

MAXIMUM STRESS

MATERIALS
POST-INSTALLED ANCHOR RODS
ASTM A 193 GRADE B7

W/COATING AS SPECIFIED IN ESR-2262 OR ESR-2322

CONCRETE (28 DAYS)

FOOTINGS
WEAR SLAB/SLAB-ON-GRADE
ALL OTHER CONCRETE
REINFORCING STEEL
HEADED STUDS
WELDED WIRE FABRIC
ADHESIVE ANCHORING
ADDOC PSI
3000 PSI
3000 PSI
4000 PS

ADHESIVE ANCHORING HILTI HIT-RE 500-V3
ADHESIVE ANCHOR SYSTEM (ICC ESR-3814)

PHESIVE ANCHOR SYSTEM (ICC ESR-3814)
HILTI HIT-HY 70

ADHESIVE ANCHOE SYSTEM FOE CMU (ICC ESR 2682)

ENGINEER STAMP & SEAL



STUDIO TEN DESIGNS



JASON ALBERT - 678,390,4655 JASON@STUDIOTENDESIGNS

FEMICIFE @
500 S WESTMINISTER WAY
ATLANTA, GA 20207

PROJECT MANAGER

<u>PRAWN BY:</u> JASON ALBERT 678,390,4655 JASON@STUDIOTENDESIGNS.COM


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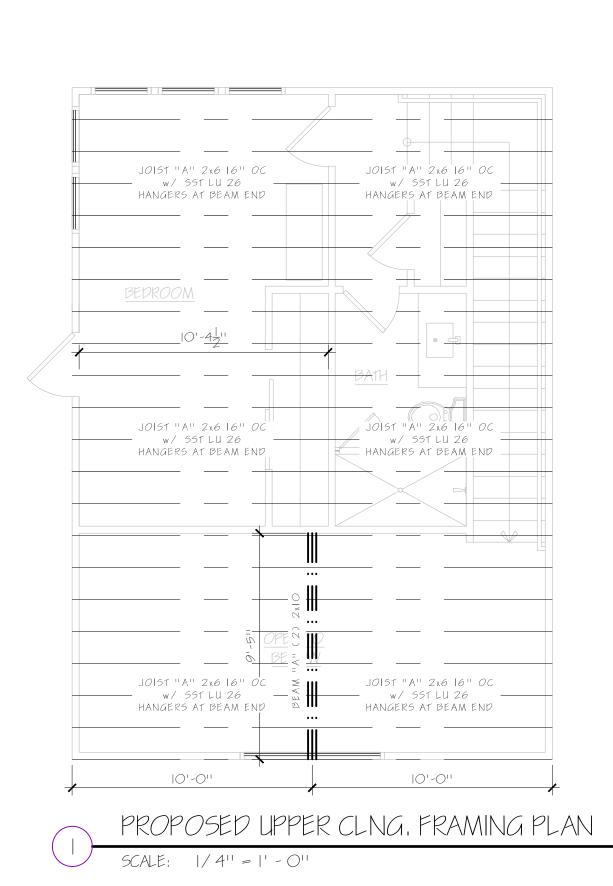
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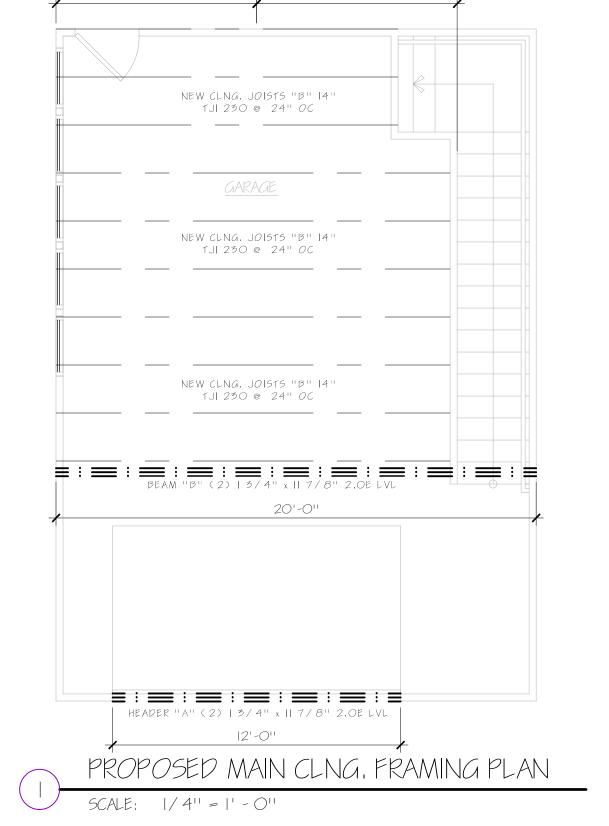
> PROPOSED ROOF PLAN





PROPOSED ROOF FRAMING PLAN



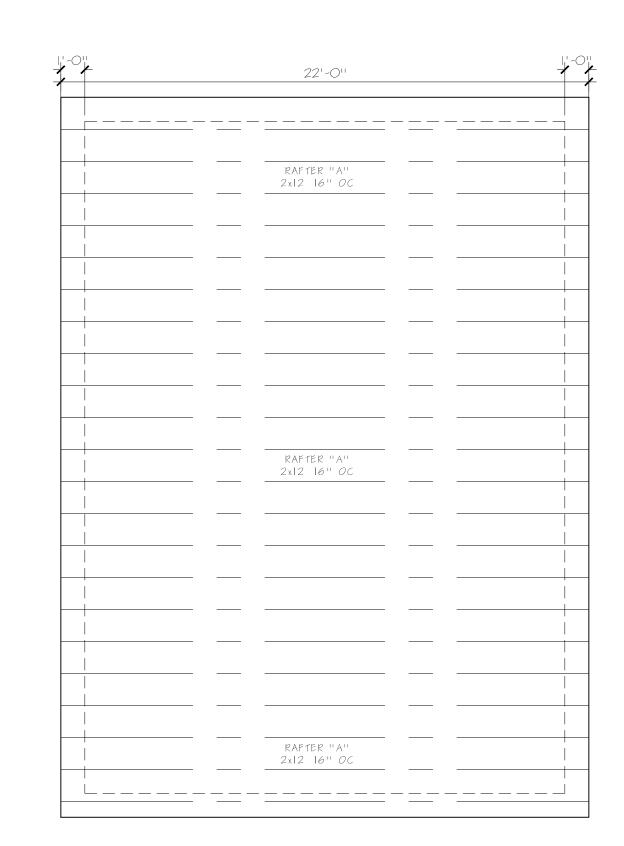

8'-4|''

8'-4<u>|</u>''

ENGINEER STAMP & SEAL



STUDIO TEN DESIGNS



JASON ALBERT - 678,390,4655 JASON@STUDIOTENDESIGNS

PROJECT MANAGER

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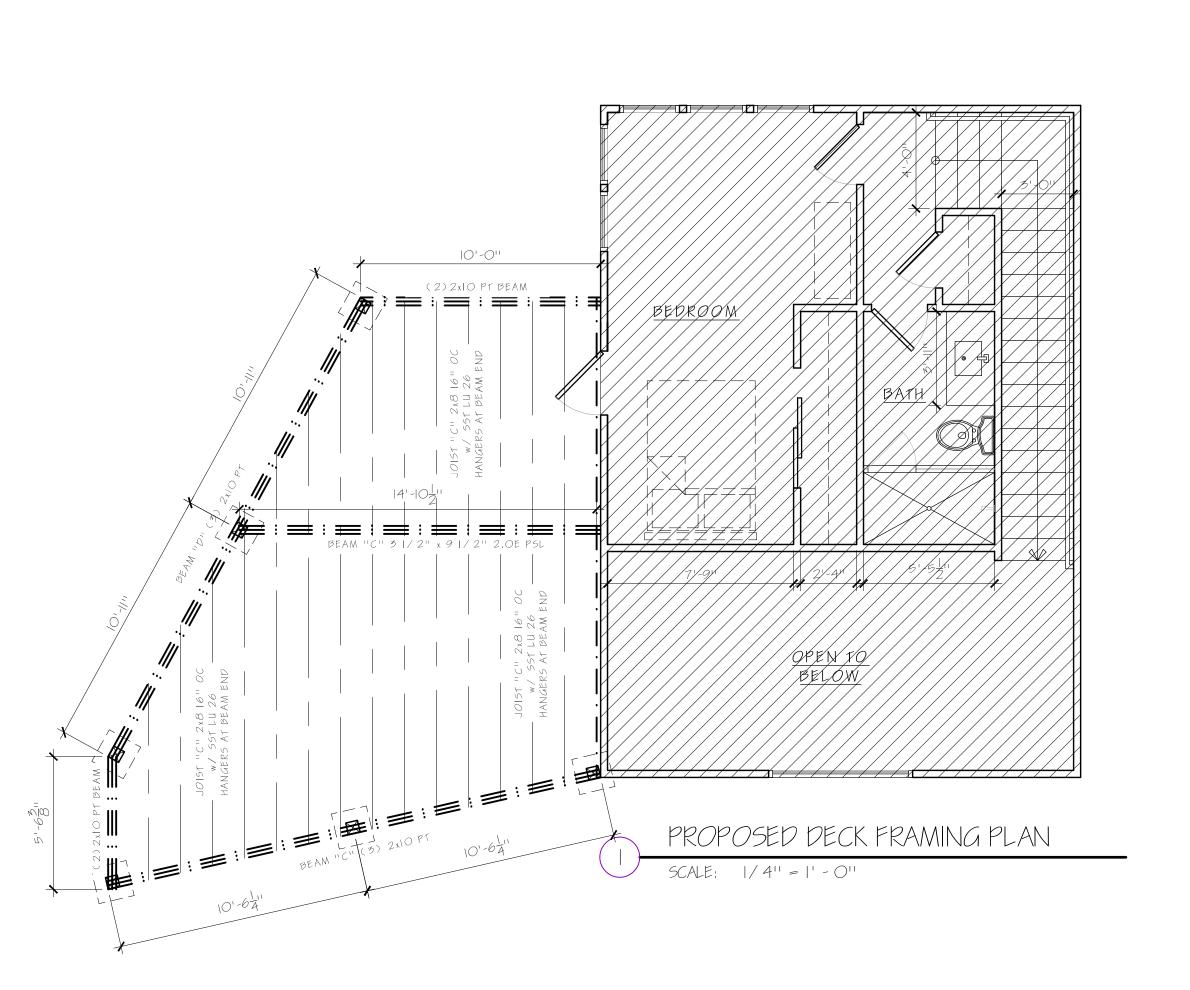
SEPTEMBER 15, 2022 SHEET TITLE: PROPOSED


FRAMING PLANS




GENERAL REQUIREMENTS FOR DECK:

- I. LUMBER SHALL BE NATURALLY DURABLE WOOD OR SHALL BE SOUTHERN PINE, GRADE #2 OR BETTER THAT IS PRESSUREPRESERVATIVE-TREATED
- IN ACCORDANCE WITH AWPA UL FOR THE SPECIES, PRODUCT, PRESERVATIVE AND END USE.
- FIELD CUT ENDS, NOTCHES AND DRILLED HOLES OF PRESERVATIVE TREATED WOOD SHALL BE TREATED IN THE FIELD IN ACCORDANCE WITH AWPA MA, PRESERVATIVE TREATED LUMBER IN CONTACT WITH THE GROUND SHALL BE RATED AS "GROUND-CONTACT," PLEASE NOTE: NOT ALL TREATED LUMBER IS RATED FOR GROUND CONTACT.
- 2. WOOD-PLASTIC COMPOSITES ARE COMPOSED OF BOUND WOOD AND PLASTIC FIBERS CREATING MATERIAL THAT CAN BE USED AS DECKING AND GUARD ELEMENTS AS PERMITTED HEREIN. PERMISSIBLE WOOD-PLASTIC COMPOSITES MUST BEAR A LABEL INDICATING ITS PERFORMANCE CRITERIA AND COMPLIANCE WITH ASTM D 7032.
- 3. NAILS SHALL BE RING-SHANKED OR ANNULAR GROOVED.
- 4. SCREWS AND NAILS SHALL BE HOT-DIPPED GALVANIZED, STAINLESS STEEL OR APPROVED FOR USE WITH PRESSURE TREATED LUMBER.
- 5. HARDWARE, E.G., JOIST HANGERS, CAST-IN-PLACE POST ANCHORS, MECHANICAL FASTENERS, SHALL BE GALVANIZED WITH 1.85 OZ/SF OF ZINC (G-185 COATING) OR SHALL BE STAINLESS STEEL. USE PRODUCTS SUCH AS "ZMAX" FROM SIMPSON STRONG-TIE OR "TRIPLE ZINC" AND "GOLD COAT" FROM USP.
- 6. ELECTRICAL RECEPTACLES FOR DECKS SHALL COMPLY WITH THE CURRENTLY APPROVED EDITION OF THE NATIONAL ELECTRICAL CODE.
- 7. LIGHTING FOR DECKS AND EXTERIOR STAIRS SHALL COMPLY WITH IRC 303.7 STAIRWAY ILLUMINATION.
- 8. DECKS CONSTRUCTED IN ACCORDANCE WITH THESE DETAILS ARE NOT APPROVED FOR PRIVACY SCREENS, PLANTERS, BUILT-IN SEATING OR HOT TUB INSTALLATIONS.



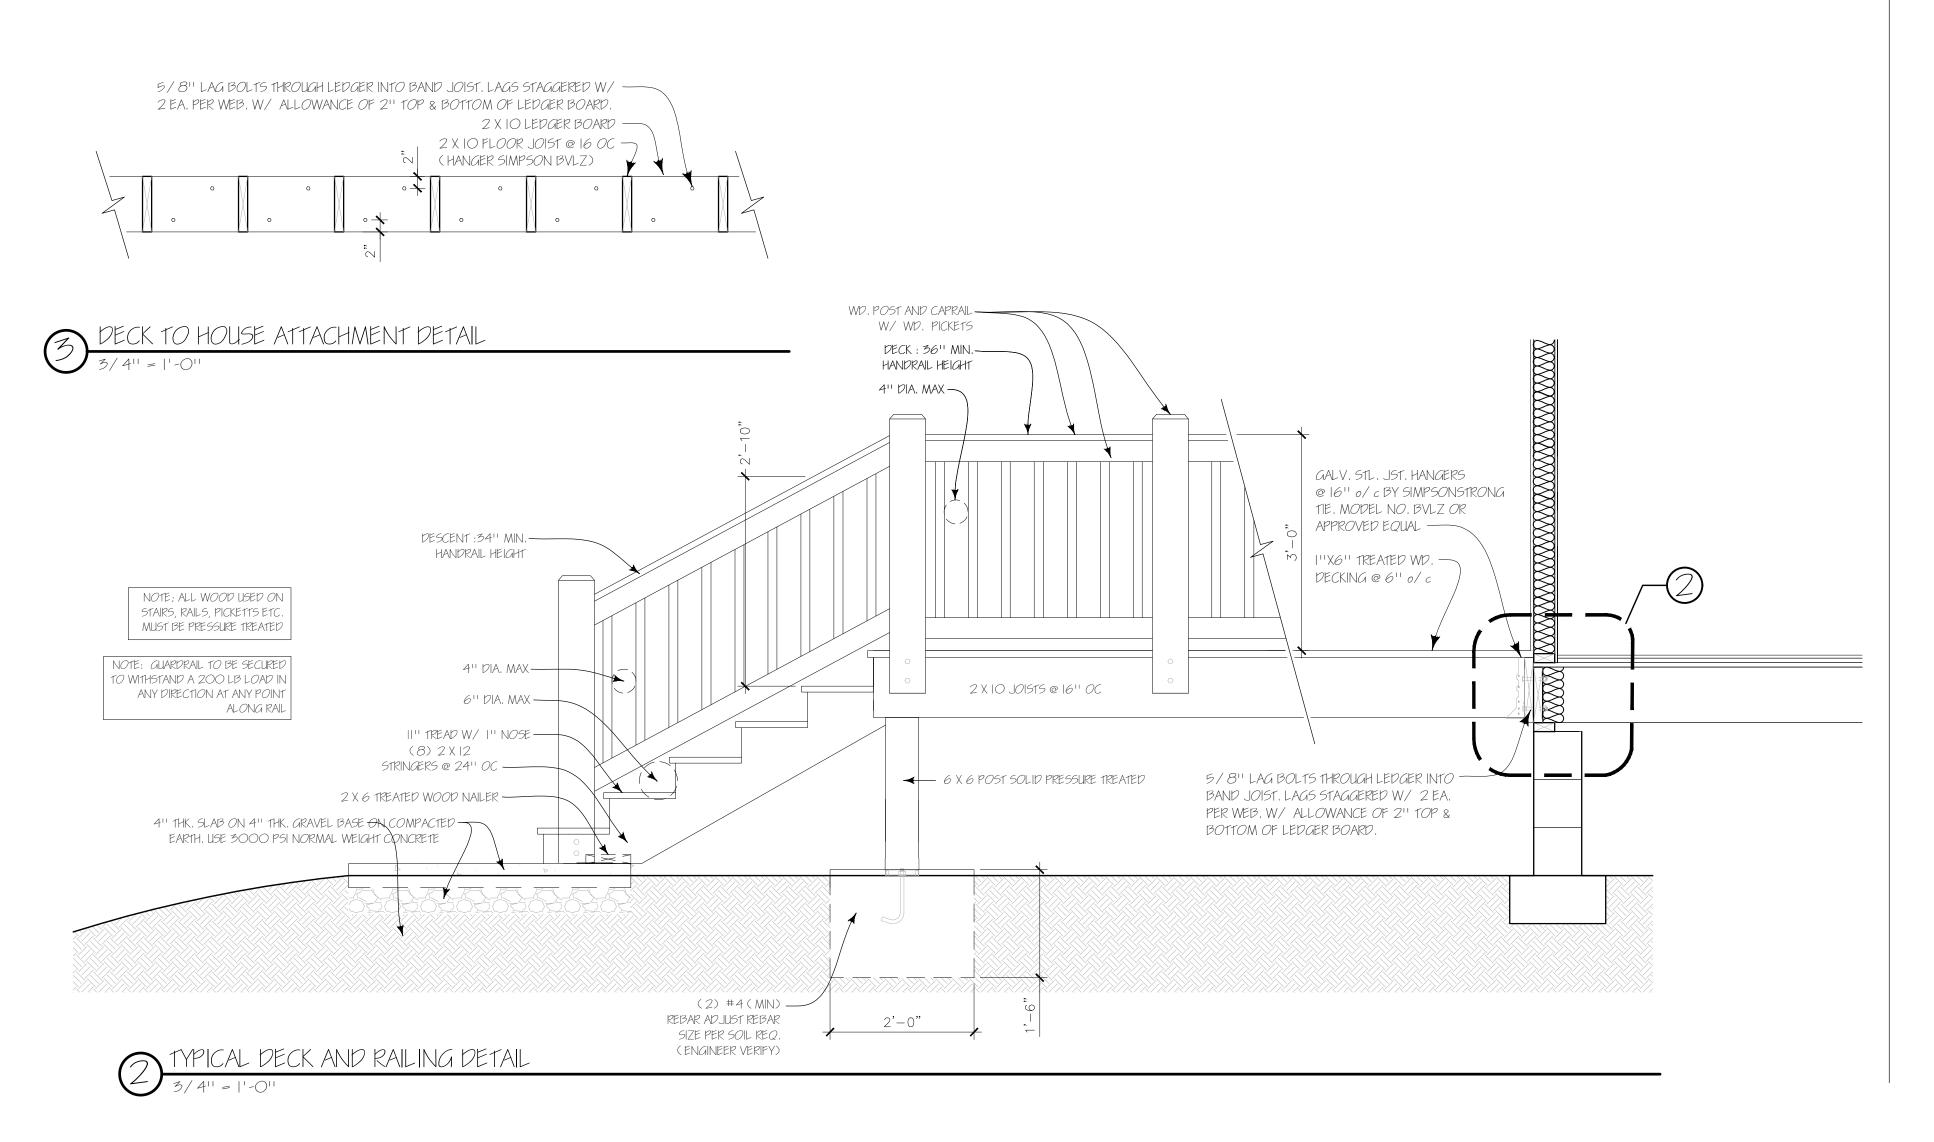

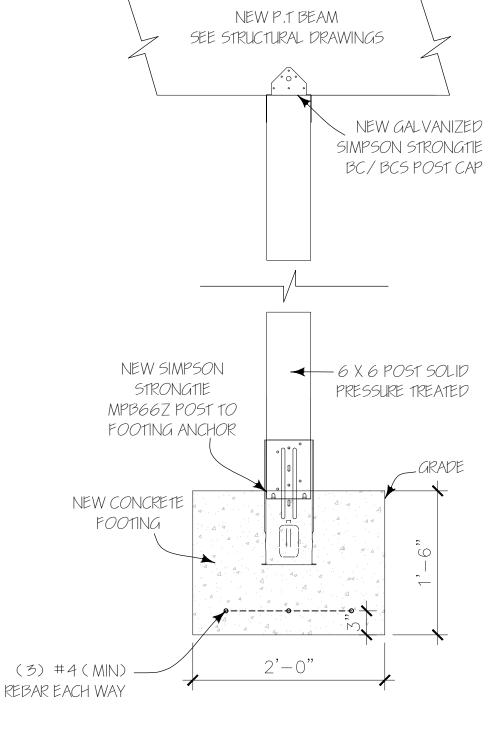

POST TO BEAM CONNECTION DETAIL

ENGINEER STAMP & SEAL



STUDIO TEN DESIGNS



JASON ALBERT - 678,390,4655 JASON@STUDIOTENDESIGNS

SOO S WESTMINISTER WAY ATLANTA, GA 20207

PROJECT MANAGER

<u>DRAWN BY:</u> JASON ALBERT 678,390,4655

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SEPTEMBER 15, 2022 SHEET TITLE:

PROPOSED DECK FRAMING PLAN

 $A \parallel$

ENGINEER DATA

WIND DESIGN: BASIC WIND SPEED, ULTIMATE

EXPOSURE

90 MPH ENCLOSED BUILDING

RISK CATEGORY INTERNAL PRESSURE COEFFICIENT + 0.18

COMPONENTS & CLADDING

BASIC WIND SPEED, SERVICE ENCLOSURE CLASSIFICATION

ROOF (GROSS, PSF) AREA 5Q.FT ZONE I ZONE2 ZONE 3 ZONE 1,2 &3 - 28.8 -48.4 -72.8 +16.0 -28.1 -43.2 -60.3 +16.0 -27,1 -36,4 -43,8 +16,0 -26,4 -31,3 -31,3 +16,0


WALLS (GROSS, PSF) ZONE 4 ZONE 5 ZONE 4&5 -28,6 -35,2 +26,4 20.00 -27.4 -32.8 + 25.2 50.00 -25.9 -29.7 +23.7 100.00 -24.7 -27.4 +22.5


EDGE DISTANCE, a = 3.2 FT.


SEISMIC DESIGN:	
RISK CATEGORY	
SITE CLASS	
IMPORTANCE FACTOR	
SPECIAL RESPONSE ACCELERATION	Ss = 0.1798
	51 = 0.0898
SPECTRAL RESPONSE COEFFICIENT	505 = 0.1918
	501 = 0.1428
SEIGNIC HESIGNI CATEGODY	13

DOOR SCHEDLLE FIELD VERIFY ALL OPENINGS BEFORE ORDERING WINDOWS OR DOORS						
	<u>Q1Y.</u>	<u>NO.</u>	<u>1YPE</u>	<u>NOTES</u>		
	1	3'-0" x 8'-0"	EXTERIOR TEMPERED/INSUL. GLASS			
2	1	2'-8'' x 7'-0''	EXTERIOR TEMPERED/INSUL. GLASS			
3	3	2'-6" x 7'-0"	INTERIOR HOLLOW CORE MASONITE			
4	-	(2)2'-6" x7'-0"	INTERIOR HOLLOW CORE MASONITE			
9	I	12'-0'' x 8'-0''	EXTERIOR GARAGE DOOR			

	WINDOW SCHEDULE FIELD VERIFY ALL OPENINGS BEFORE ORDERING WINDOWS OR DOORS									
	QTY. NO. TYPE NOTES									
(WI)	10	2'-6" x 5'-0"	CASEMENT							
(W2)	I	6'-0" x 6'-0"	FIXED GLASS							

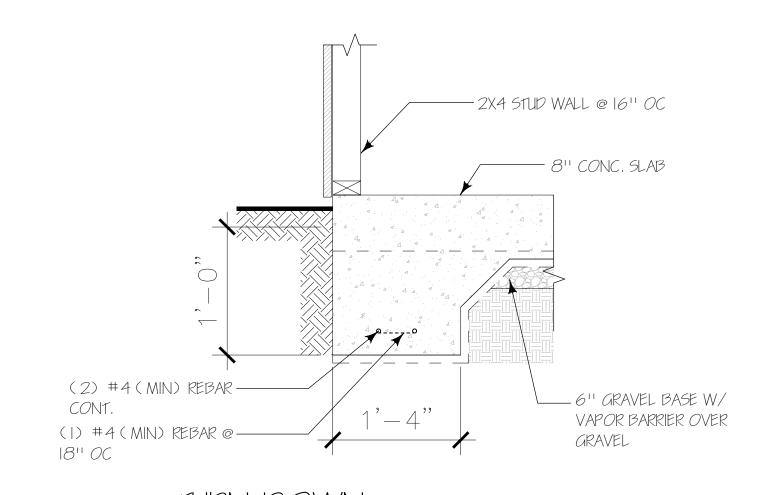

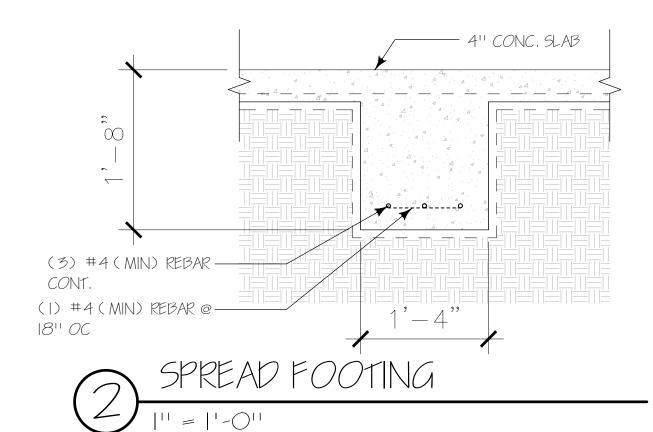


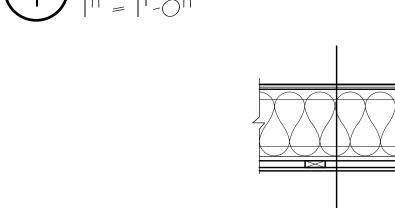


-5/8" PLYWOOD TONGUE AND GROOVE GLUED AND SCREWED -JOISTS (SEE PLAN) -R-31 MIN. BATT INSULATION -1/2" INT. FIBER BOARD (OPTIONAL) -SEALED VAPOR BARRIER -1"X4" FURRING AT 16" O.C. (OPTIONAL) -5/8" GYPSUM BOARD TYPE "X"


FIRE RATED CEILING FINISH


SCALE: 1/4" = 1' - 0"

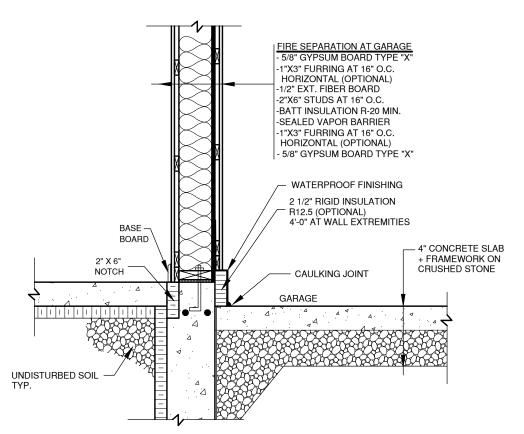

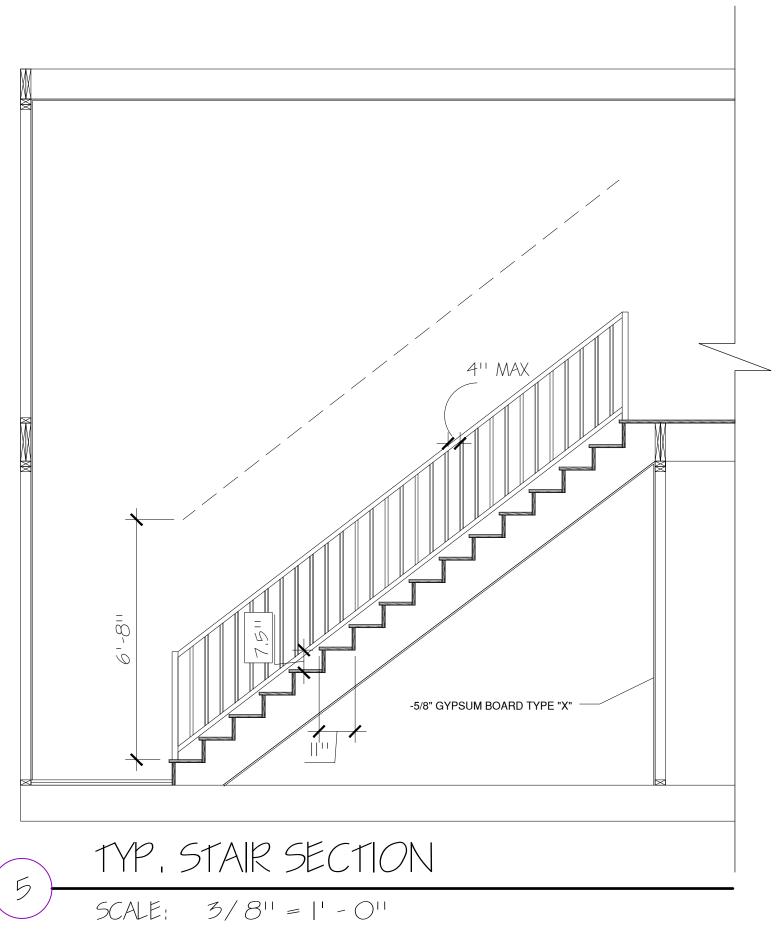



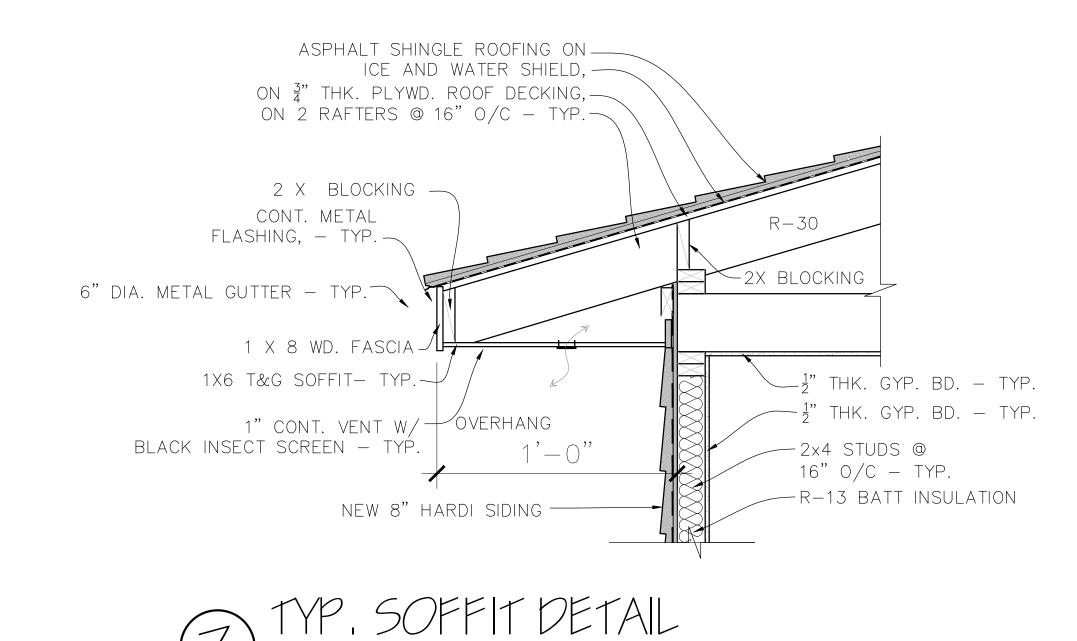

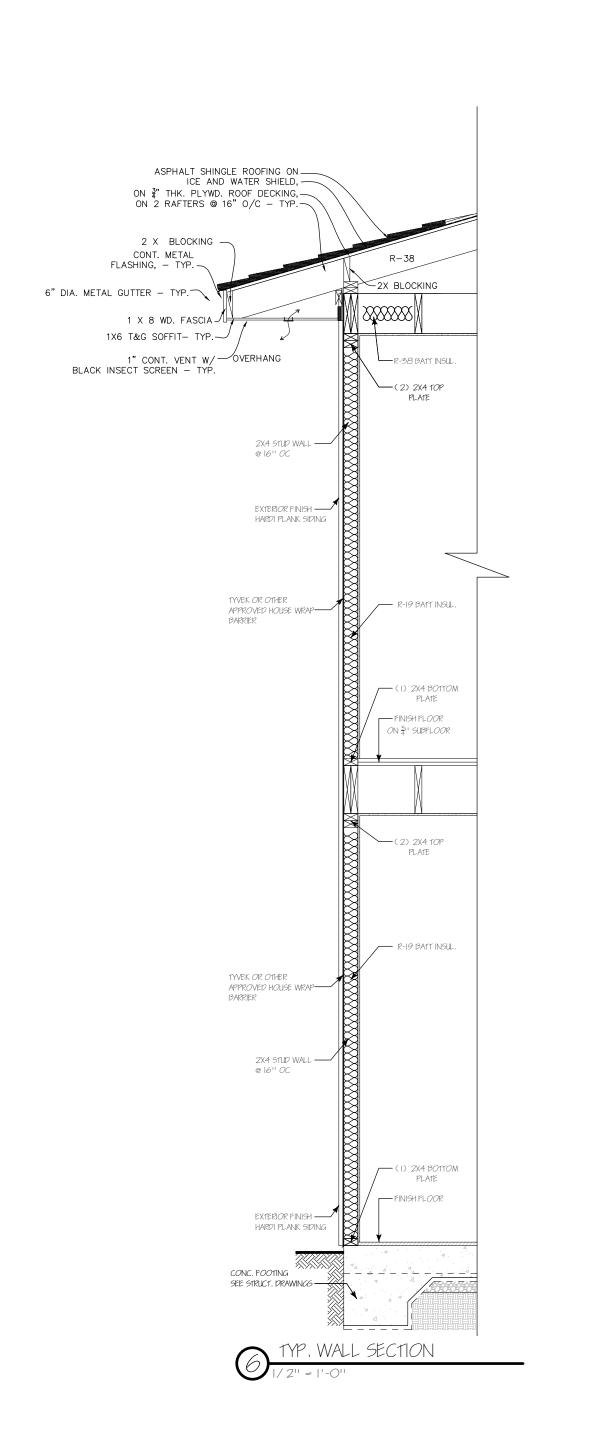

ENGINEER STAMP & SEAL



STUDIO TEN DESIGNS



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PROJECT MANAGER


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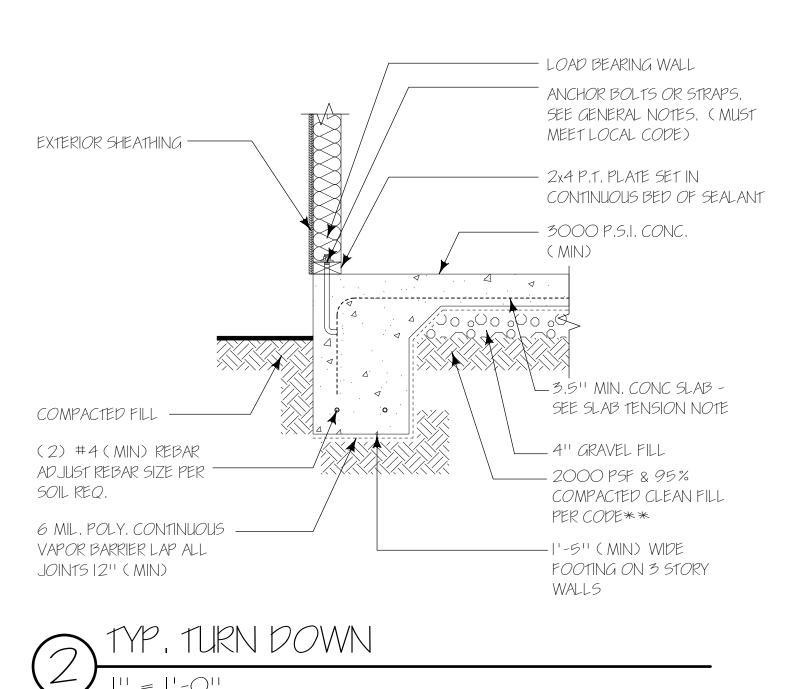
SEPTEMBER 15, 2022 SHEET TITLE:

PROPOSED SECTIONS & DETAILS







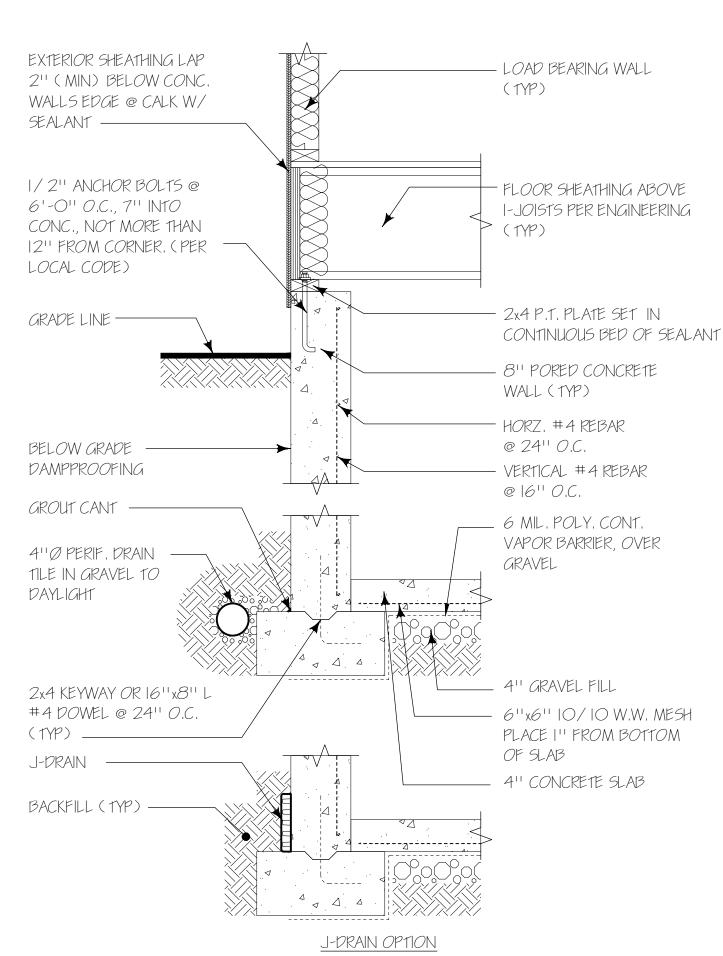

#4@16" O.C. BOTH -

DIRECTIONS ACROSS PORCH

COLUMN PER ELEVATION —

SEE DETAIL G-B/BF FOR —

5" CONCRETE SLAB —

2x4 KEYWAY —

COMPACTED FILL

STAIR CONDITION

VERTICAL #4 REBAR

2x4 KEYWAY OR 16"x8" L

#4 DOWEL @ 24" O.C.

@ 16'' O.C.

@ 24'' O.C.


(1YP)


J-DRAIN

BACKFILL (TYP)

HORZ. #4 REBAR

GRADE LINE

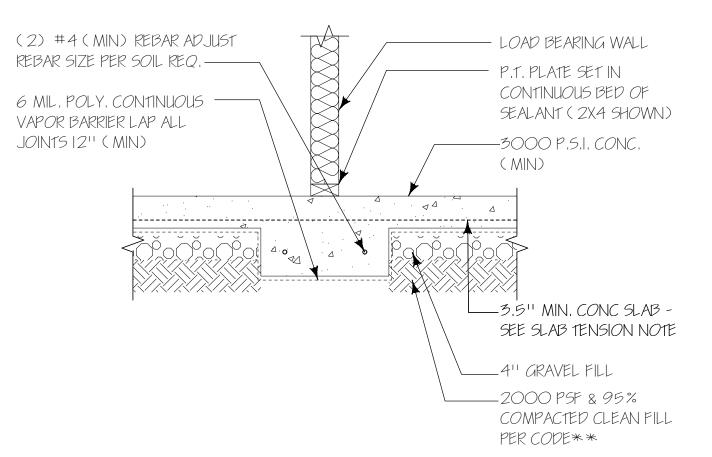

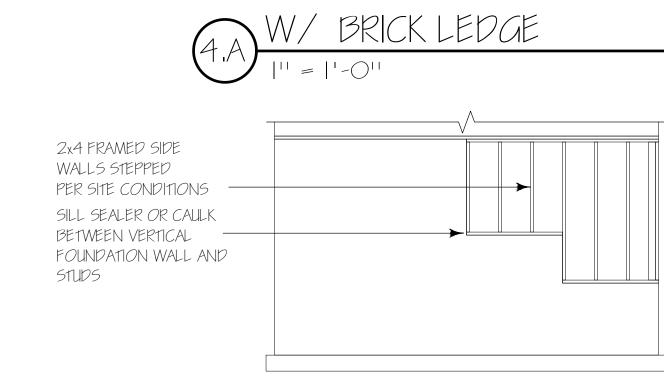

2x4 FRAMED SIDE

PER SITE CONDITIONS

SILL SEALER OR CAULK

FOUNDATION WALL AND

BRICK LEDGE AS REQUIRED

PER FINISHED GRADE

BETWEEN VERTICAL

WALLS STEPPED

S1UDS



#4@16"0.C.B01H —

I'' AIR SPACE BEHIND

BRICK VENEER

TIE-BACK

GRADE LINE

DIRECTIONS ACROSS PORCH

BRICK VENEER W/ METAL ---

STAIRS SHALL BE BUILD ON STOOP ARMS ALONG W/

SIDEWALK DISREGARD DETAIL

G-B/BFW/BRICK —

VERTICAL #4 REBAR

HORZ. #4 REBAR

2x4 KEYWAY OR —

@ 24" O.C. (1YP)

BACKFILL (TYP) -

WITH BRICK

J-DRAIN —


2' LONG #4 DOWEL

@ 20¹¹ 0.C.

@ 24" O.C.



STEPPED WALL ELEV.

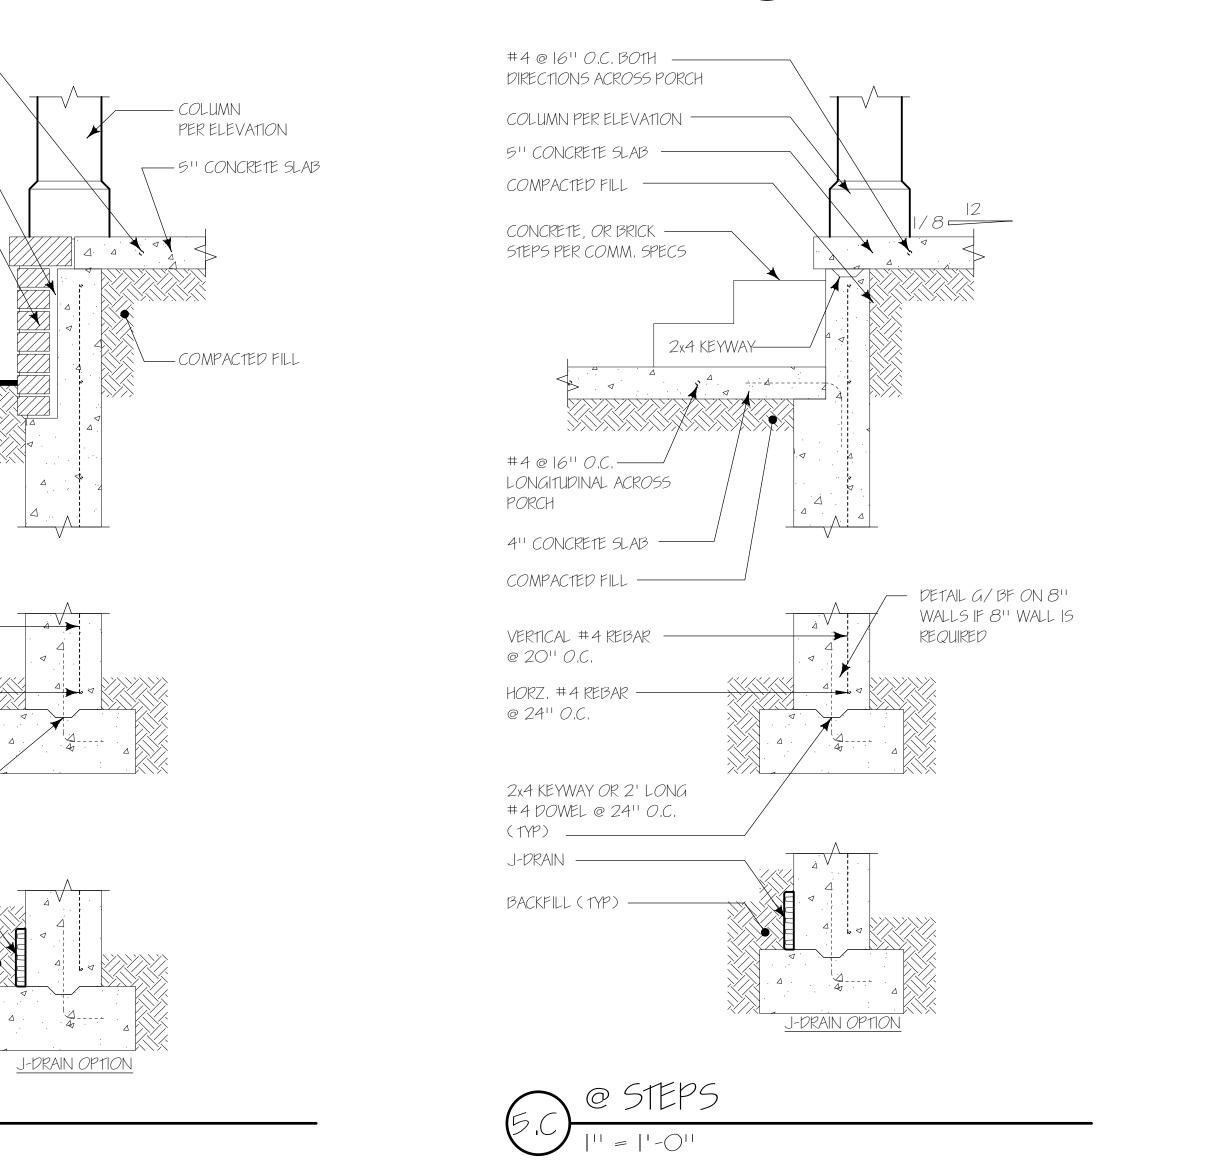



ENGINEER STAMP & SEAL



STUDIO TEN DESIGNS



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> REMODEL @ 500 S WESTMINISTER WAN ATLANTA, GA 30307

PROJECT MANAGER

<u>PRAWN BY:</u> JASON ALBERT 678.390.4655 JASON@STUDIOTENDESIGNS.COM

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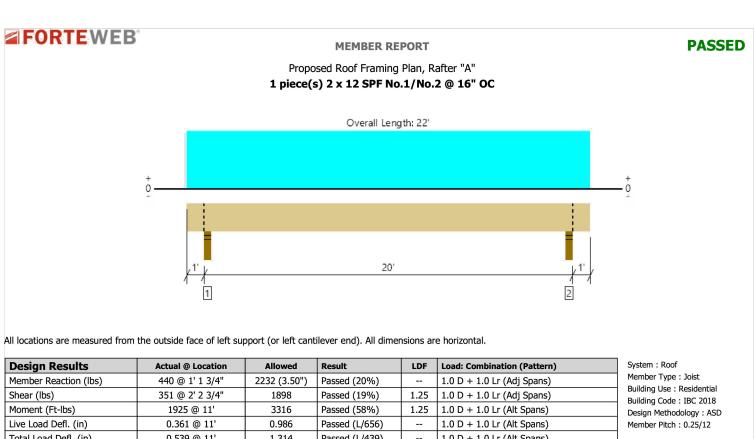
SEPTEMBER 15, 2022 SHEET TITLE:

PROPOSED
SECTIONS & DETAILS

11



		500 S Westminster Way - Revised	
Proposed Roof Framing	g Plan		
Member Name	Results	Current Solution	Comments
Rafter "A"	Passed	1 piece(s) 2 x 12 SPF No.1/No.2 @ 16" OC	
Proposed Upper Ceiling	g Framing Plan		
Member Name	Results	Current Solution	Comments
Beam "A"	Passed	2 piece(s) 2 x 10 SPF No.1/No.2	
Joist "A"	Passed	1 piece(s) 2 x 6 SPF No.1/No.2 @ 16" OC	
Proposed Main Ceiling	Framing Plan		
Member Name	Results	Current Solution	Comments
Header "A"	Passed	2 piece(s) 1 3/4" x 11 7/8" 2.0E Microllam® LVL	
Beam "B"	Passed	2 piece(s) 1 3/4" x 11 7/8" 2.0E Microllam® LVL	
Joist "B"	Passed	1 piece(s) 14" TJI® 230 @ 24" OC	
Proposed Deck Framin	g Plan		
Member Name	Results	Current Solution	Comments
Beam "C"	Passed	3 piece(s) 2 x 10 SPF No.1/No.2	
Beam "D"	Passed	3 piece(s) 2 x 10 SPF No.1/No.2	
Beam "E"	Passed	1 piece(s) 3 1/2" x 9 1/2" 2.0E Parallam® PSL (East)	
Joist "C"	Passed	1 piece(s) 2 x 8 SPF No.1/No.2 @ 16" OC	



1.314 Passed (L/439) -- 1.0 D + 1.0 Lr (Alt Spans)

Live Load Defl. (in) Total Load Defl. (in) 0.539 @ 11'

 Deflection criteria: LL (L/240) and TL (L/180). • Overhang deflection criteria: LL (2L/240) and TL (2L/180). • Allowed moment does not reflect the adjustment for the beam stability factor.

• A 15% increase in the moment capacity has been added to account for repetitive member usage. Applicable calculations are based on NDS.


	Bearing Length		Loads	to Supports					
Supports	Total	Available	Required	Dead	Roof Live	Factored	Accessories		
1 - Stud wall - SPF	3.50"	3.50"	1.50"	147	294	440	Blocking		
2 - Stud wall - SPF	3.50"	3.50"	1.50"	147	294	440	Blocking		
Blocking Panels are assumed to carry no load.	Blocking Panels are assumed to carry no loads applied directly above them and the full load is applied to the member being designed.								

Lateral Bracing	Bracing Intervals	Comments
Top Edge (Lu)	6' 4" o/c	
Bottom Edge (Lu)	22' o/c	
Maximum allowable bracing interview.	vals based on applied load.	

Vertical Load	Location (Side)	Spacing	Dead (0.90)	Roof Live (non-snow: 1.25)	Comments
1 - Uniform (PSF)	0 to 22'	16"	10.0	20.0	Default Load

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The product application, input design loads, dimensions and support information have been provided by ForteWEB Software Operator

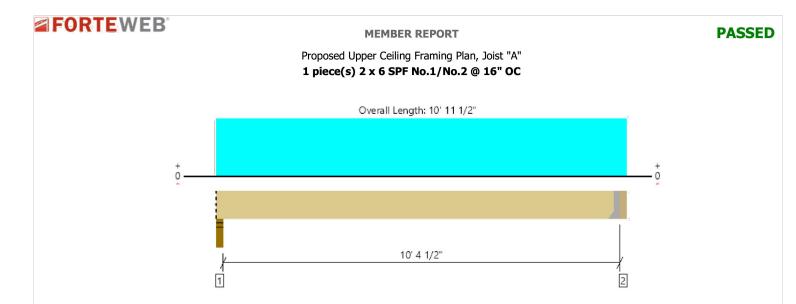

All locations are measured from the outside face of left support (or left cantilever end). All dimensions are horizontal.

Design Results	Actual @ Location	Allowed	Result	LDF	Load: Combination (Pattern)	System: Roof
Member Reaction (lbs)	209 @ 10' 8"	956 (1.50")	Passed (22%)		1.0 D + 1.0 Lr (All Spans)	Member Type : Joist
Shear (lbs)	191 @ 10' 2 1/2"	928	Passed (21%)	1.25	1.0 D + 1.0 Lr (All Spans)	Building Use: Residential Building Code: IBC 2018
Moment (Ft-lbs)	547 @ 5' 5 1/4"	1030	Passed (53%)	1.25	1.0 D + 1.0 Lr (All Spans)	Design Methodology : ASD
Live Load Defl. (in)	0.247 @ 5' 5 1/4"	0.523	Passed (L/509)		1.0 D + 1.0 Lr (All Spans)	Member Pitch : 0/12
Total Load Defl. (in)	0.370 @ 5' 5 1/4"	0.697	Passed (L/339)		1.0 D + 1.0 Lr (All Spans)	

Deflection criteria: LL (L/240) and TL (L/180).

• Allowed moment does not reflect the adjustment for the beam stability factor. • A 15% increase in the moment capacity has been added to account for repetitive member usage.

Applicable calculations are based on NDS.

Bearing Length			Loads	to Supports			
To	otal	Available	Required	Dead	Roof Live	Factored	Accessories
3.	50"	3.50"	1.50"	73	145	218	Blocking
3.	50"	Hanger ¹	1.50"	74	147	221	See note 1
		Hanger¹		167.9	- 00		

• At hanger supports, the Total Bearing dimension is equal to the width of the material that is supporting the hanger • ¹ See Connector grid below for additional information and/or requirements.

Lateral Bracing	Bracing Intervals	Comments
Top Edge (Lu)	10' 8" o/c	
Bottom Edge (Lu)	10' 8" o/c	

Bottom Edge (Lu)	10' 8" o/c	
Maximum allowable bracing interview.	vals based on applied load.	
	80	


2 - Face Mount Hanger	LU26	1.50"	N/A	6-10
Refer to manufacturer notes and instruction	ons for proper installation and use	of all connectors.		


		0	Dead	Roof Live	
Vertical Load	Location (Side)	Spacing	(0.90)	(non-snow: 1.25)	Comments
1 - Uniform (PSF)	0 to 10' 11 1/2"	16"	10.0	20.0	Default Load


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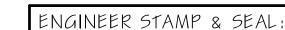
Member Fasteners Accessories

4-10dx1.5



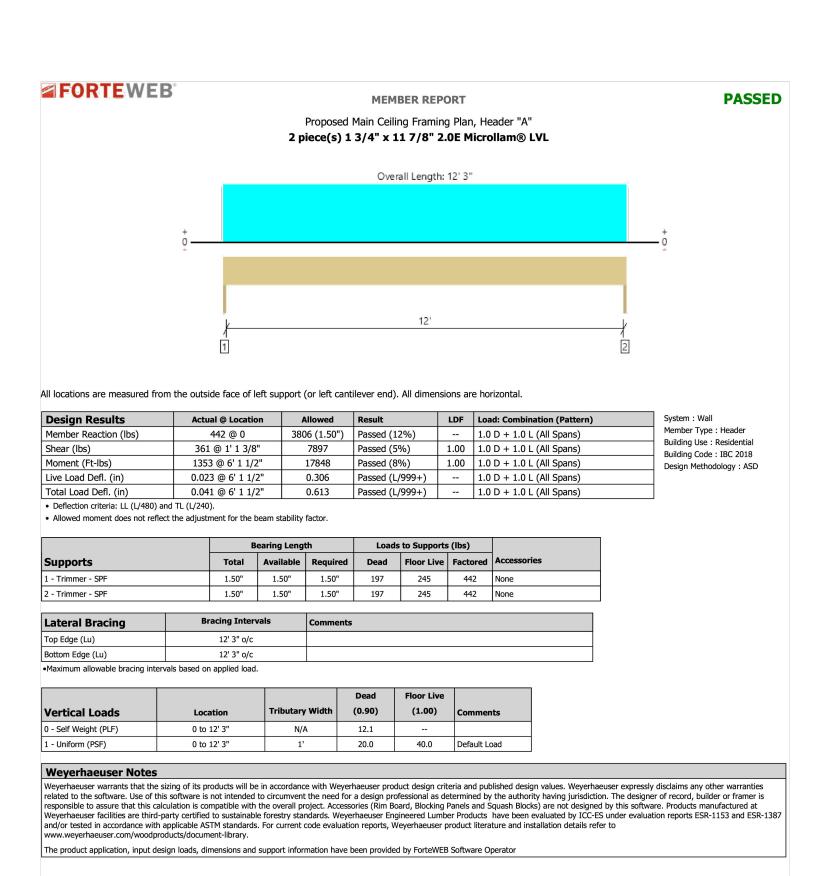

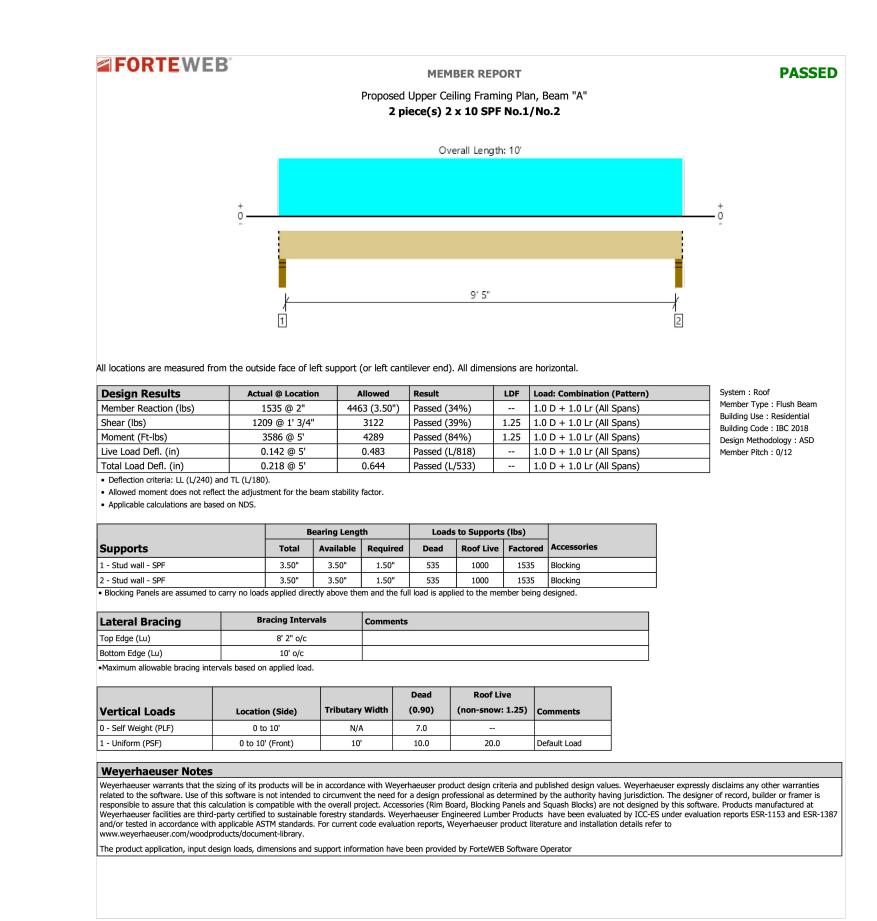

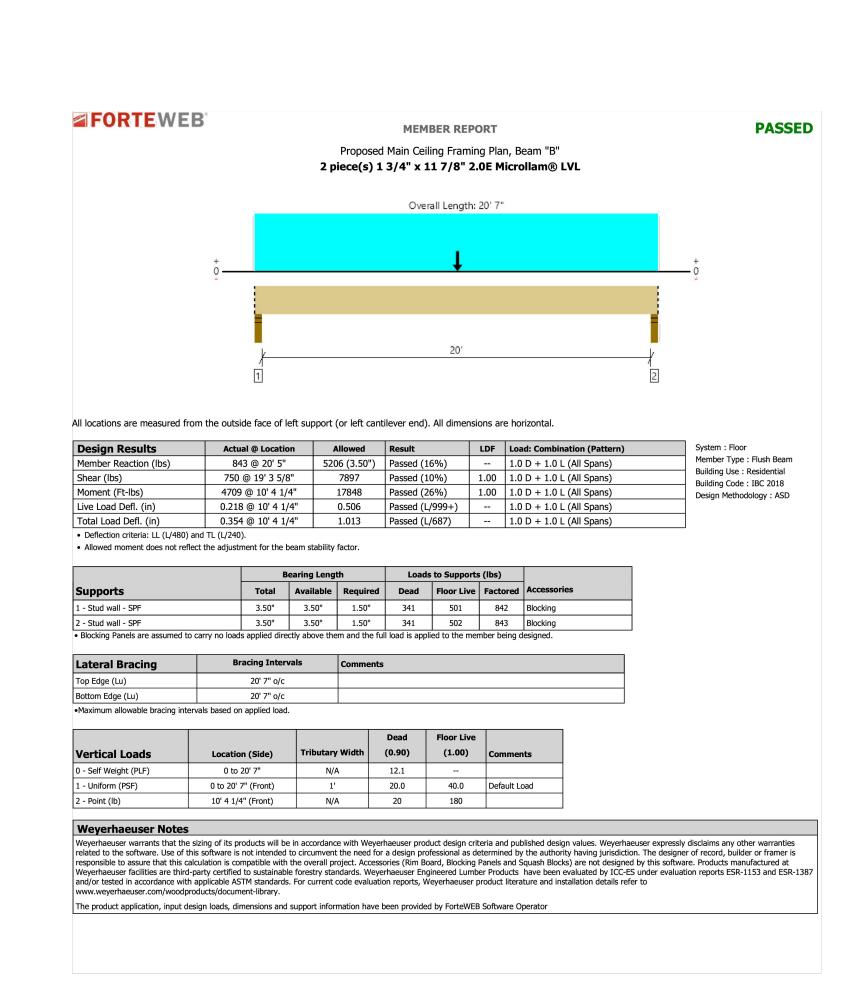



DRAWINGS BY: STUDIO TEN DESIGNS




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PROJECT MANAGER

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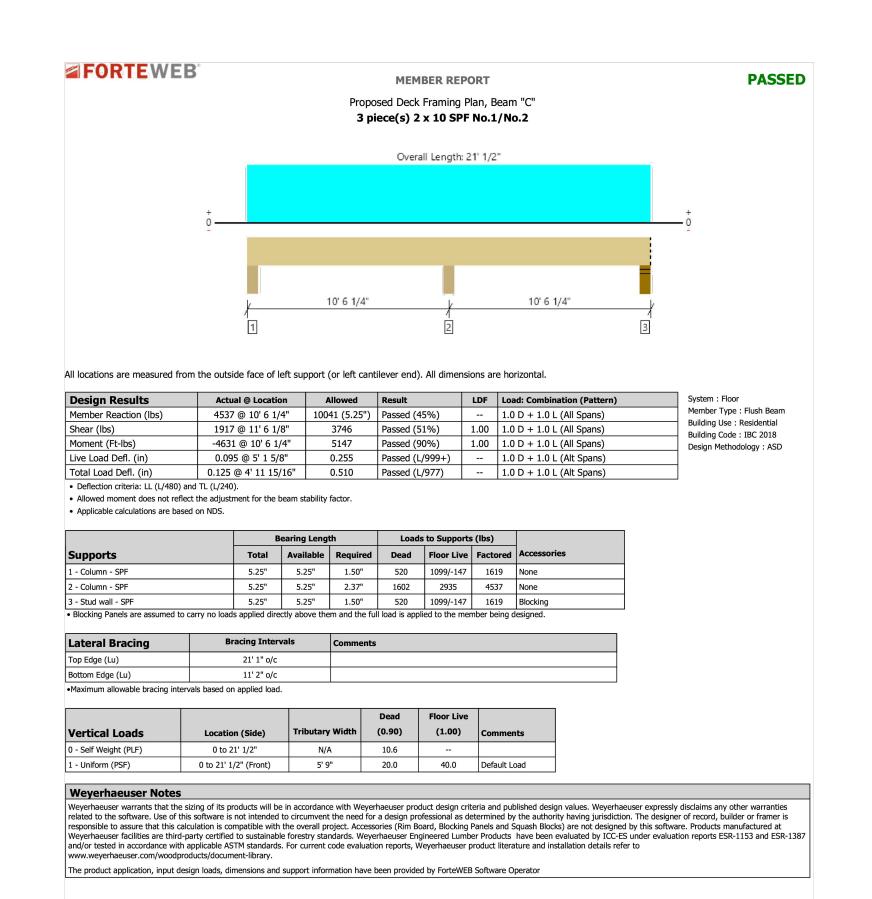
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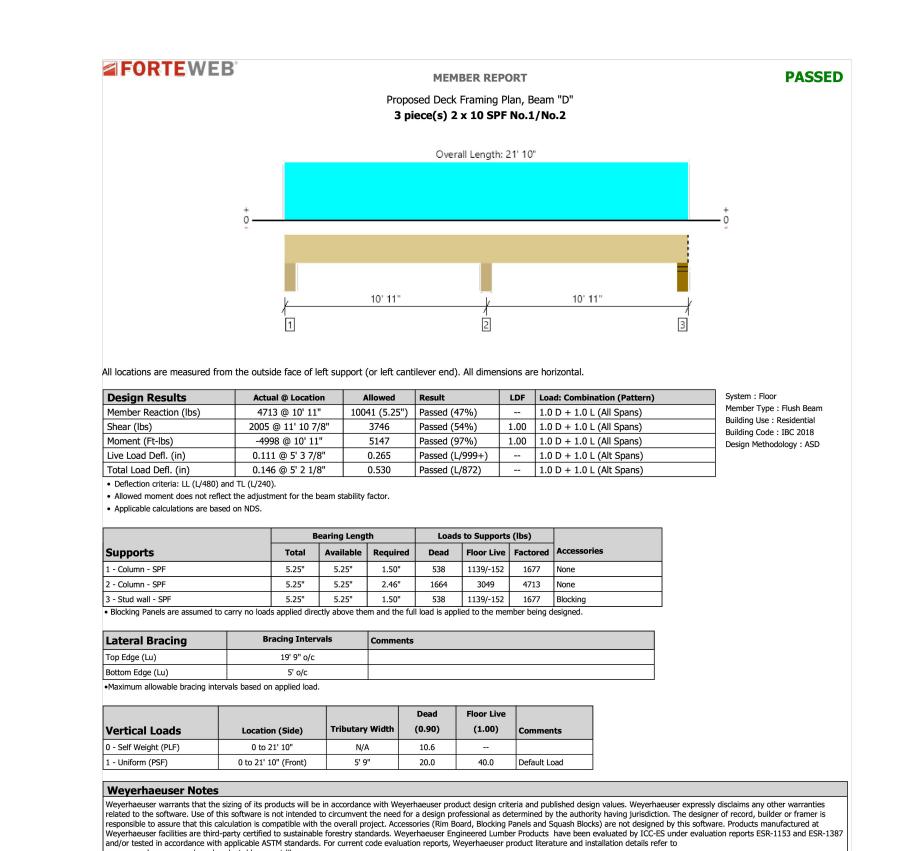
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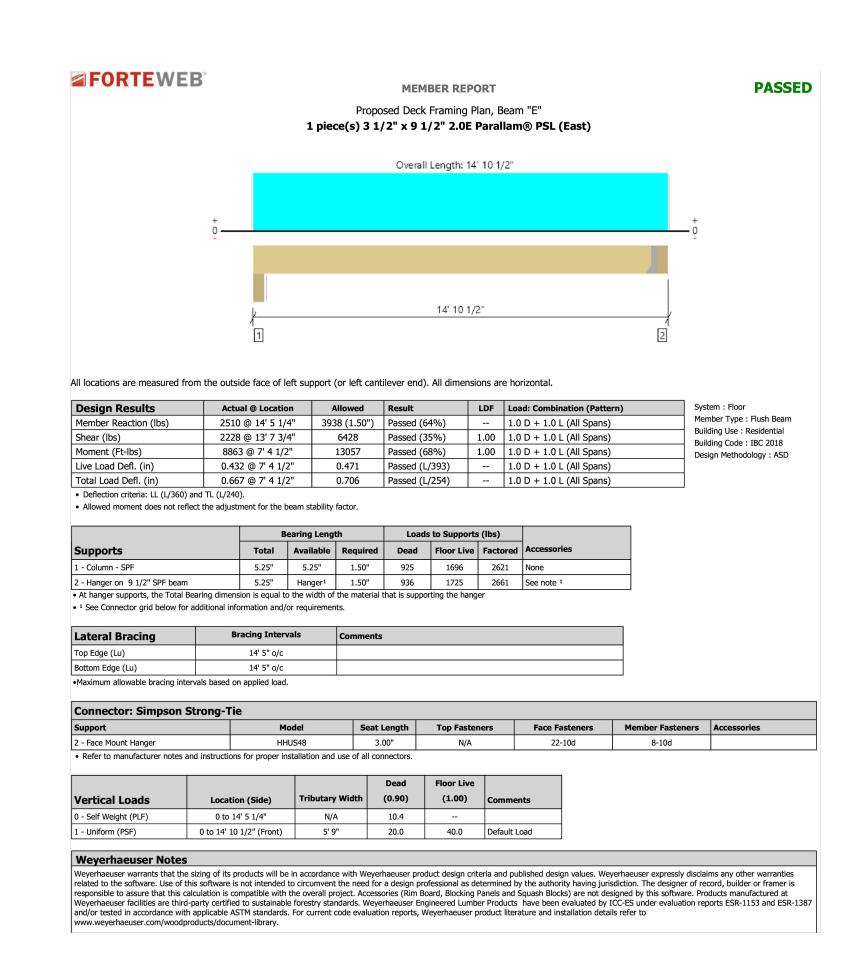
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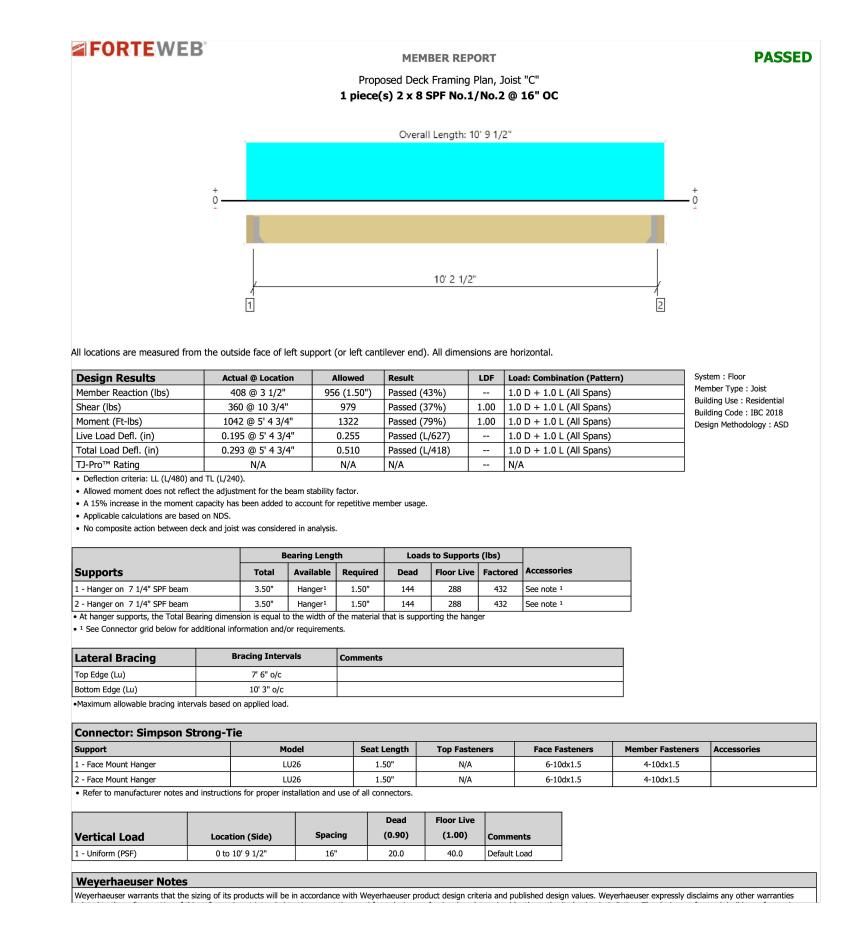
The product application, input design loads, dimensions and support information have been provided by ForteWEB Software Operator





The product application, input design loads, dimensions and support information have been provided by ForteWEB Software Operator

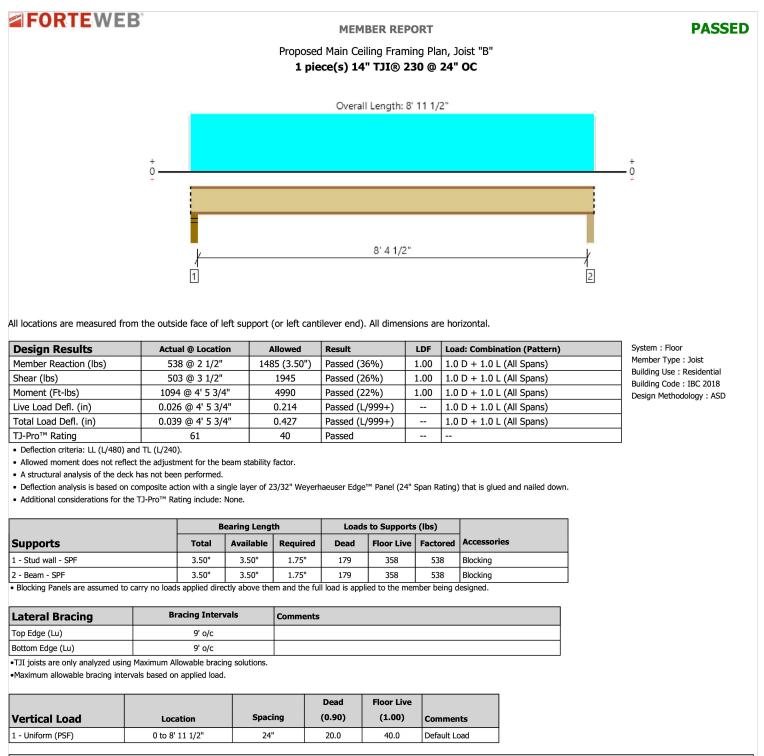





ENGINEER STAMP & SEAL

DRAWINGS BY: STUDIO TEN DESIGNS



JASON ALBERT - 678,390,4655 JASON@STUDIOTENDESIGNS

STMINISTER

PROJECT MANAGER

DRAWN BY: JASON ALBERT 678,390,4655 JASON@STUDIOTENDESIGNS.COM

DOCUMENT PHASE:

RELEASED FOR CONSTRUCTION

SEPTEMBER 15, 2022

PROPOSED FRAMING CALCS



SITE NOTES:

- 1. TOTAL SITE AREA: 0.463 ACRES / 20,152 SF TOTAL DISTURBED AREA: 0.10 ACRES / 4.140 SF
- 2. SITE ADDRESS: 500 SOUTH WESTMINISTER WAY, DEKALB COUNTY, GA 30307
- 3. SURVEY INFORMATION TAKEN FROM SURVEYS PERFORMED BY GEORGIA LAND SURVEYING, CO. DATED 1-28-2019.
- 4. THIS SITE IS NOT LOCATED WITHIN A ZONE [A, AE, SHADED ZONE X] AS DEFINED BY F.I.R.M. COMMUNITY PANEL NUMBER 13089C066K DATED AUGUST 15, 2019 FOR INCORPORATED DEKALB COUNTY, GEORGIA.
- 5. THE EXISTING UTILITIES SHOWN ON THE PLANS ARE SHOWN FOR THE OWNERS CONVENIENCE. THE ENGINEER ASSUMES NO RESPONSIBILITY FOR THE LOCATIONS, SIZES, MATERIALS, OR DEPTH FOR THE UTILITIES SHOWN OR THE UTILITIES WHICH MAY EXIST ON THE SITE BUT ARE NOT SHOWN. THE CONTRACTOR SHALL HAVE THE RESPONSIBILITY TO VERIFY THE LOCATION OF ALL UTILITIES SHOWN ON THE PLANS AND REPORT ANY DISCREPANCIES TO THE ENGINEER OF RECORD. THE CONTRACTOR SHALL ALSO HAVE THE RESPONSIBILITY BEFORE STARTING ANY WORK TO MAKE SUCH EXPLORATIONS AND PROBES NECESSARY TO ASCERTAIN ANY SEWER LINES, WATER SUPPLY LINES, GAS LINES, ELECTRICAL LINES, CABLE LINES, TELEPHONE LINES, OR OTHER UTILITY LINE.
- 6. ALL FUTURE CONSTRUCTION MUST CONFORM TO THE APPROPRIATE CITY, COUNTY, AND STATE STANDARDS
- CONTRACTOR SHALL CONTACT THE UTILITY LOCATOR AS REQUIRED BY GEORGIA LAW AND HAVE ALL UTILITIES MARKED PRIOR TO ANY CONSTRUCTION ACTIVITY. CONTRACTOR WILL HAVE PRIVATE UTILITY LOCATOR LOCATE ALL UTILITIES WITHIN THE CONSTRUCTION LIMITS NOT COVERED BY THE UTILITY PROTECTION CENTER.
- 8. THE CONTRACTOR SHALL IMMEDIATELY NOTIFY THE ENGINEER OF ANY DISCREPANCIES OR ERRORS THAT HE MAY DISCOVER IN THESE PLANS.
- 9. CONTRACTOR TO PROVIDE ALL NECESSARY BARRICADES, GUARDS, LIGHTS, AND OTHER INSTALLATIONS REQUIRED TO PROTECT PERSONS AND PROPERTY DURING THE ENTIRE CONSTRUCTION PROCESS.
- 10. ALL CONSTRUCTION MUST CONFORM TO THE APPROPRIATE DEKALB COUNTY AND STATE OF GEORGIA STANDARDS.
- 11. UNDERGROUND UTILITIES SERVING OR CROSSING THE PREMISES MAY EXIST THAT ARE NOT SHOWN. CRESCENT VIEW ENGINEERING IS UNABLE TO CERTIFY TO THE ACCURACY OR COMPLETENESS OF THE UTILITY INFORMATION SHOWN. ALL UNDERGROUND UTILITY LOCATIONS MUST BE FIELD VERIFIED PRIOR TO ANY CONSTRUCTION ACTIVITY BY THE UTILITY PROTECTION CENTER AT 1-800-282-7411 FOR RIGHT OF WAY AREA AND BY A PRIVATE UTILITY LOCATOR FOR UTILITIES NOT LOCATED WITHIN THE RIGHT OF WAY.
- 12. THE CONTRACTOR MUST OBTAIN ADDITIONAL "RIGHT OF WAY" PERMIT FOR ALL NECESSARY WORK DONE IN THE RIGHT OF WAY.
- 13. ALL APPROPRIATE EASEMENTS, STATE WATER BUFFERS, STREAM BUFFERS, AND/OR FLOOD PLAIN BUFFERS THAT APPLY TO THIS PROPERTY ARE SHOWN ON THESE PLANS
- 14. TO THE BEST OF OUR KNOWLEDGE, THERE NO CEMETERIES, ARCHITECTURAL, OR ARCHEOLOGICAL LANDMARKS EXIST ON SITE. IN THE EVENT THAT THESE LANDMARKS ARE DISCOVERED DURING CONSTRUCTION, THE ENGINEER MUST BE CONTACTED IMMEDIATELY FOR REVIEW AND AMENDING THE CONSTRUCTION PLANS
- 15. THIS PLAN WAS PREPARED FOR PERMIT APPROVAL ONLY. ACTUAL CONSTRUCTION SHOULD BE BASED ON STAKING BY A REGISTERED LAND SURVEYOR. THE FOOTPRINT IS BASED ON AN ARCHITECTURAL PLAN BY OTHERS. THE ARCHITECTURAL PLAN SHOULD BE USED FOR HOUSE POSITIONING AND LOCATION.

DEKALB COUNTY NOTES:

- 1. GRADE TO DRAIN AWAY FROM FOUNDATION.
- 2. ALL GRADED SLOPES TO BE AT A 3:1 SLOPE OR GREATER.
- ALL LAND DISTURBANCE TO BE STABILIZED WITH VEGETATION UPON COMPLETION OF DEMOLITION. ALL TREES TO REMAIN AND HAVE PROPER PROTECTION UNLESS APPROVED PLANS INDICATE OTHERWISE. CALL FOR FINAL INSPECTION AT
- 4. ALL CONSTRUCTION MUST CONFORM TO DEKALB COUNTY STANDARDS.
- PRIOR TO COMMENCING LAND DISTURBING ACTIVITY, THE LIMITS OF DISTURBANCE SHALL BE CLEARLY AND ACCURATELY DEMARCATED WITH STAKES, RIBBONS OR OTHER APPROPRIATE MEANS, THE LOCATION AND EXTENT OF ALL AUTHORIZED LAND DISTURBING ACTIVITY SHALL BE DEMARCATED FOR THE DURATION OF THE CONSTRUCTION ACTIVITY.
- 6. ALL EROSION CONTROL MEASURES SHALL BE IN PLACE PRIOR TO COMMENCING CONSTRUCTION AND SHALL BE MAINTAINED IN PROPER WORKING ORDER UNTIL ALL DISTURBED AREAS ARE STABILIZED.
- 7. A COPY OF THE APPROVED LAND DISTURBANCE PLAN SHALL BE PRESENT ON SITE WHENEVER LAND DISTURBANCE ACTIVITY IS IN PROGRESS.
- 8. FINAL ON-SITE INSPECTION REQUIRED PRIOR TO RELEASE OF THE CERTIFICATE OF OCCUPANCY, CERTIFIED AS-BUILTS WILL ALSO BE REQUIRED.
- 9. EROSION AND SEDIMENTATION CONTROL MEASURES WILL BE MAINTAINED AT ALL TIMES. IF FULL IMPLEMENTATION OF THE APPROVED PLAN DOES NOT PROVIDE FOR EFFECTIVE EROSION AND SEDIMENT CONTROL. ADDITIONAL EROSION AND SEDIMENT CONTROL MEASURES SHALL BE IMPLEMENTED TO CONTROL OR TREAT THE SEDIMENT SOURCE.
- 10. ADDITIONAL EROSION CONTROLS SHALL BE INSTALLED AS DEEMED NECESSARY BY THE IN-SITE INSPECTOR.
- 11. ALL LOTS/SITES WITH 2' OF FILL OR GREATER WILL REQUIRE A COMPACTION CERTIFICATE BY A PROFESSIONAL REGISTERED ENGINEER PRIOR OR A BUILDING PERMIT AND OR PRIOR TO FOOTERS BEING POURED.
- 12. LOCATE AND FIELD STAKE ALL UTILITIES, EASEMENTS, PIPES, FLOOD LIMITS, STREAM BUFFERS, AND TREE SAVE AREAS PRIOR TO ANY LAND DISTURBING ACTIVITIES.
- 13. ALL TREE PROTECTION AREAS TO BE PROTECTED FROM SEDIMENTATION.
- 14. ALL TREE PROTECTION DEVICES TO BE INSTALLED PRIOR TO LAND DISTURBANCE AND MAINTAINED UNTIL FINAL
- 15. ALL TREE PROTECTION FENCING TO BE INSPECTED DAILY AND REPAIRED OR REPLACED AS NEEDED
- 16. A FINAL AS-BUILT LOT SURVEY REQUIRED PRIOR TO ISSUANCE OF CERTIFICATE OF OCCUPANCY.
- 17. A FINAL AS-BUILT WATER QUALITY CERTIFICATE REQUIRED PRIOR TO CERTIFICATE OF OCCUPANCY.
- 18. WATER QUALITY BMP(s) TO BE INSTALLED AT THE TIME OF FINAL LANDSCAPING.
- 19. ALL COLLECTED WATER SHALL BE DIRECTED TO THE WATER QUALITY BMP(s).
- 20. WORK HOURS AND CONSTRUCTION DELIVERIES ARE: MONDAY-FRIDAY 7: 00am-7: 00pm SATURDAY 8: 00am-5: 00pm

STATEWATER STATEMENT:

THIS PROPERTY IS NOT LOCATED INSIDE DESIGNATED F.I.A SPECIAL FLOOD HAZARD AREA AS PER THE FLOOD INSURANCE RATE MAP #13089C0066K, DATED AUGUST 15, 2019.


THERE ARE WATERS OF THE STATE OF GEORGIA LOCATED ON OR WITHIN 200 FEET OF THE SITE. ALL APPROPRIATE STATE WATER BUFFERS ARE SHOWN ON THE SITE PLANS.

24 HOUR EMERGENCY CONTACT: NIC BRANKER 919-285-1287

SINGLE FAMILY HOUSE ADDITION CONSTRUCTION DOCUMENTS FOR

500 SOUTH WESTMINISTER WAY

LAND LOT 51, DISTRICT 18 DEKALB COUNTY, GEORGIA

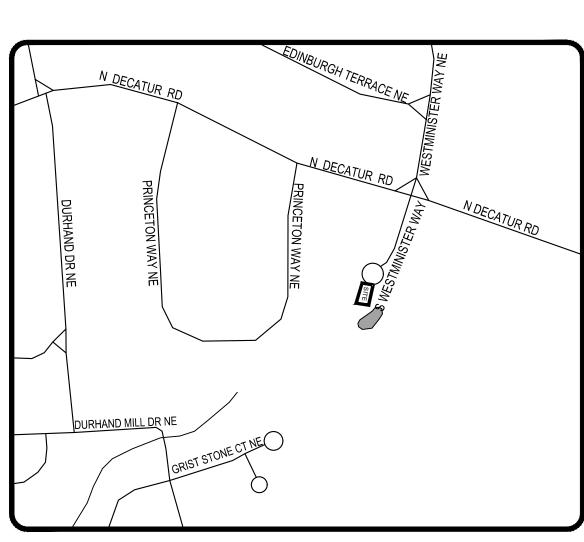

ZONING CONFORMANCE:

MINIMUM LOT SIZE: 10,000 SF

SIDE SETBACK: 7.5 FEET

REAR SETBACK: 40 FEET

OPEN SPACE: 20%

LOT WIDTH: 75 FEET, MIN AT STREET

LOT COVERAGE: SHALL NOT EXCEED 35%

OFF-STREET PARKING: 2 SPACES

GSWCC GEORGIA SOIL AND WATER

GEORGE H BALTZ III

CERTIFICATION NUMBER:

ISSUED: 09/25/2007

CONSERVATION COMMISSION

0000045830

EXPIRES: 11/10/2025

NUMBER: 0000045830

EXPIRATION 11-10-25

FLOOR AREA: NO LESS THAN 1600 SQ FEET

BUILDING HEIGHT: NO MORE THAN 35 FEET

SITE ZONING: R-75 (RESIDENTIAL MEDIUM LOT-75) DISTRICT

75 FEET. MIN AT BUILDING LINE

30 FEET MIN (COLLECTOR AND ALL OTHERS)

35 FEET, MIN FOR CULDESAC

25 FEET MIN (ALLEY ACCESS)

FRONT SETBACK: 45 FEET MIN (THOROUGHFARES)

35 FEET MIN (ARTERIALS)

FEMA Map

THIS SITE IS NOT LOCATED WITHIN A ZONE [A, AE, SHADED ZONE X] AS DEFINED BY F.I.R.M. COMMUNITY PANEL NUMBER 13089C0066K DATED AUGUST 15, 2019 FOR INCORPORATED DEKALB COUNTY, GEORGIA.

ADDRESSING:

500 SOUTH WESTMINSTER WAY DEKALB COUNTY, GEORGIA 30307

OWNER INFORMATION:

NIC BRANKER 500 SOUTH WESTMINISTER WAY, DEKALB COUNTY, GEORGIA 30312

CONSTRUCTION NARRATIVE:

THE PROPOSED PLANS CALL FOR AN ADDITION OF A TWO STOREY GARAGE WITH A DECK AND A SWIMMING POOL. CONFORMING TO R-75 ZONING. ALL PHASED EROSION CONTROL BMPS ARE TO REMAIN IN PLACE UNTIL THE SITE IS 100% STABILIZED.

"I CERTIFY UNDER THE PENALTY OF LAW THAT THIS PLAN WAS PREPARED AFTER A SITE VISIT TO THE LOCATIONS DESCRIBED HEREIN BY MYSELF OR MY AUTHORIZED AGENT, UNDER MY DIRECT SUPERVISION"



03-15-23

DEKALB COUNTY TREE NOTES:

- NO ONE SHALL ENCROACH, PLACE SOLVEMENTS, BUILDING, MACHINERY, BUILDING DEBRIS OR ANY OTHER MATERIAL WITHIN 6' OUTSIDE THEE PERIPHERY OF THE CRZ OR WITHIN ANY TREE SAVE AREA, TRANSITIONAL BUFFER ZONE, STREAM BUFFER, OR STATE BUFFER ZONE.
- ALL TREE FENCE AND OTHER TREE PROTECTION DEVICES MUST REMAIN IN
- 3. A TREE THAT IS DESIGNATED TO BE SAVED, BUT IS DAMAGED DURING CONSTRUCTION, SHALL BE REPLACED WITH 4" CALIPER TREES EQUAL TO THE UNIT VALUE OF THE TREE REMOVED. ANY SPECIMEN TREE DAMAGED SHALL BE REPLACED WITH 4" CALIPER TREES EQUAL TO 1.5 TIMES THE DBH OF THE
- 4. ALL PROTECTION AREAS TO BE PROTECTED FROM SEDIMENTATION.
- 5. ALL TREE PROTECTION DEVICES, INCLUDING CRITICAL ROOTZONE(CRZ) PROTECTION, TO BE INSTALLED PRIOR TO THE START OF THE LAND DISTURBANCE, AND MAINTAINED UNTIL FINAL LANDSCAPING.
- 6. ALL TREE PROTECTION FENCING TO BE INSPECTED DAILY, AND REPAIRED OR
- NO PARKING, STORAGE OR OTHER CONSTRUCTION ACTIVITIES ARE TO OCCUR WITHIN TREE PROTECTION AREAS(CRZ).
- 8. ALL REQUIRED VEGETATION MUST BE MAINTAINED FOR TWO GROWING SEASONS
- AFTER THE DATE OF FINAL INSPECTION. TREE PROTECTION SIGNS ARE TO BE PLACED AT LEAST EVERY 50' ALONG THE LENGTH OF THE TREE PROTECTION FENCE. THE SIGNS SHOULD BE IN LANGUAGE

SO THAT ALL WORKERS ON SITE ARE ABLE TO UNDERSTAND.

PRE-CONSTRUCTION IMPERVIOUS AREA:


PRE-CONSTRUCTION LOT COVERAGE		
AREA	SF	
EXISTING HOUSE	2561	
EXISTING DECKS	318	
EXISTING CONCRETE DRIVEWAY	2276	
EXISTING CONCRETE SIDEWALK	50	
EXISTING FRONT PORCH	13	
STAIRS	63	
TOTAL PRE CONSTRUCTION IMPERVIOUS AREA	5281	
LOT COVERAGE %	26.21%	

POST-CONSTRUCTION IMPERVIOUS AREA:

SITE LOCATION	SF
EXISTING HOUSE	2561
EXISTING DECKS	317
REMAINING CONCRETE DRIVEWAY	2106
EXISTING CONCRETE SIDEWALK	50
EXISTING FRONT PORCH	13
EXISTING STAIRS	63
PROPOSED GARAGE	560
PROPOSED DRIVEWAY ADDITION	190
PROPOSED POOL	760
PROPOSED DECK	260
PROPOSED TURF DECK/WALKWAY	0
PROPOSED WALL	45
PROPOSED POOL EQUIPMENT	15
TOTAL PROPOSED IMPERVIOUS AREA	1830
TOTAL POST CONSTRUCTION IMPERVIOUS AREA	6940
LOT COVERAGE %	34.44%


LEGEND COVER SURVEY **DEMOLITION PLAN**

S-1 D-1 C-1 SITE PLAN STORMWATER PLAN **C-2** ES&PC PLAN TREE PLAN **CONSTRUCTION DETAILS**

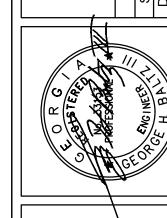

truction Plans For Westminister S 500

CVE PI # 22-139

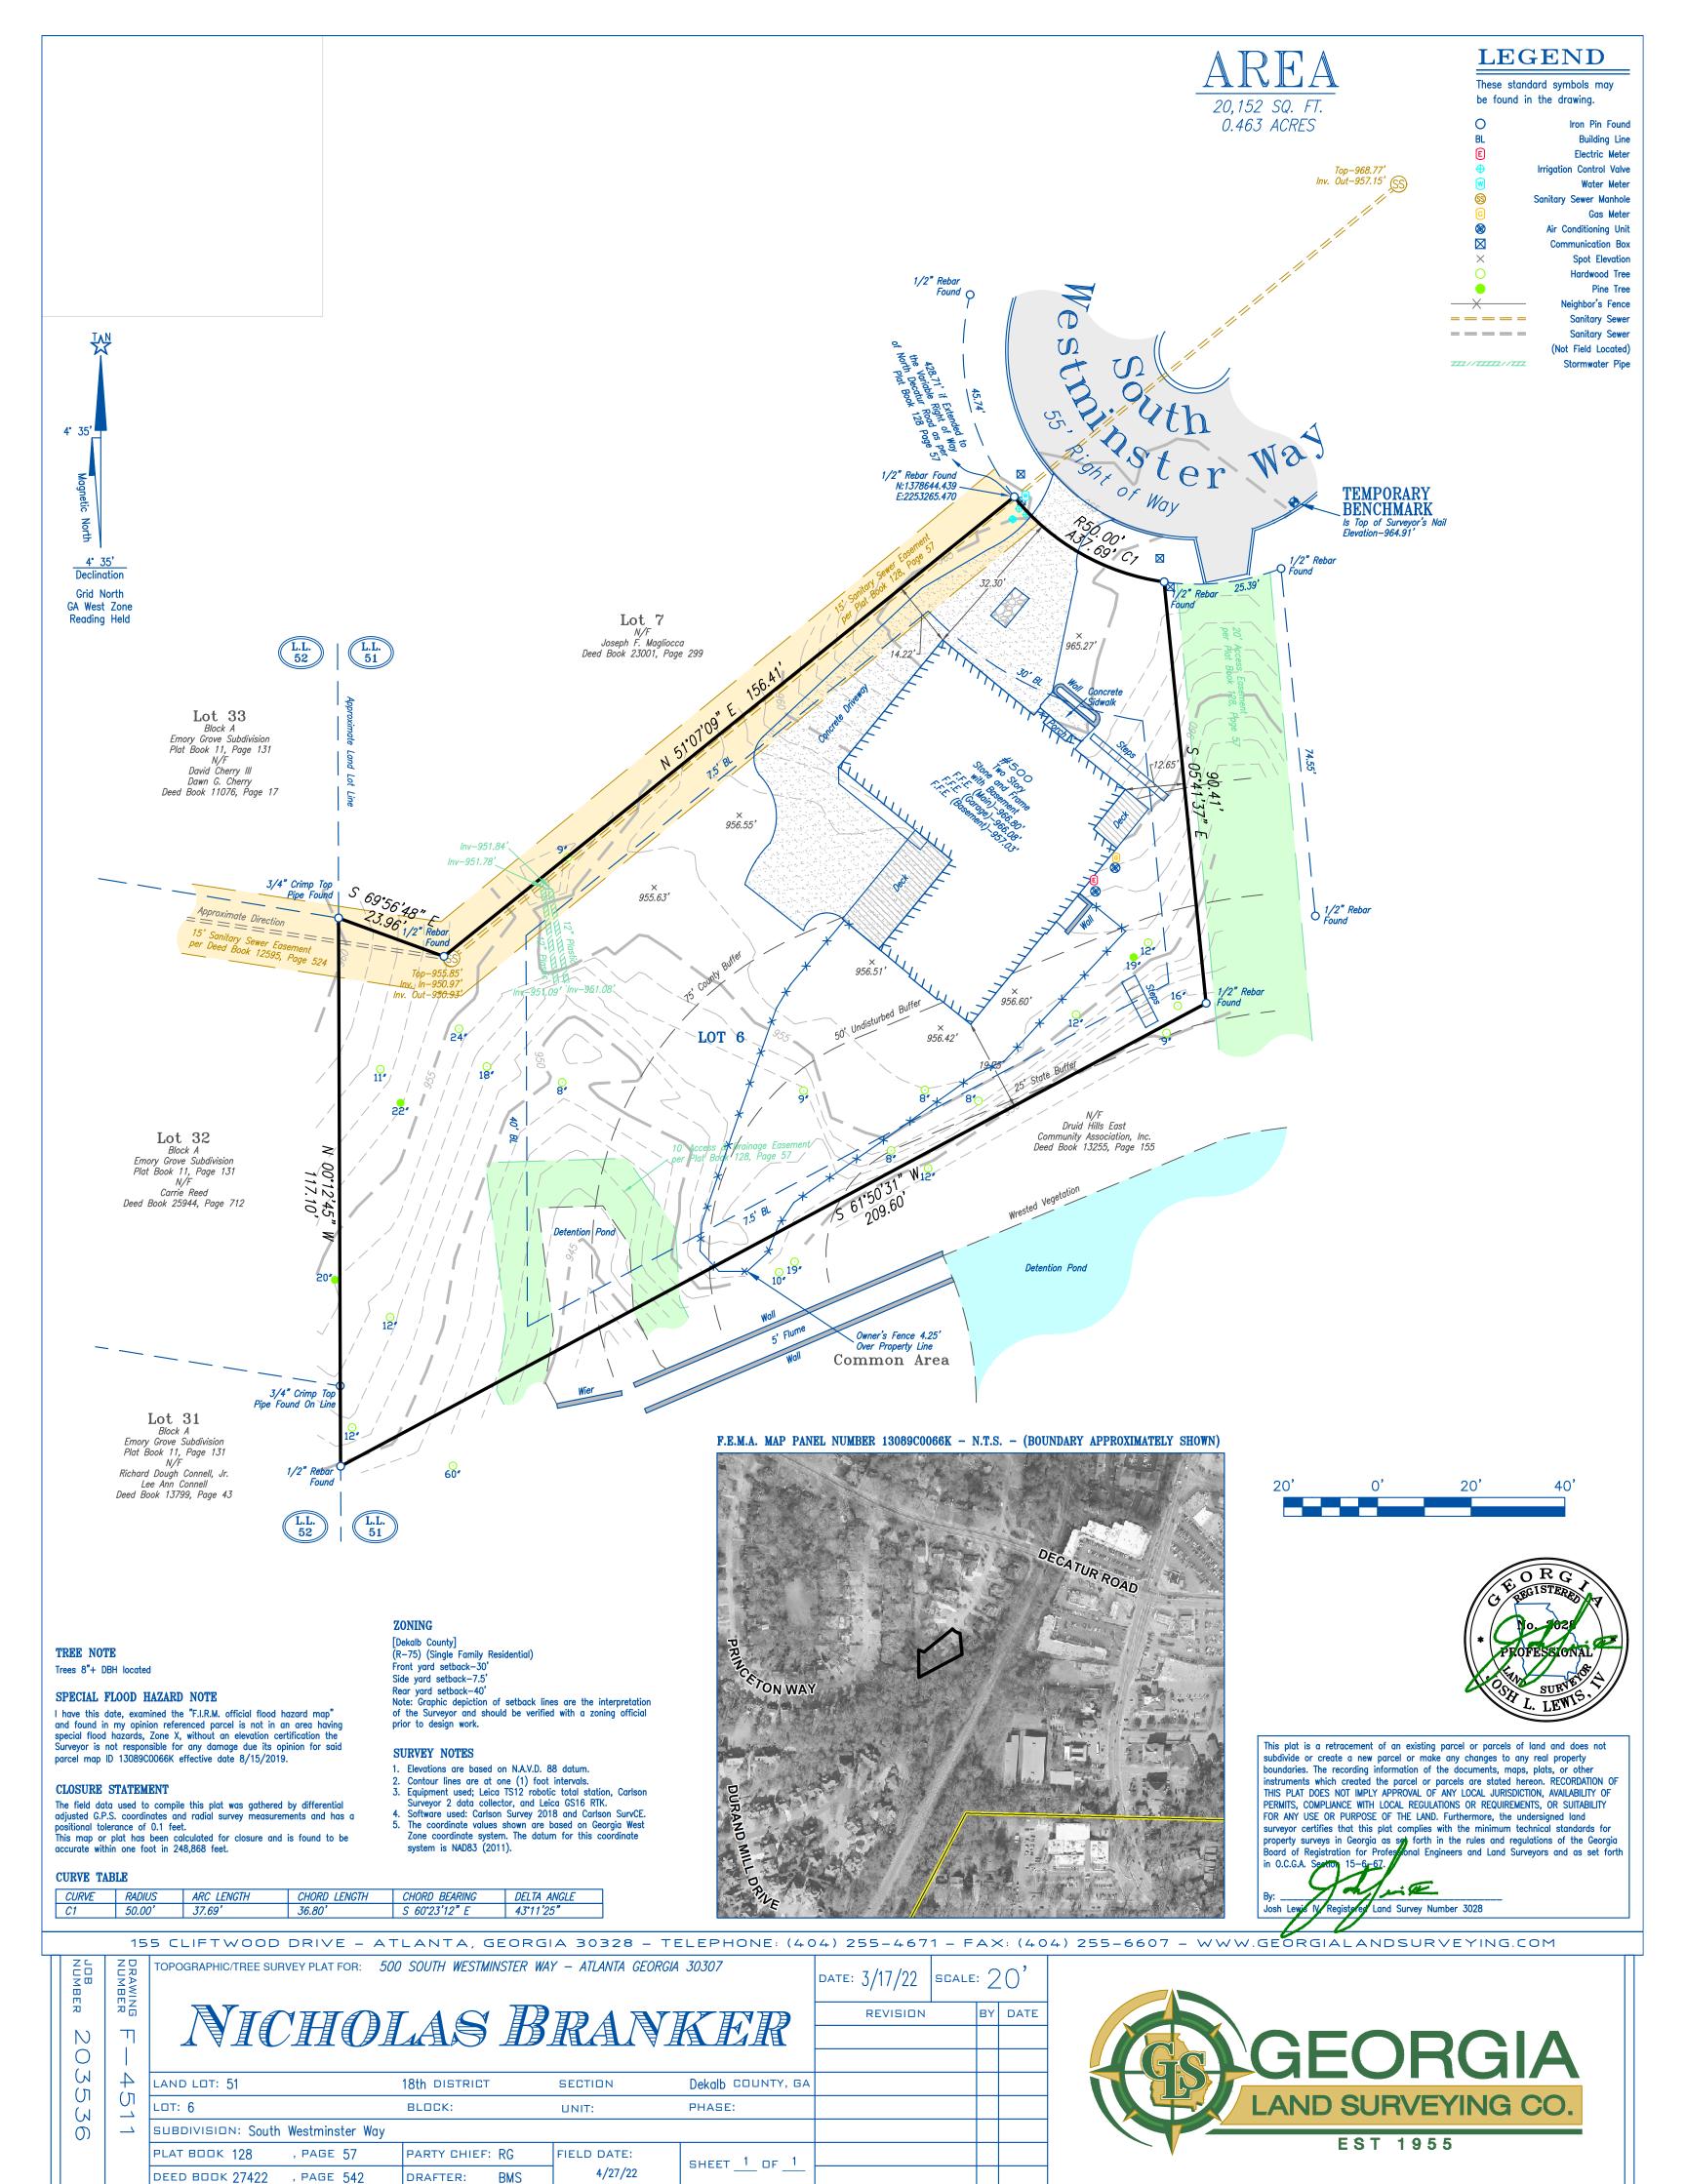

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- 4. ALL CONSTRUCTION MUST CONFORM TO DEKALB COUNTY STANDARDS.
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- MONDAY-FRIDAY 7: 00am-7: 00pm
- SATURDAY 8: 00am-5: 00pm
- 21.ALL DEMOLITION DEBRIS TO BE HAULED OFF SITE 22.DUMPSTERS AND/OR TEMPORARY SANITARY FACILITIES SHALL NOT BE LOCATED IN STREET, TREE PRÓTECTION AREA, OR RIGHT OF WAY.


GENERAL DEMOLITION NOTES:

- BE ADVISED THIS IS NOT AN EXHAUSTIVE LIST OF DEMOLITION ITEMS. CONTRACTOR SHALL BECOME FAMILIAR WITH THE SITE AND THE COMPLETE DESIGN INTENT OF THE CONSTRUCTION DOCUMENTS. ANY QUESTIONS, CONCERNS, OR IDEAS CONCERNING THE INTENT OR EXECUTION OF THE DESIGN DOCUMENTS MUST BE BROUGHT TO THE OWNER BEFORE PERFORMING ANY CONSTRUCTION ACTIVITY.
- (1) REMOVE PORTION OF EXISTING CONCRETE DRIVEWAY
- (2) LOCATE AND PROTECT ALL EXISTING UTILITIES

PRE-CONSTRUCTION IMPERVIOUS AREA:

PRE-CONSTRUCTION LOT COVERAGE		
AREA	SF	
EXISTING HOUSE	2561	
EXISTING DECKS	318	
EXISTING CONCRETE DRIVEWAY	2276	
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TOTAL PRE CONSTRUCTION IMPERVIOUS AREA	5281	
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POST-CONSTRUCTION IMPERVIOUS AREA:

POST-CONSTRUCTION LOT COVERAGE		
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REMAINING CONCRETE DRIVEWAY	2106	
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PROPOSED POOL	760	
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PROPOSED TURF DECK/WALKWAY	0	
PROPOSED WALL	45	
PROPOSED POOL EQUIPMENT	15	
TOTAL PROPOSED IMPERVIOUS AREA	1830	
TOTAL POST CONSTRUCTION IMPERVIOUS AREA	6940	
LOT COVERAGE %	34.44%	

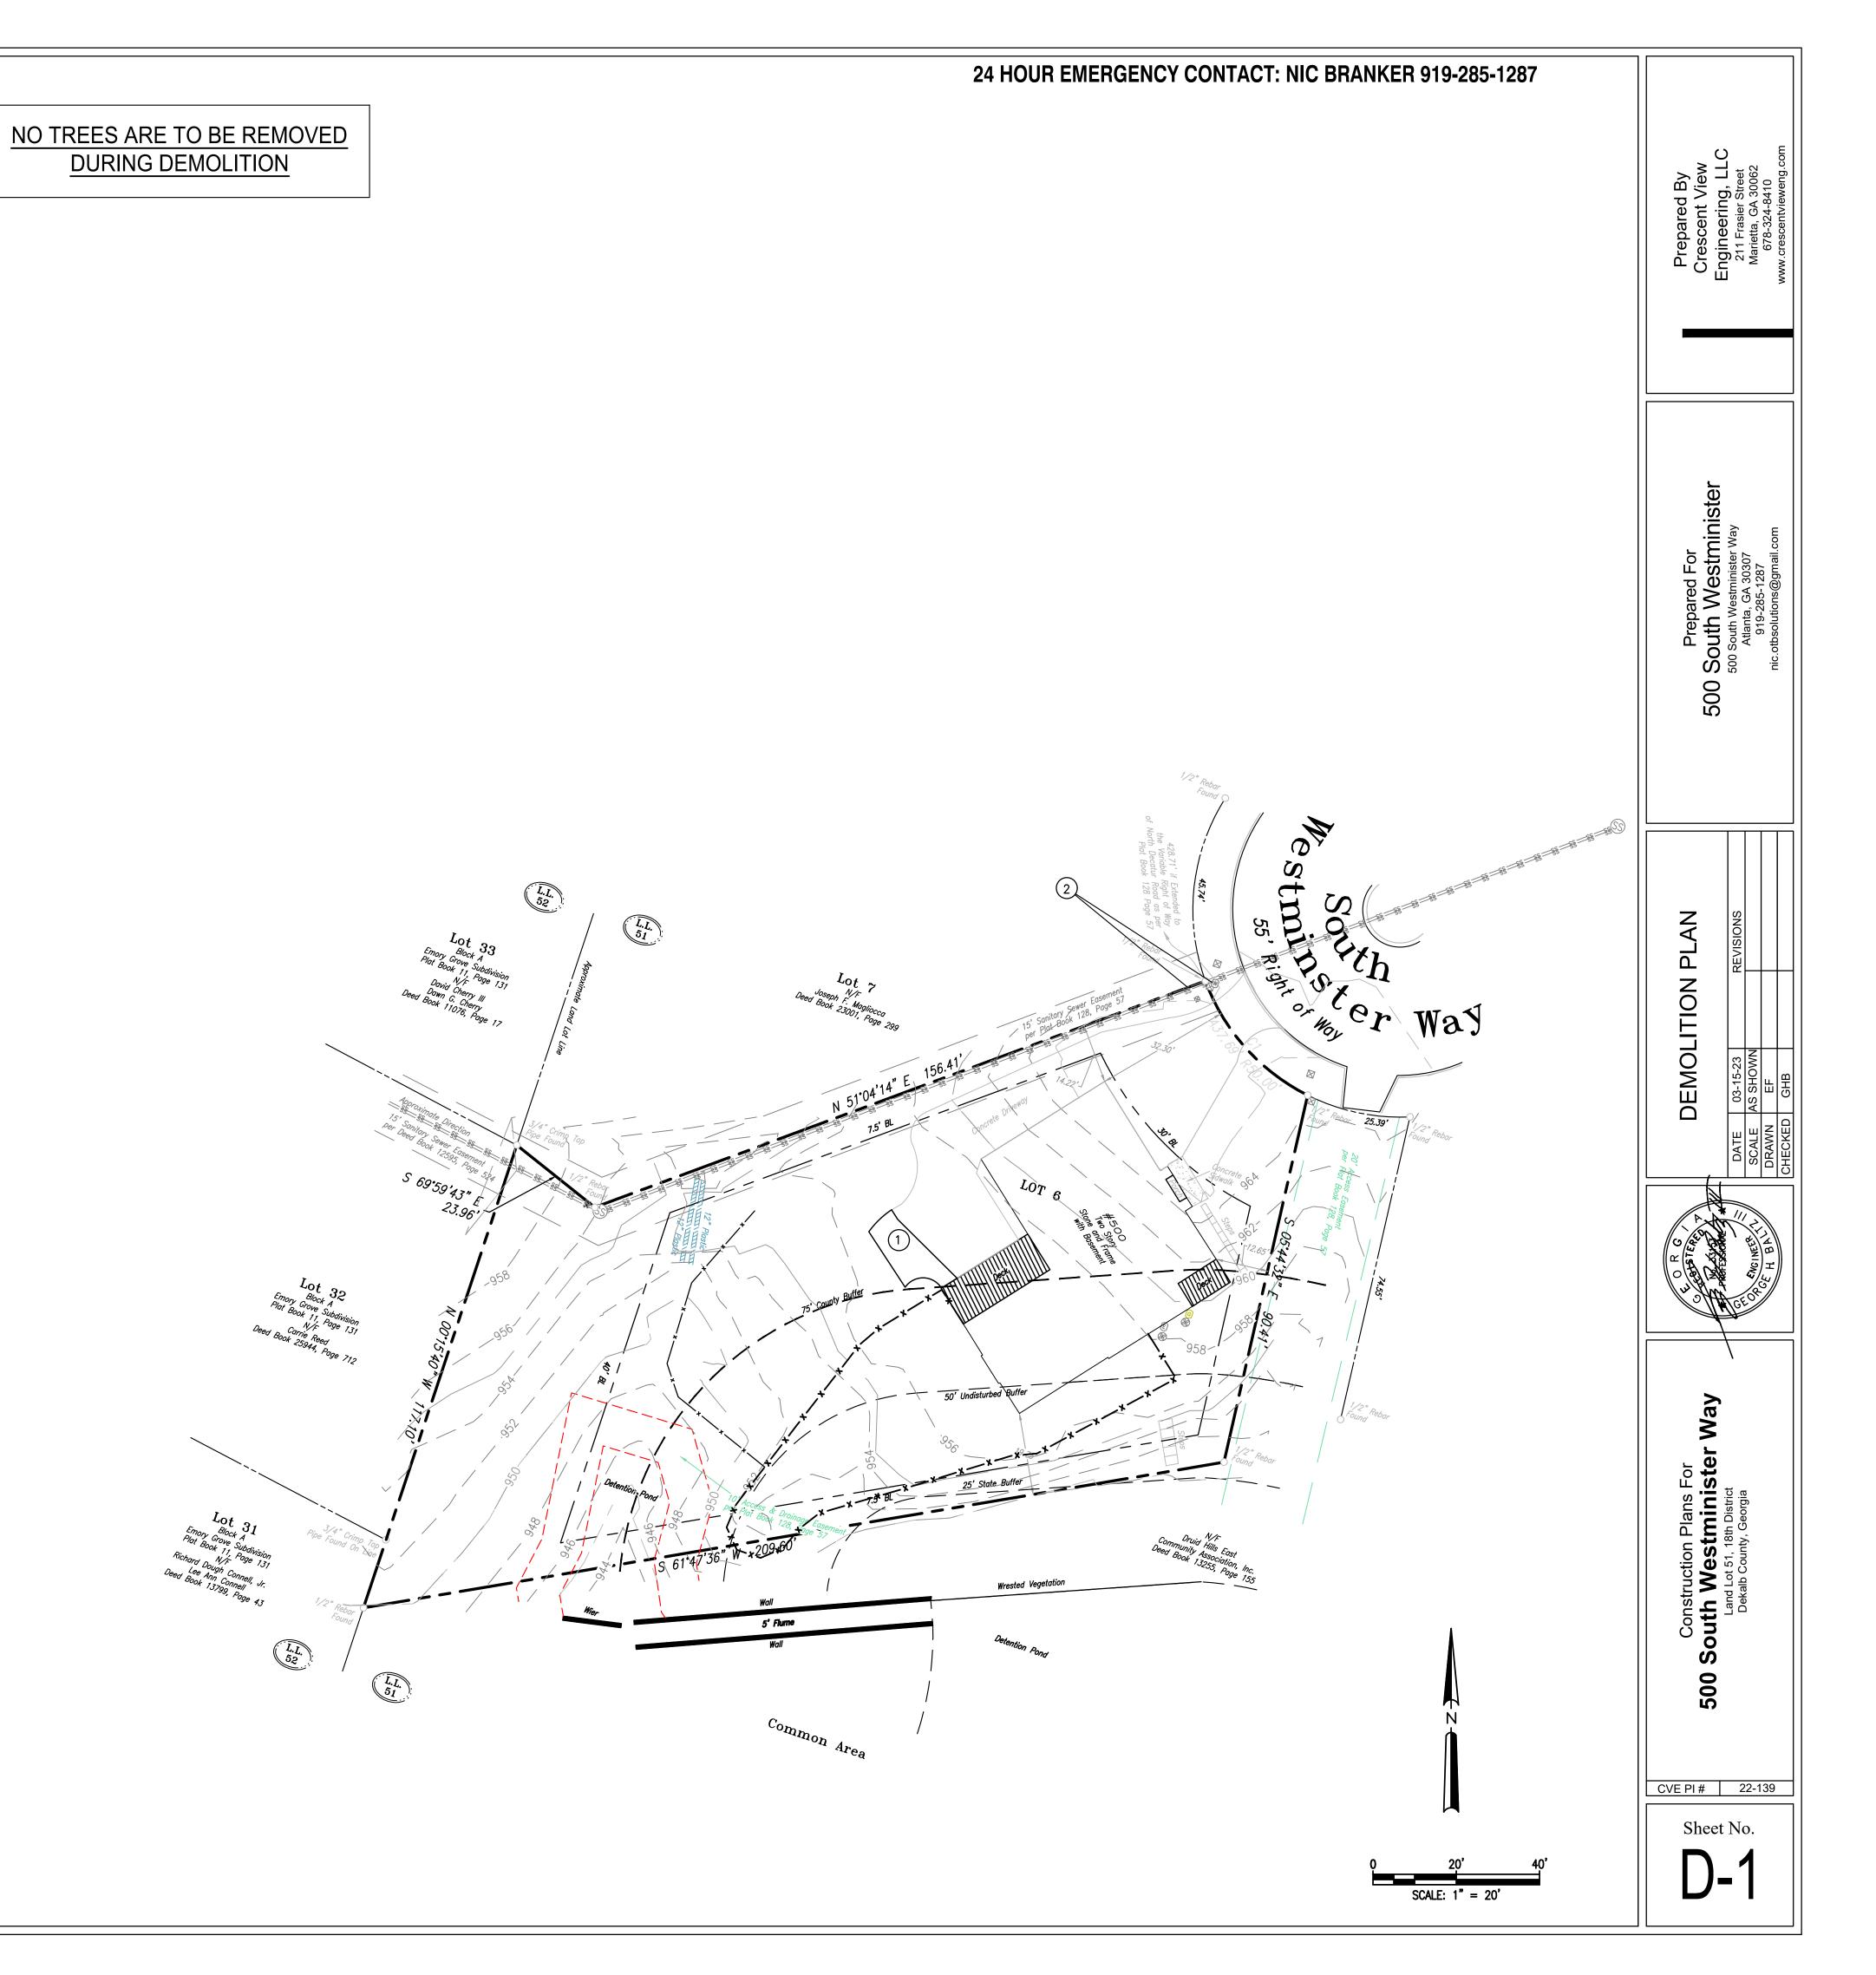STREAM BUFFER CALCULATIONS:

Stream Buffer Encroachment Chart				
Buffer / Impervious Setback	Pre Construction (SF)	Post Construction (SF)	Difference (SF)	
State Buffer: 0'-25'	0	0	0	
Undisturbed Buffer : 25'-50'	86	86	0	
County Buffer: 50'-75'	1144	1728	584	

24 HOUR EMERGENCY CONTACT: NIC BRANKER 919-285-1287



Know what's **below.** Call before your

ZONING CONFORMANCE:

SITE ZONING: R-75 (RESIDENTIAL MEDIUM LOT-75) DISTRICT MINIMUM LOT SIZE: 10,000 SF

LOT WIDTH: 75 FEET, MIN AT STREET
75 FEET, MIN AT BUILDING LINE

35 FEET, MIN FOR CULDESAC
FRONT SETBACK: 45 FEET MIN (THOROUGHFARES)

35 FEET MIN (ARTERIALS)
30 FEET MIN (COLLECTOR AND ALL OTHERS)
25 FEET MIN (ALLEY ACCESS)

SIDE SETBACK: 7.5 FEET REAR SETBACK: 40 FEET

LOT COVERAGE: SHALL NOT EXCEED 35% FLOOR AREA: NO LESS THAN 1600 SQ FEET


OFF-STREET PARKING: 2 SPACES
BUILDING HEIGHT: NO MORE THAN 35 FEET

OPEN SPACE: 20%

STATEWATER STATEMENT:

THIS PROPERTY IS NOT LOCATED INSIDE DESIGNATED F.I.A SPECIAL FLOOD HAZARD AREA AS PER THE FLOOD INSURANCE RATE MAP #13089C0066K, DATED AUGUST 15, 2019.

THERE ARE WATERS OF THE STATE OF GEORGIA LOCATED ON OR WITHIN 200 FEET OF THE SITE. ALL APPROPRIATE STATE WATER BUFFERS ARE SHOWN ON THE SITE PLANS.

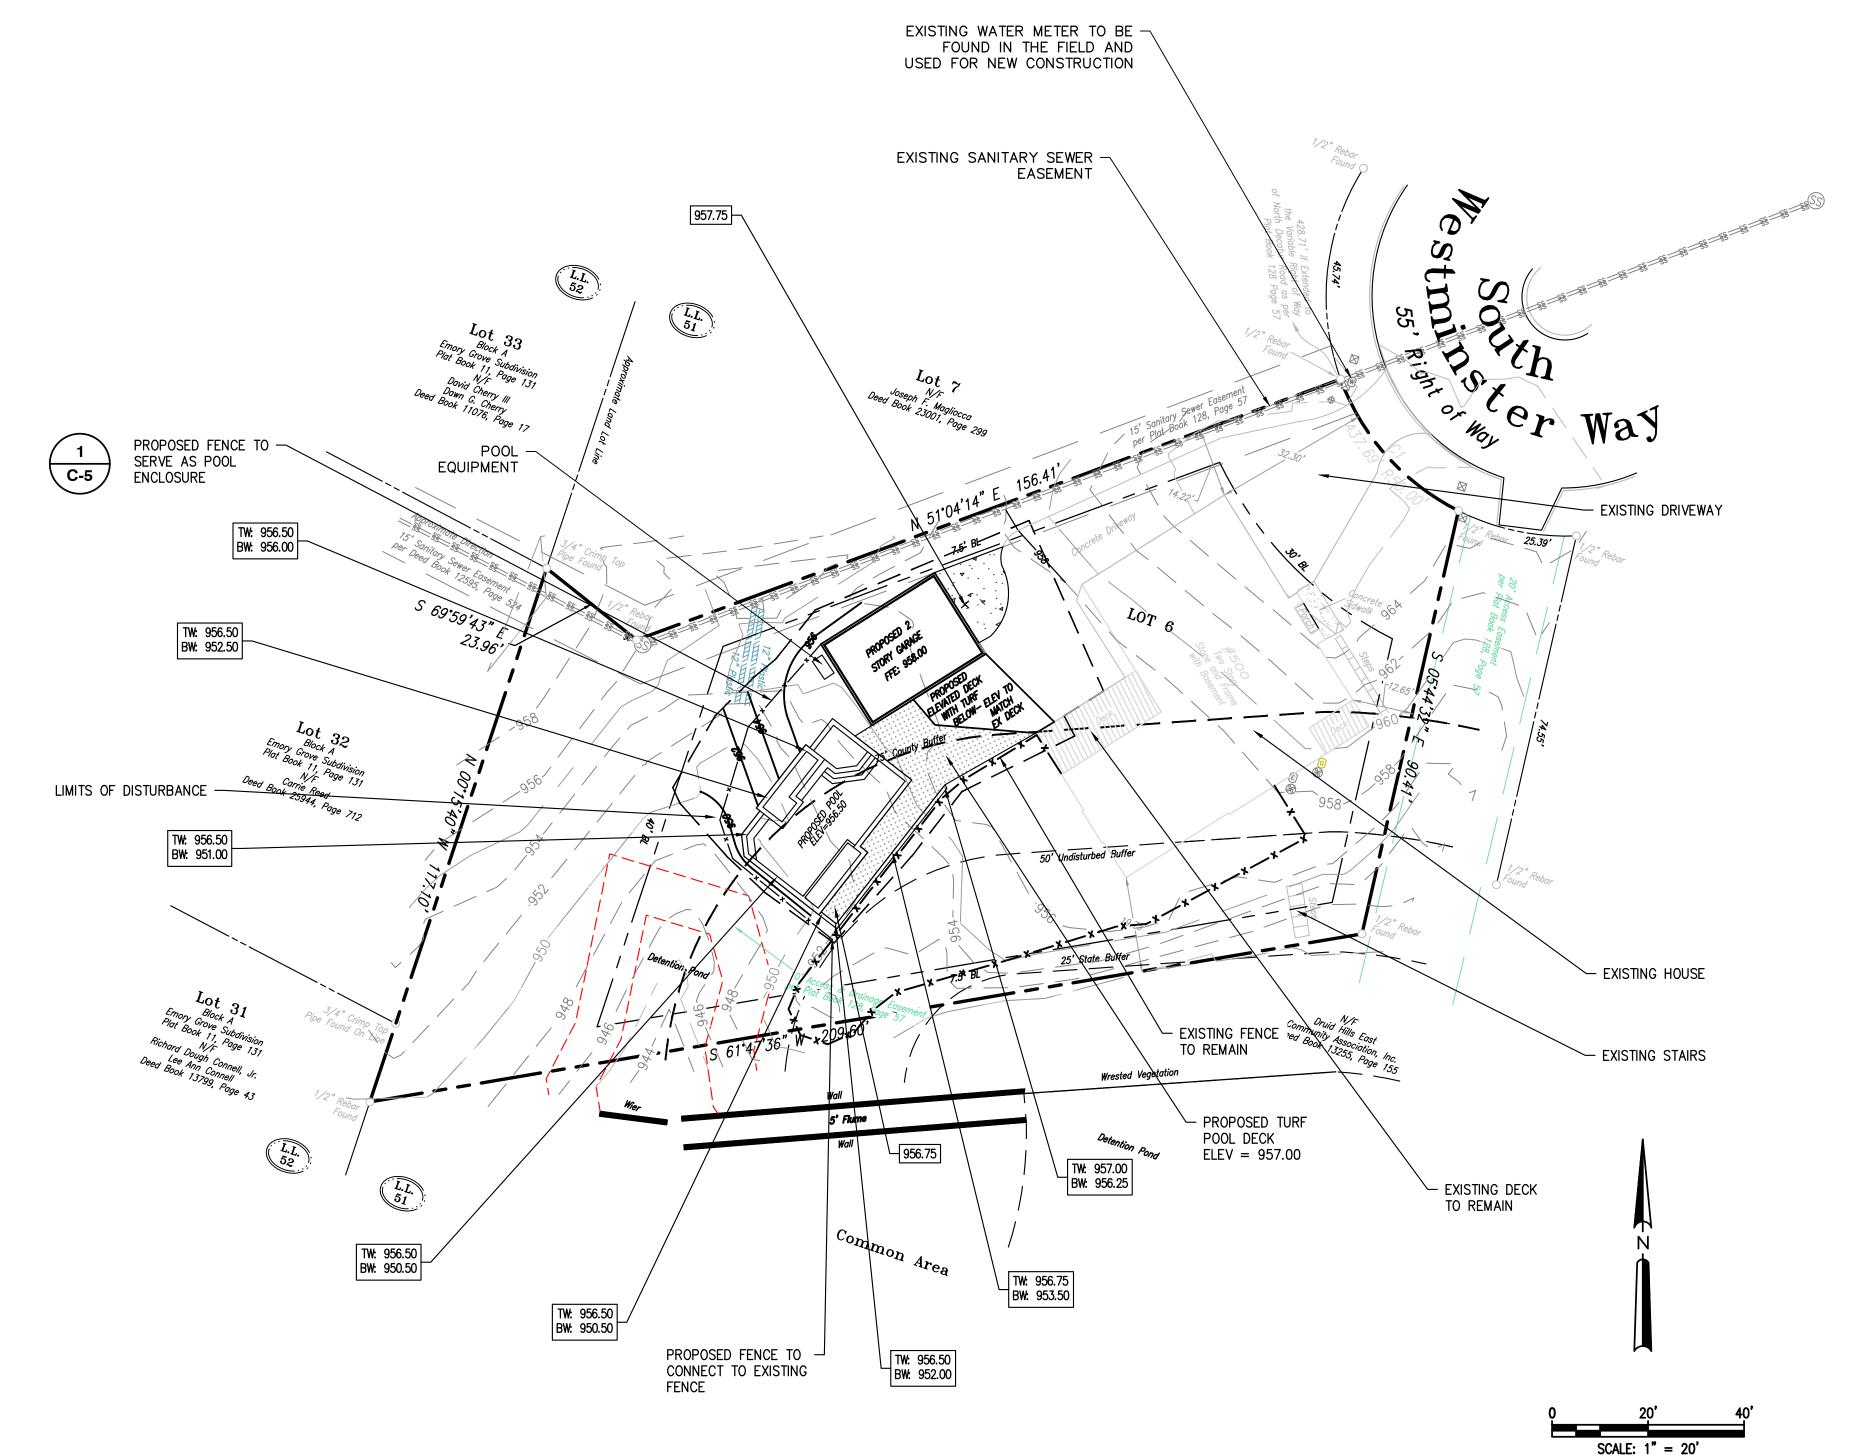

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SITE PLAN

DATE 03-15-23 REVISIONS
SCALE AS SHOWN
DRAWN EF

CET OR GENERAL STANDARD OF THE STANDARD OF THE

Construction Plans For **500 South Westminister Way**Land Lot 51, 18th District
Dekalb County, Georgia

Sheet No.

CVE PI # 22-139

WATER QUALITY NOTES:

<u>VEGETATION</u>
THE TRENCH IS NORMALLY COVERED WITH TOPSOIL AND MANAGED TURF OR OTHER HERBACEOUS VEGETATION. AS AN ALTERNATIVE, THE AREA ABOVE THE SURFACE OF A TRENCH MAY BE COVERED WITH PEA GRAVEL (OR LARGER DEPENDING ON THE INFLOW RATES) TO ALLOW FOR INCIDENTAL LATERAL INFLOW ALONG THE EDGE OF GROUND LEVEL IMPERVIOUS SURFACES. THE DOWNSTREAM END OF THE PIPE MUST BE STABILIZED AND CAN BE LANDSCAPED FOR AESTHETICS.

MAINTENANCE

- INSPECT GUTTERS AND DOWNSPOUTS REMOVING ACCUMULATED LEAVES AND DEBRIS, CLEANING LEAF REMOVAL
- SYSTEM(S). • IF APPLICABLE, INSPECT PRETREATMENT DEVICES FOR SEDIMENT ACCUMULATION.
- INSPECT THE TRENCH FOLLOWING A LARGE RAINFALL EVENT TO INSURE OVERFLOW IS OPERATING AND FLOW IS NOT CAUSING PROBLEMS.

CONSTRUCTION STEPS

- REVIEW POTENTIAL TRENCH AREAS AND LAYOUT. THE TRENCH SHOULD SLOPE BETWEEN 0.5% AND 6% AWAY FROM THE STRUCTURE AND SHOULD NOT BE LOCATED: (1.) BENEATH AN IMPERVIOUS (PAVED) SURFACE; (2.) ABOVE AN AREA WITH A WATER TABLE OR BEDROCK LESS THAN TWO FEET BELOW THE TRENCH BOTTOM; (3.) OVER OTHER UTILITY LINES; OR (4.) ABOVE A SEPTIC FIELD. INSURE OUTLET DAYLIGHTS AT LEAST TEN FEET FROM PROPERTY LINE.
- IF SOIL IS A CONCERN PERFORM INFILTRATION TEST. IF THE RATE IS LESS THAN 0.25 IN/HR THIS METHOD CANNOT BE USED. IF THE RATE IS MORE THAN 0.50 IN/HR THE LENGTH OF THE DITCH MAY BE DECREASED 10% FOR EVERY 0.50 IN/HR INFILTRATION RATE INCREASE ABOVE 0.50 IN/HR
- MEASURE ELEVATIONS AND LAY OUT THE TRENCH TO THE REQUIRED DIMENSIONS MARKING THE ROUTE AND REQUIRED EXCAVATION DEPTHS. OFTEN A LEVEL LINE (TORPEDO LEVEL) IS USED.
- PLACE AND TAMP GRAVEL IN DITCH TO PLANNED DEPTH PLACING THE PIPE THREE INCHES DEEP IN THE UPPER PORTION OF THE GRAVEL, THEN PLACE AND GENTLY TAMP GRAVEL UNTIL IT COVERS THE PIPE.
- PLACE DRAINAGE FABRIC OVER TOP OF PIPE AND STONE.
- PLACE TOPSOIL AND SOD OR PEA GRAVEL.
- CUT AND ROUTE DOWNSPOUTS OR OTHER RAINWATER DELIVERY COMPONENTS. ADD STRAP AND SUPPORT AS
- CREATE A SAFE OVERFLOW AT LEAST 10 FEET FROM YOUR PROPERTY EDGE AND INSURE IT IS PROTECTED. FROM EROSION.

WATER QUALITY CALCULATIONS:

POST-CONSTRUCTION LOT COVERAGE				
AREA	SF	NOT/TREATED	BMP LOCATION	
EXISTING HOUSE	2561	NOT TREATED	N/A	
EXISTING DECKS	317	NOT TREATED	N/A	
REMAINING CONCRETE DRIVEWAY	2106	NOT TREATED	N/A	
EXISTING CONCRETE SIDEWALK	50	NOT TREATED	N/A	
EXISTING FRONT PORCH	13	NOT TREATED	N/A	
EXISTING STAIRS	63	NOT TREATED	N/A	
PROPOSED GARAGE	560	TREATED	TRENCH	
PROPOSED DRIVEWAY ADDITION	190	TREATED	TRENCH	
PROPOSED POOL	760	TREATED	TRENCH	
PROPOSED DECK	260	TREATED	TRENCH	
PROPOSED TURF DECK/WALKWAY	0	NOT TREATED	N/A	
PROPOSED WALL	45	TREATED	TRENCH	
PROPOSED POOL EQUIPMENT	15	TREATED	TRENCH	
TREATED IMPERVIOUS AREA	1830	SF		
TOTAL IMPERVIOUS AREA	6940	SF		

Water Quality / Runoff Reduction	Calcula	<u>itions</u>
Per GSWMM Section 2.2.4.1		
Water Quality Volume (WQv)		
Runoff Reduction (RRv)		
Site Area (A) =	20152	SF
Treated Impervious Area =	1830	SF
% impervious (I) =	10	%
RRv = (P.Rv.A)/12	235	CF
Rv = 0.05 + I*(0.009)	0.140	
WQv = 1.2*Rv*A/12	282.1	CF


STONE STORAGE INFILTRATION TRENCH W/ P	IPE CALCU	<u>LATIONS</u>	
WQ Calculations		1.2" required for required area impervious	
Required Treated Impervious Area =	1830.0	SF	
Required WQ Volume =	282.1	CF	
Pipe Volume			
Diameter of Pipe	3.0	FT	
Length of Pipe	18.0	FT	
Volume of Pipe	127.2	CF	
Gravel Volume	n tronch wi	th 40% void	
All volume to be provided in stone storage infiltration. Length of Trench	18.0	FT VOIG	
Width of Trench	8.0	FT	
Depth of Trench	4.0	FT	
Volume of Gravel = ((L x W x D) - Pipe Vol) x 0.4 =	179.5	CF	
Provided Volume = Gravel Vol + Pipe Vol =	306.7	CF	
Required Volume =	282.1	CF	
Percent of provided volume over required	109%		


WATER QUALITY DESCRIPTION:

WATER QUALITY IS PROVIDED FOR THE NEW IMPERVIOUS AREA OF 1,830 SF, WHICH INCLUDES THE PROPOSED GARAGE, POOL, AND DECK. SEE LOT COVERAGE CHART ON THIS PAGE.

THE STONE STORAGE TRENCH WILL DETAIN FOR A TOTAL OF 1,830 SF. THE TRENCH IS TO BE FILLED WITH #57 STONE (40% VOID RATIO). THE TOTAL REQUIRED VOLUME OF THE UNDERGROUND STONE STORAGE TRENCH IS 282.1 CUBIC FEET. THE TOTAL PROVIDED VOLUME OF THE UNDERGROUND STONE STORAGE TRENCH IS 306.7 CUBIC FEET. THE POSITION OF THE TRENCH IS SUCH THAT IT IS AT LEAST 10 FEET AWAY FROM THE STRUCTURES AND PROPERTY LINES. THE TRENCH IS 18 FT LONG, 8 FT WIDE, AND 4 FT DEEP. THE TRENCH CONTAINS A 3 FT DIAMETER PIPE.

THE WATER QUALITY VOLUMES PROVIDED BY THE BMP SHOWN EXCEED THE WQ STORAGE REQUIREMENTS.

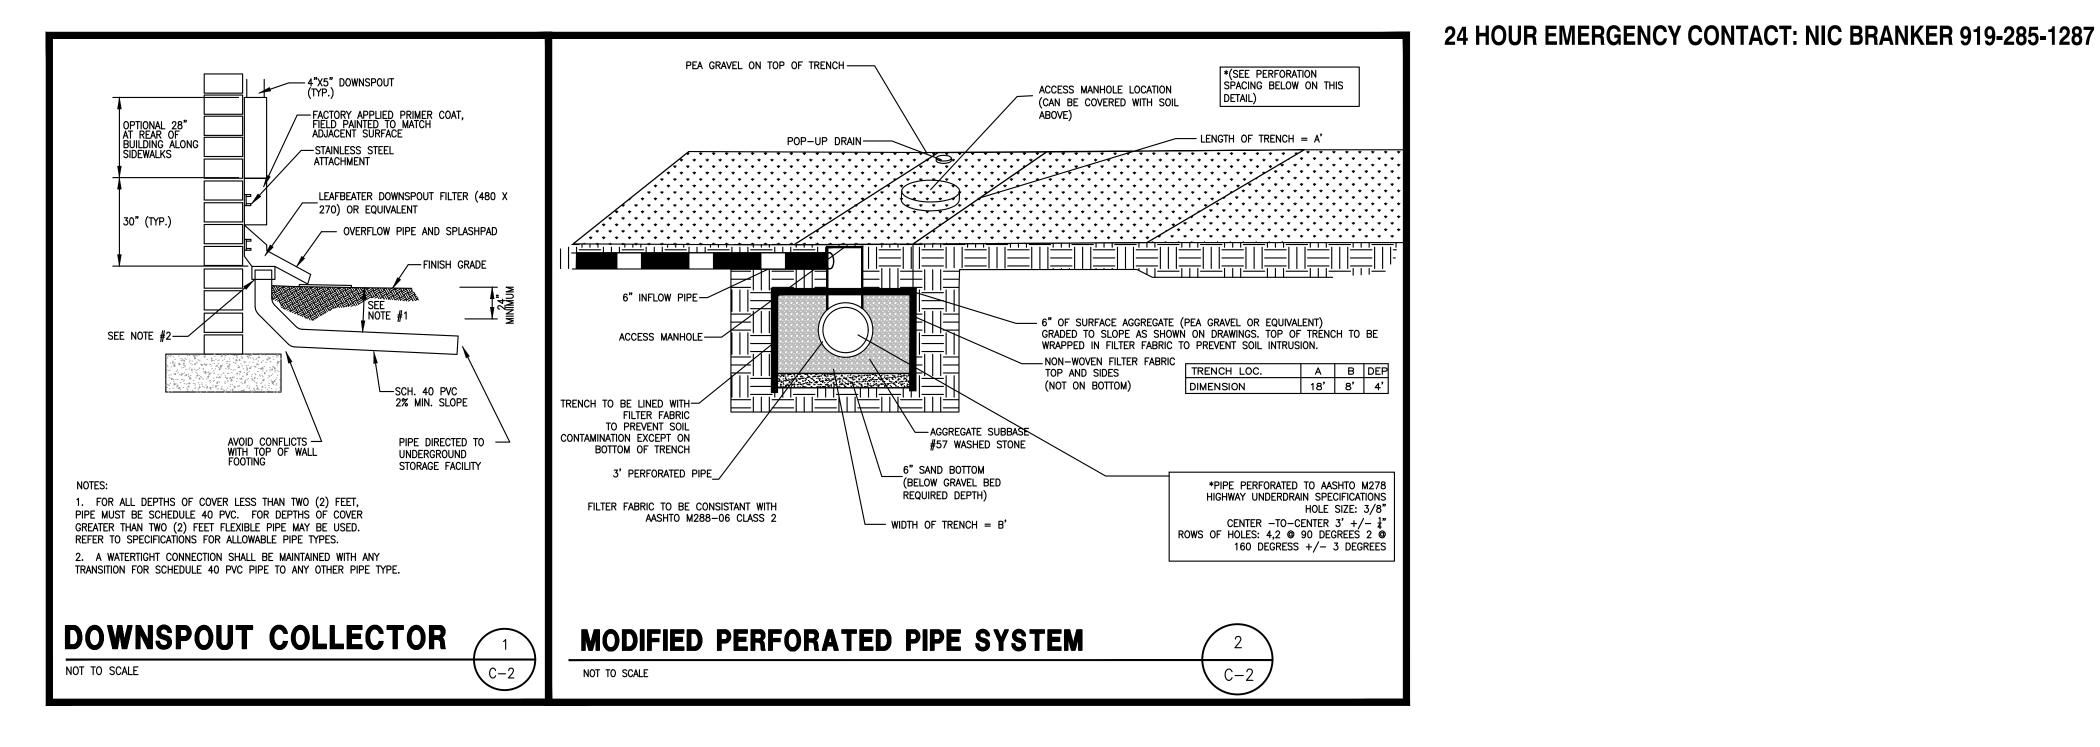

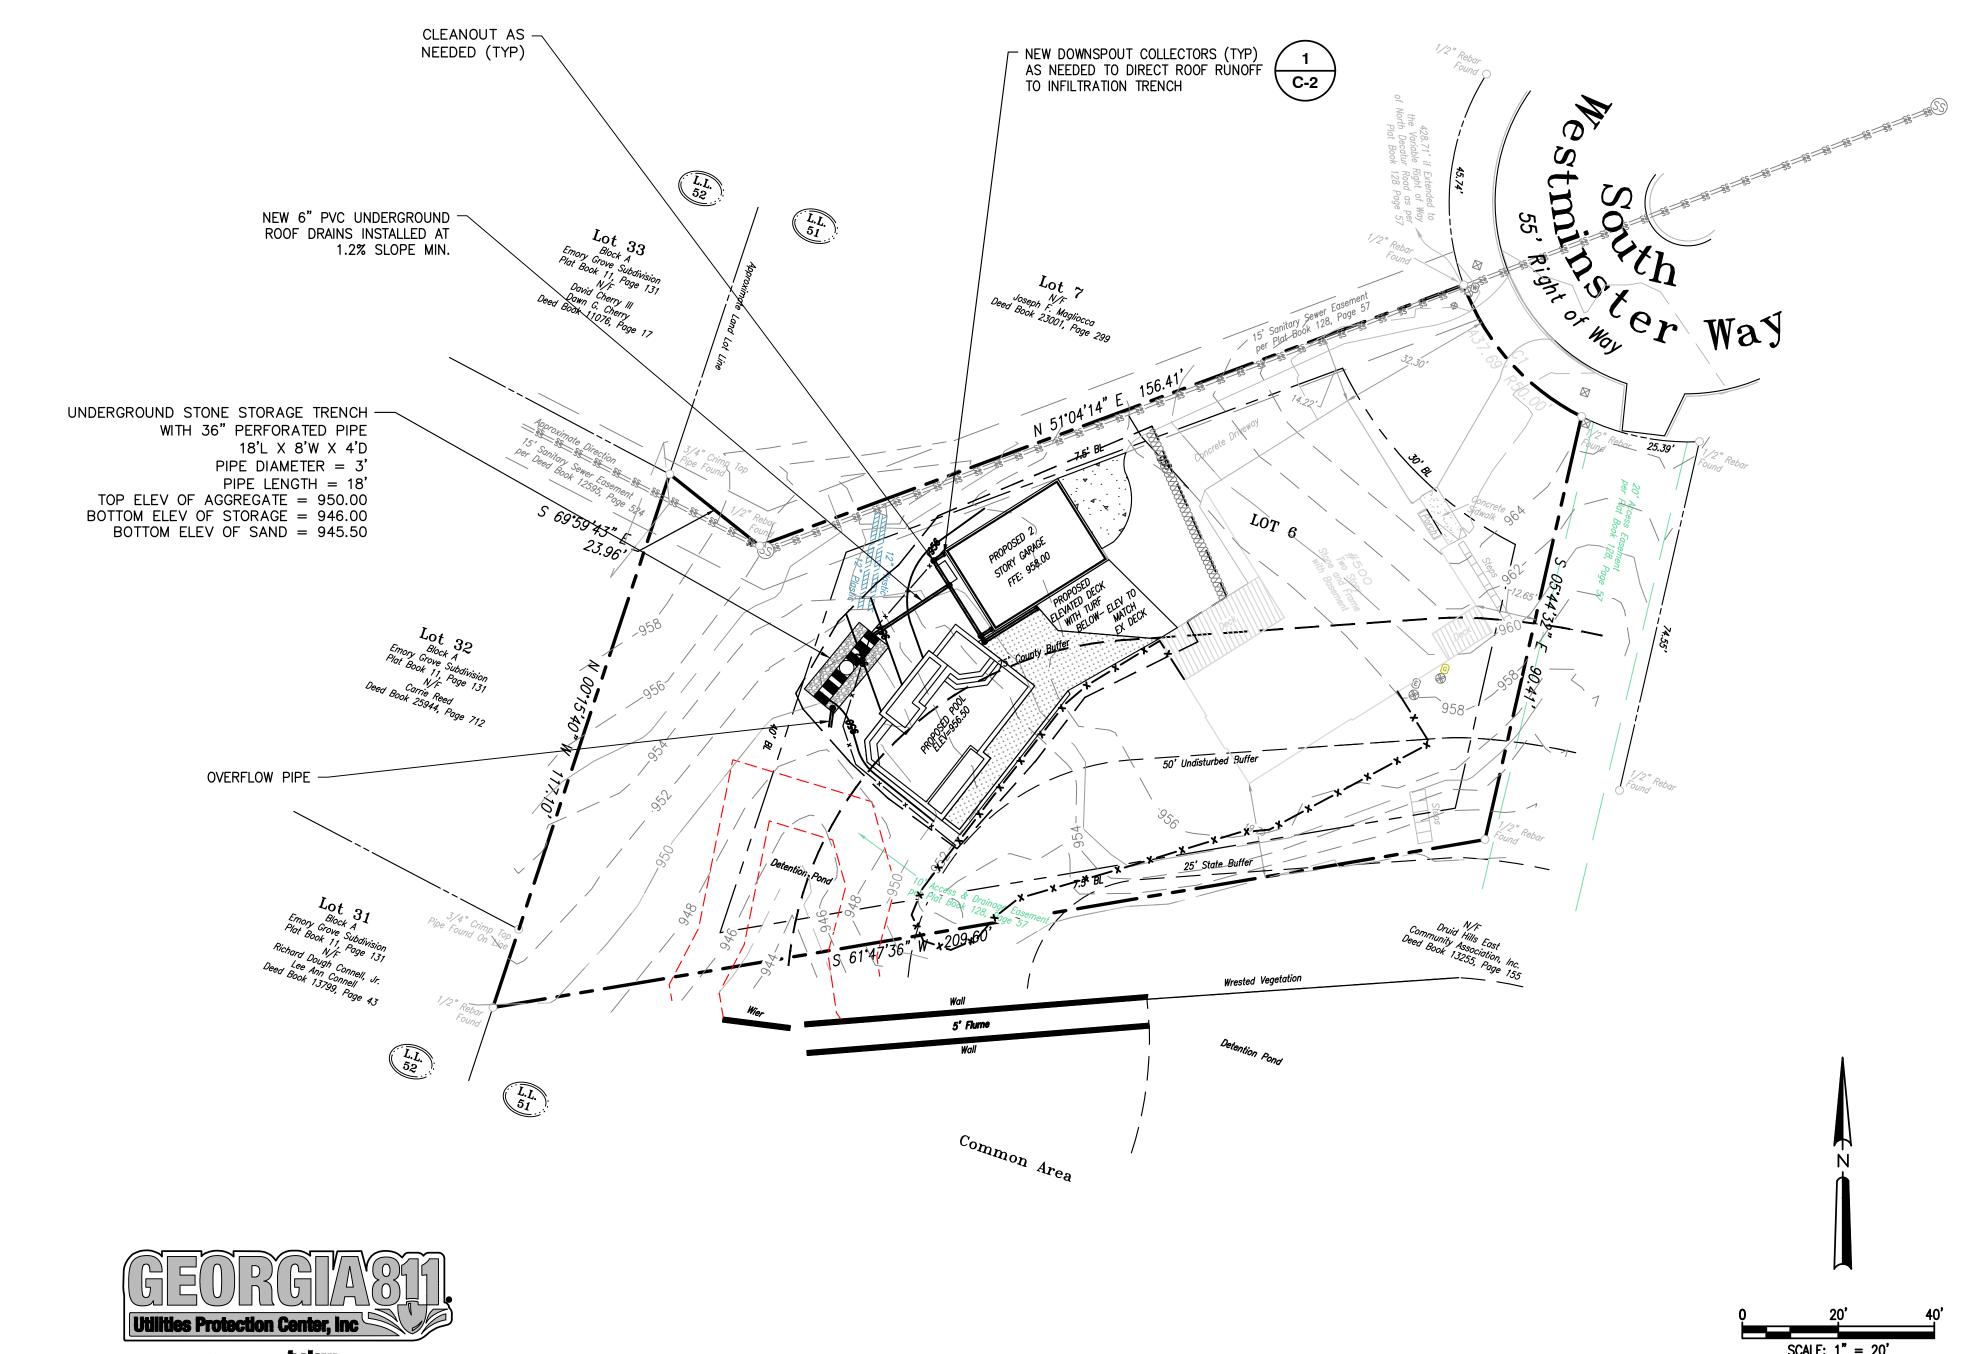

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GRADING NOTES:

- APPROVED EROSION CONTROL DEVICES MUST BE INSTALLED PRIOR TO ANY DETENTION BMP INSTALLATION (NOT PART OF THIS PLAN)
- 2. SURVEY INFORMATION TAKEN FROM SURVEYS PERFORMED BY GEORGIA LAND SURVEYING, CO, DATED 1-28-19
- 3. DISCOVERY OF UNSUITABLE SOILS OR ROCK MUST BE IMMEDIATELY REPORTED TO THE OWNER AND ENGINEER. ALL EARTHWORK MUST NOT PROCEED AT THAT POINT UNTIL OWNER RELEASES THE CONTRACTOR TO PROCEED.
- 4. THE CONTRACTOR IS SPECIFICALLY CAUTIONED THAT THE LOCATION OF UTILITIES AND/OR ELEVATION OF EXISTING UTILITIES AS SHOWN ON THESE PLANS ARE BASED ON RECORDS PROVIDED TO THE ENGINEER. INFORMATION SHOWN IS NOT TO BE RELIED ON AS BEING EXACT OR COMPLETE. THE CONTRACTOR MUST CALL THE APPROPRIATE UTILITY COMPANY AT LEAST 48 HOURS BEFORE ANY EXCAVATION TO REQUEST EXACT FIELD LOCATION OF UTILITIES.
- 5. CONTRACTOR SHALL FOLLOW ALL APPLICABLE SAFETY AND CONSTRUCTION PROCEDURES, ORDINANCES, CODES, AND STANDARDS.
- 6. CONTRACTOR SHALL CONTACT THE UTILITY LOCATOR AS REQUIRED BY GEORGIA LAW AND HAVE ALL UTILITIES MARKED PRIOR TO ANY CONSTRUCTION ACTIVITY. CONTRACTOR WILL HAVE PRIVATE UTILITY LOCATOR LOCATE ALL UTILITIES WITHIN THE CONSTRUCTION LIMITS NOT COVERED BY THE UTILITY PROTECTION CENTER.
- 7. ALL ELEVATIONS SHOWN ARE FINISHED GRADE.
- 8. THE APPROXIMATE LOCATION OF KNOWN UNDERGROUND UTILITIES HAVE BEEN SHOWN AS PROVIDED BY THE SURVEY. IT SHALL BE THE GENERAL CONTRACTOR'S RESPONSIBILITY TO FIELD VERIFY, LOCATE AND PROTECT ALL UTILITIES ON THE SITE. THE CONTRACTOR SHALL ALSO BE RESPONSIBLE FOR COORDINATING DEMOLITION, RELOCATION AND NEW UTILITY SERVICE WITH THE APPROPRIATE UTILITY, CONTRACTOR SHALL HIRE THEIR OWN UTILITY LOCATOR TO IDENTIFY ALL EXISTING UTILITIES WITHIN THE PROPOSED CONSTRUCTION AREA. ALL EXISTING SANITARY SEWER CONNECTIONS TO BE IDENTIFIED AND CONNECTED TO NEW SANITARY SEWER LINES.
- BEFORE STARTING WORK CONTRACTOR SHALL MAKE SUCH EXPLORATIONS AND PROBES AS NECESSARY TO ASCERTAIN ANY ACTIVE UTILITY LINES AND MAKE SURE THESE UTILITIES CAN BE BROKEN OR CHANGED WITHOUT ANY DANGER OR DISRUPTION TO ANY NECESSARY SERVICE.
- 10. CONTRACTOR SHALL COMPLY TO THE FULLEST EXTENT WITH THE LATEST STANDARDS OF OSHA DIRECTIVES OR ANY OTHER AGENCY HAVING JURISDICTION FOR EXCAVATION AND TRENCHING PROCEDURES. THE CONTRACTOR SHALL SUPPORT SYSTEMS, SLOPING, BENCHING, AND OTHER MEANS OF PROTECTION. THIS TO INCLUDE, BUT IS NOT LIMITED TO ACCESS AND EGRESS FROM ALL EXCAVATION AND TRENCHING. CONTRACTOR IS RESPONSIBLE TO COMPLY WITH PERFORMANCE CRITERIA FOR OSHA.

ES&PC NOTES:


- 1. THE CONSTRUCTION STAGING AREA WILL BE THE PROPOSED DRIVEWAY AND SHALL BE MAINTAINED IN A CONDITION WHICH WILL PREVENT ANY POTENTIAL TRACKING OF MUD ONTO PUBLIC STREETS.
- 2. SILT FENCES AND HAY BALE BARRIERS SHALL BE CLEANED OR REPLACED AND MAINTAINED IN FUNCTIONAL CONDITION UNTIL PERMANENT EROSION CONTROL MEASURES ARE ESTABLISHED.
- 3. SILT FENCE FABRIC SHALL BE COMPRISED OF GA. DOT QUALIFIED PRODUCTS LIST 36, FOR SILT FENCE FABRIC.
- 4. ALL GRASSING SHALL BE IN ACCORDANCE WITH CHAPTER 6, SECTION III "VEGETATIVE PRACTICES" OF THE MANUAL FOR EROSION AND SEDIMENT CONTROL IN GEORGIA.
- 5. ALL OTHER WORK SHALL BE PERFORMED IN ACCORDANCE WITH THIS SAME MANUAL.
- 6. THE CONTRACTOR SHALL CLEAN OUT ALL ACCUMULATED SILT FROM THE SILT FENCING AND REMOVE THE FENCING FROM THE SITE ONCE ALL DISTURBED AREAS ARE STABILIZED WITH PERMANENT VEGETATION.
- 7. EROSION CONTROL DEVICES WILL BE IN PLACE BEFORE SITE DISTURBANCE AND WILL BE PERIODICALLY INSPECTED AND REPAIRED OR RESTORED AS NEEDED TO FUNCTION PROPERLY UNTIL PERMANENT MEASURES ARE ESTABLISHED AND PROJECT IS COMPLETE, I.E.: CONSTRUCTION EXITS AND SILT FENCES SHALL BE RE-TOPPED OR CLEANED AS SILT REDUCES THEIR EFFECTIVENESS.
- 8. ANY ADDITIONAL CONSTRUCTION OTHER THAN SHOWN ON THIS PLAN WILL REQUIRE SEPARATE AND ADDITIONAL EROSION AND SEDIMENT CONTROL MEASURES AND APPROVAL.
- 9. TEMPORARY VEGETATION AND/OR HEAVY MULCH WILL BE USED TO STABILIZE AREAS. IN NO CASE SHALL A SITE BE LEFT BARE FOR MORE THAN TWO WEEKS.
- 10. ALL DISTURBED AREAS WILL BE PERMANENTLY LANDSCAPED AND GRASSED AS SOON AS CONSTRUCTION PHASES PERMIT
- 11. ALL WORK SHALL BE PERFORMED IN ACCORDANCE WITH THE SPECIFICATION OF THE MANUAL FOR EROSION AND SEDIMENT CONTROL IN GEORGIA.
- 12. ADDITIONAL MEASURES MAY BE REQUIRED TO CONTROL EROSION AS DETERMINED NECESSARY BY INSPECTORS. THE EROSION CONTROL MEASURE CAN BE DESIGNED BY A LEVEL 1B (BLUE CARD) GASWCC CERTIFIED CONTRACTOR, UNLESS THE BMP HAS A HYDRAULIC COMPONENT. FOR ALL BMP DESIGN WITH A HYDRAULIC COMPONENT, THE BMP MUST BE DESIGNED BY A LEVEL 2 (GOLD CARD) GASWCC CERTIFIED DESIGNER. A CONSTRUCTION EXIT IS NOT PROPOSED DUE TO THE SMALL SIZE OF THE PROJECT AND THE LEVEL 1B CONTRACTOR MUST PROVIDE ALL MEASURES TO PREVENT ANY SILT FROM ENTERING THE STREAM BUFFER.

SEDIMENT STORAGE CALCULATIONS:

SILT FENCE PROVIDED = 205 LINEAR FEET OF SILT FENCE

SEDIMENT STORAGE REQUIRED = 0.10 DISTURBED AREA X 67 = 6.37 CY SEDIMENT STORAGE PROVIDED = 205 FT SILT FENCE X 0.05 = 10.25 CY




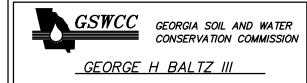

CERTIFICATION NUMBER: 0000045830 ISSUED: 09/25/2007 EXPIRES: 11/10/2025



24 HOUR EMERGENCY CONTACT: NIC BRANKER 919-285-1287

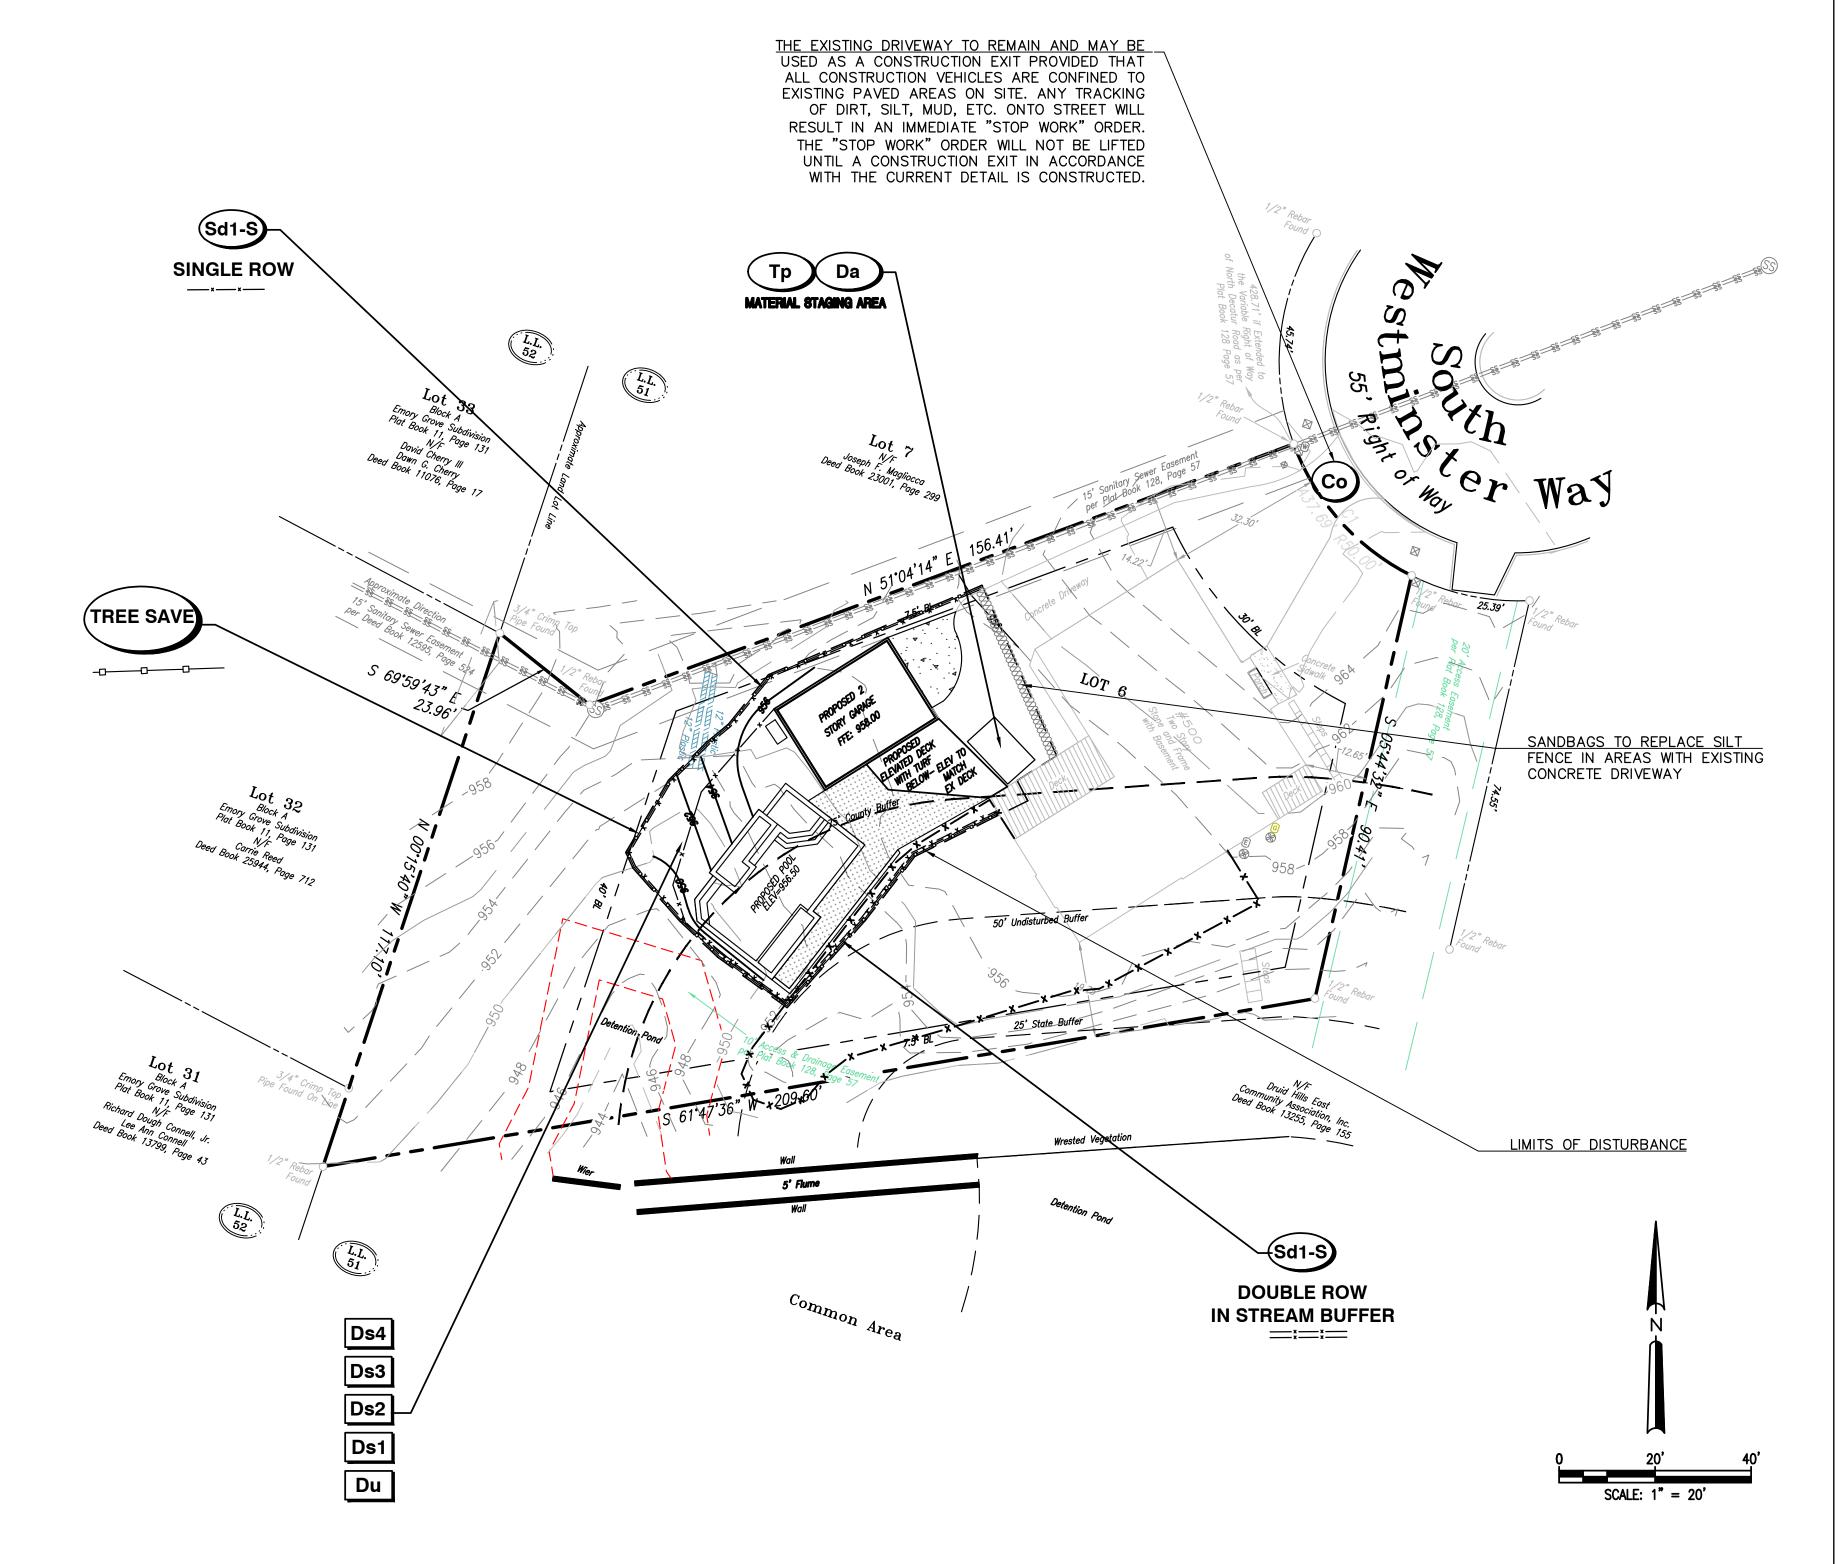

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CVE PI # 22-139

ONSITE TREE CALCULATIONS:

ONSITE	TREES
TREE LIST - ONSITE PRIO	R TO CONSTRUCTION
TOTAL TREES	16
TOTAL INCHES	208
TOTAL UNITS	55
ONCITE LOCT (DEC	TROVED TREES
ONSITE LOST/DES	
Size (Inches)	Туре
8	HARDWOOD
TOTAL INCLES	1
TOTAL INCHES	8
TOTAL UNITS	2.4
ONSITE TREES SAVED WITH	LESS THAN 20% IMPACT
Size (Inches)	Туре
9	HARDWOOD
24	HARDWOOD
18	HARDWOOD
TOTAL TREES	3
TOTAL INCHES	51
TOTAL UNITS	13.2
ONSITE TREES SAVED	WITH NO IMPACT
Size (Inches)	Туре
12	HARDWOOD
12	HARDWOOD
11	HARDWOOD
8	HARDWOOD
8	HARDWOOD
8	HARDWOOD
12	HARDWOOD
16	HARDWOOD
12	HARDWOOD
9	HARDWOOD
22	PINE
19	PINE
TOTAL TREES	12
TOTAL INCHES	149
TOTAL UNITS	39.4
ONICITE CDECIMAENT TO	AFFEC IN AD A CT (> 200/)
ONSITE SPECIMENT TR Size (Inches)	<u> </u>
	Type
N/A	N/A
TOTAL INCLES	0
TOTAL UNITS	0
TOTAL UNITS	0

TREES TO REMAIN = 200"

MINIMUM DENSITY REQUIREMENT MET WITH EXISTING TREES

SITE DENSITY REQUIRED = 120" X 0.463 ACRES = 55.6"

BOUNDARY TREE CALCULATIONS:

BOUNDARY TREES		
BOUNDARY TREES SAVED WITH LESS THAN 20% IMPACT		
Size (Inches)	Туре	
60	HW	
19	HW	
12	HW	
9	HW	
20	PINE	
TOTAL TREES	5	
TOTAL INCHES	120	
TOTAL UNITS	43.6	
BOUNDARY SPECIMEN TREES SAVED WITH LESS THAN 20% IMPACT		
Size (Inches)	Туре	
10	HW	
TOTAL TREES	1	
TOTAL INCHES	10	
TOTAL UNITS	3.2	
BOUNDARY TREES LOST/DESTROYED		
Size (Inches)	Туре	
N/A	N/A	
TOTAL TREES	0	
TOTAL INCHES	0	
TOTAL UNITS	0	



DEKALB COUNTY TREE NOTES:

1. ALL TREE PROTECTION AREAS TO BE PROTECTED FROM SEDIMENTATION.
2. ALL TREE PROTECTION DEVICES TO BE INSTALL PRIOR TO LAND DISTURBANCE AND MAINTAINED UNTIL FINAL LANDSCAPING.

3. ALL TREE PROTECTION FENCING TO BE INSPECTED DAILY AND REPAIRED OR REPLACED AS NEEDED.
4. NO PARKING, STORAGE OR OTHER CONSTRUCTION ACTIVITIES TO OCCUR WITHIN TREE PROTECTION AREAS OR WITHIN SIX (6) FEET OF THE CRZ.

5. ALL REQUIRED VEGETATION MUST BE MAINTAINED FOR TWO GROWING SEASONS AFTER DATE OF FINAL INSPECTION.


DEKALB COUNTY NOTES:

24 HOUR EMERGENCY CONTACT: NIC BRANKER 919-285-1287

- 1. NO ONE SHALL ENCROACH, PLACE SOLVEMENTS, BUILDING, MACHINERY, BUILDING DEBRIS OR ANY OTHER MATERIAL WITHIN 6' OUTSIDE THEE PERIPHERY OF THE CRZ OR WITHIN ANY TREE SAVE AREA TRANSITIONAL BUILDER ZONE STREAM BUILDER OR STATE BUILDER ZONE
- SAVE AREA, TRANSITIONAL BUFFER ZONE, STREAM BUFFER, OR STATE BUFFER ZONE.

 2. ALL TREE FENCE AND OTHER TREE PROTECTION DEVICES MUST REMAIN IN FUNCTIONING
- CONDITION UNTIL COMPLETION OF THE PROJECT OR UNTIL THE CO IS ISSUED.

 3. A TREE THAT IS DESIGNATED TO BE SAVED, BUT IS DAMAGED DURING CONSTRUCTION, SHALL BE REPLACED WITH 4" CALIPER TREES EQUAL TO THE UNIT VALUE OF THE TREE REMOVED. ANY SPECIMEN TREE DAMAGED SHALL BE REPLACED WITH 4" CALIPER TREES EQUAL TO 1.5 TIMES THE DBH OF THE DAMAGED SPECIMEN.
- 4. ALL PROTECTION AREAS TO BE PROTECTED FROM SEDIMENTATION.
- 5. ALL TREE PROTECTION DEVICES, INCLUDING CRITICAL ROOTZONE(CRZ) PROTECTION, TO BE INSTALLED PRIOR TO THE START OF THE LAND DISTURBANCE, AND MAINTAINED UNTIL FINAL LANDSCAPING.
- 6. ALL TREE PROTECTION FENCING TO BE INSPECTED DAILY, AND REPAIRED OR REPLACED AS NEEDED.
- 7. NO PARKING, STORAGE OR OTHER CONSTRUCTION ACTIVITIES ARE TO OCCUR WITHIN TREE PROTECTION AREAS(CRZ).
- 8. ALL REQUIRED VEGETATION MUST BE MAINTAINED FOR TWO GROWING SEASONS AFTER THE DATE OF FINAL INSPECTION.
- 9. <u>THE PROTECTION SIGNS</u> ARE TO BE PLACED AT LEAST EVERY 50' ALONG THE LENGTH OF THE TREE PROTECTION FENCE. THE SIGNS SHOULD BE IN LANGUAGE SO THAT ALL WORKERS ON SITE ARE ABLE TO UNDERSTAND.

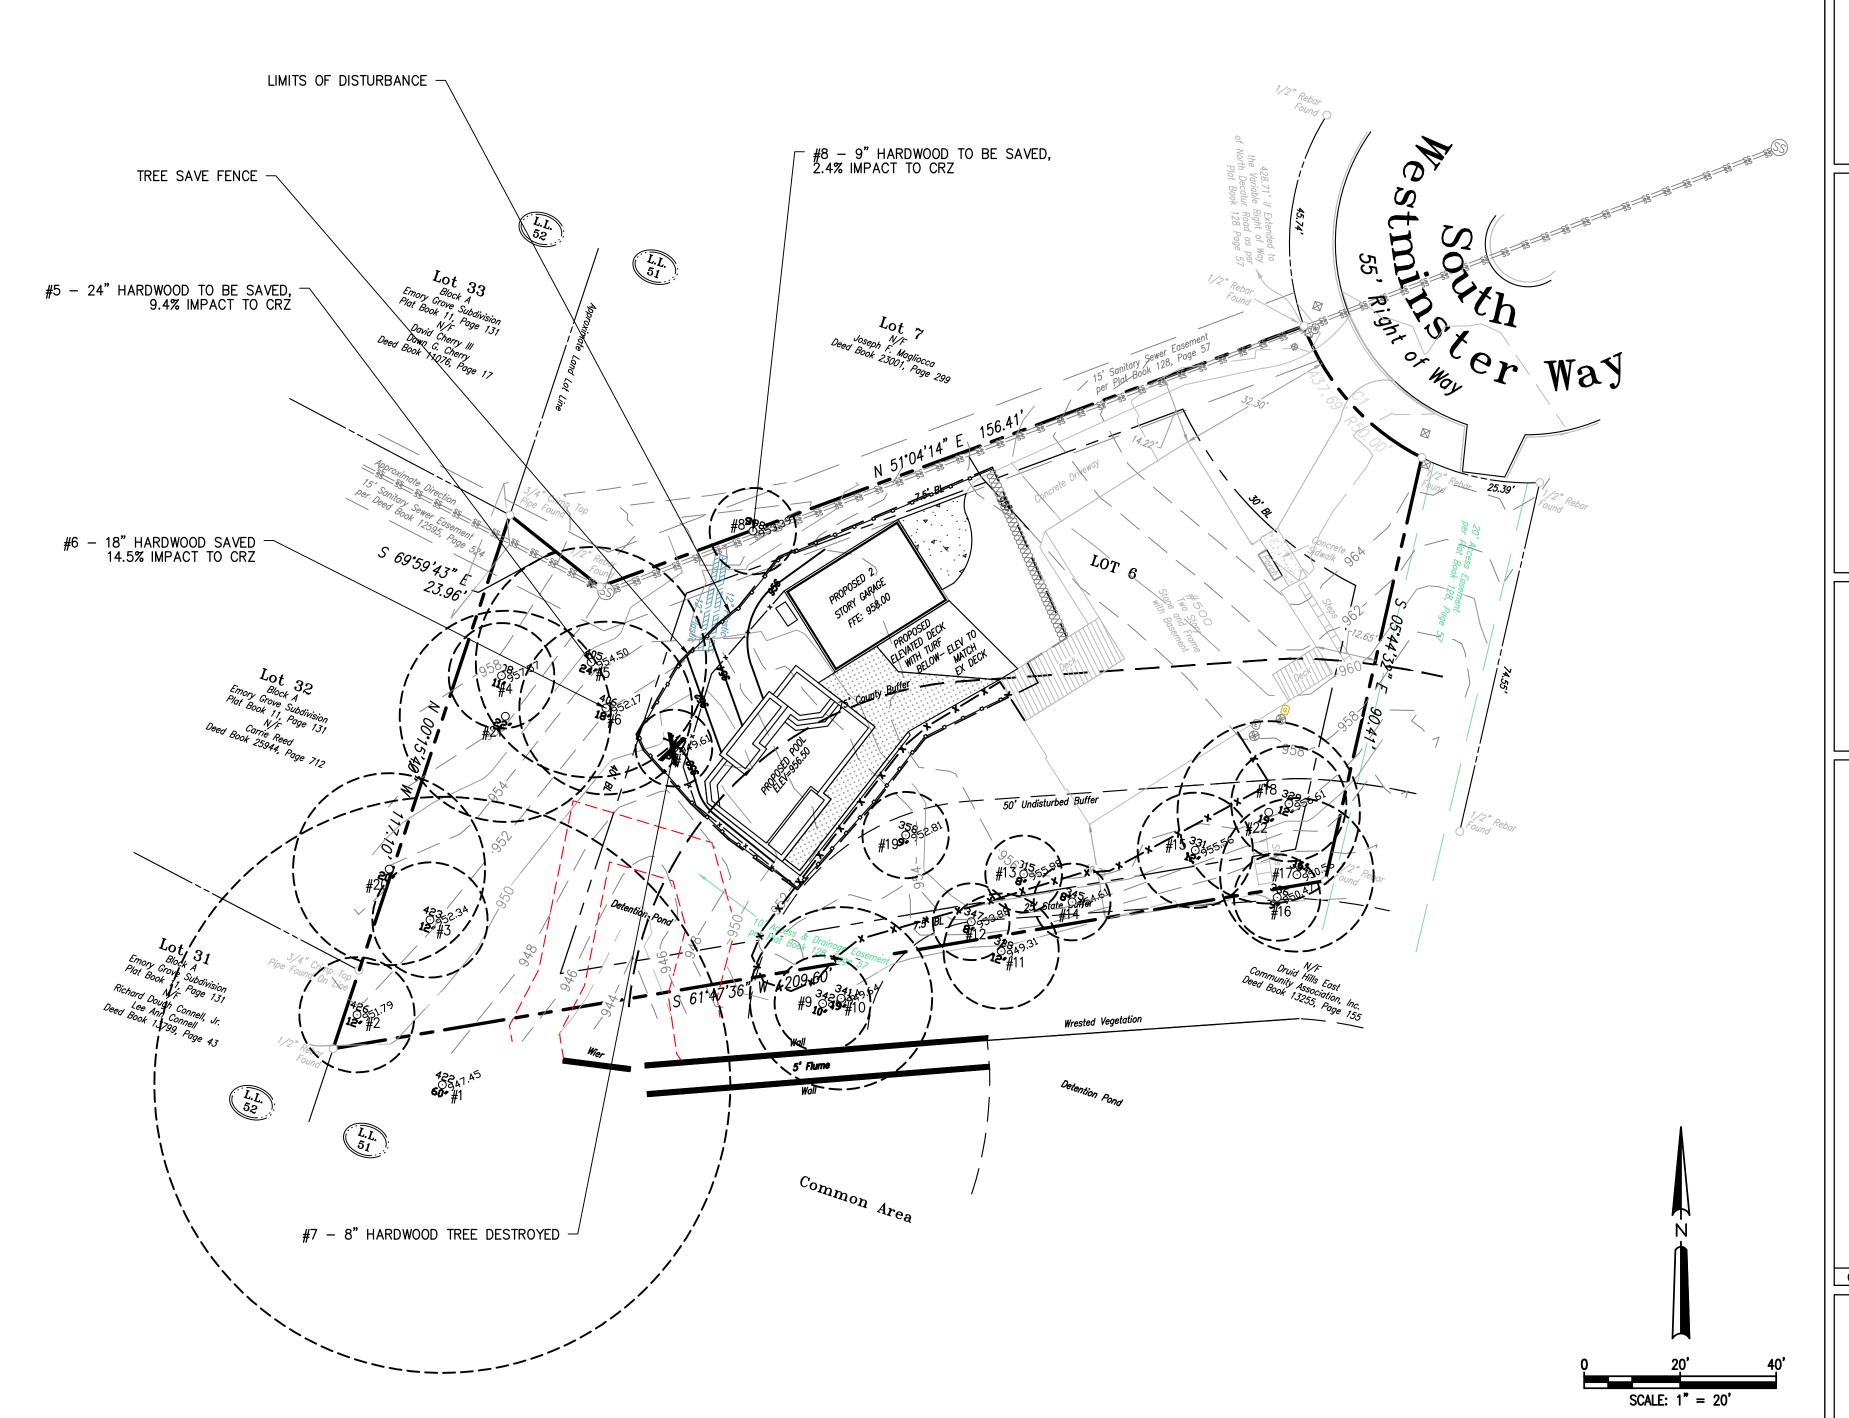

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TREE PLAN


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Construction Plans For **500 South Westminister Way** Land Lot 51, 18th District Dekalb County, Georgia

CVE PI # 22-139

Sheet No.

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5' HIGH DECORATIVE ALUMINUM FENCE

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CVE PI # 22-139
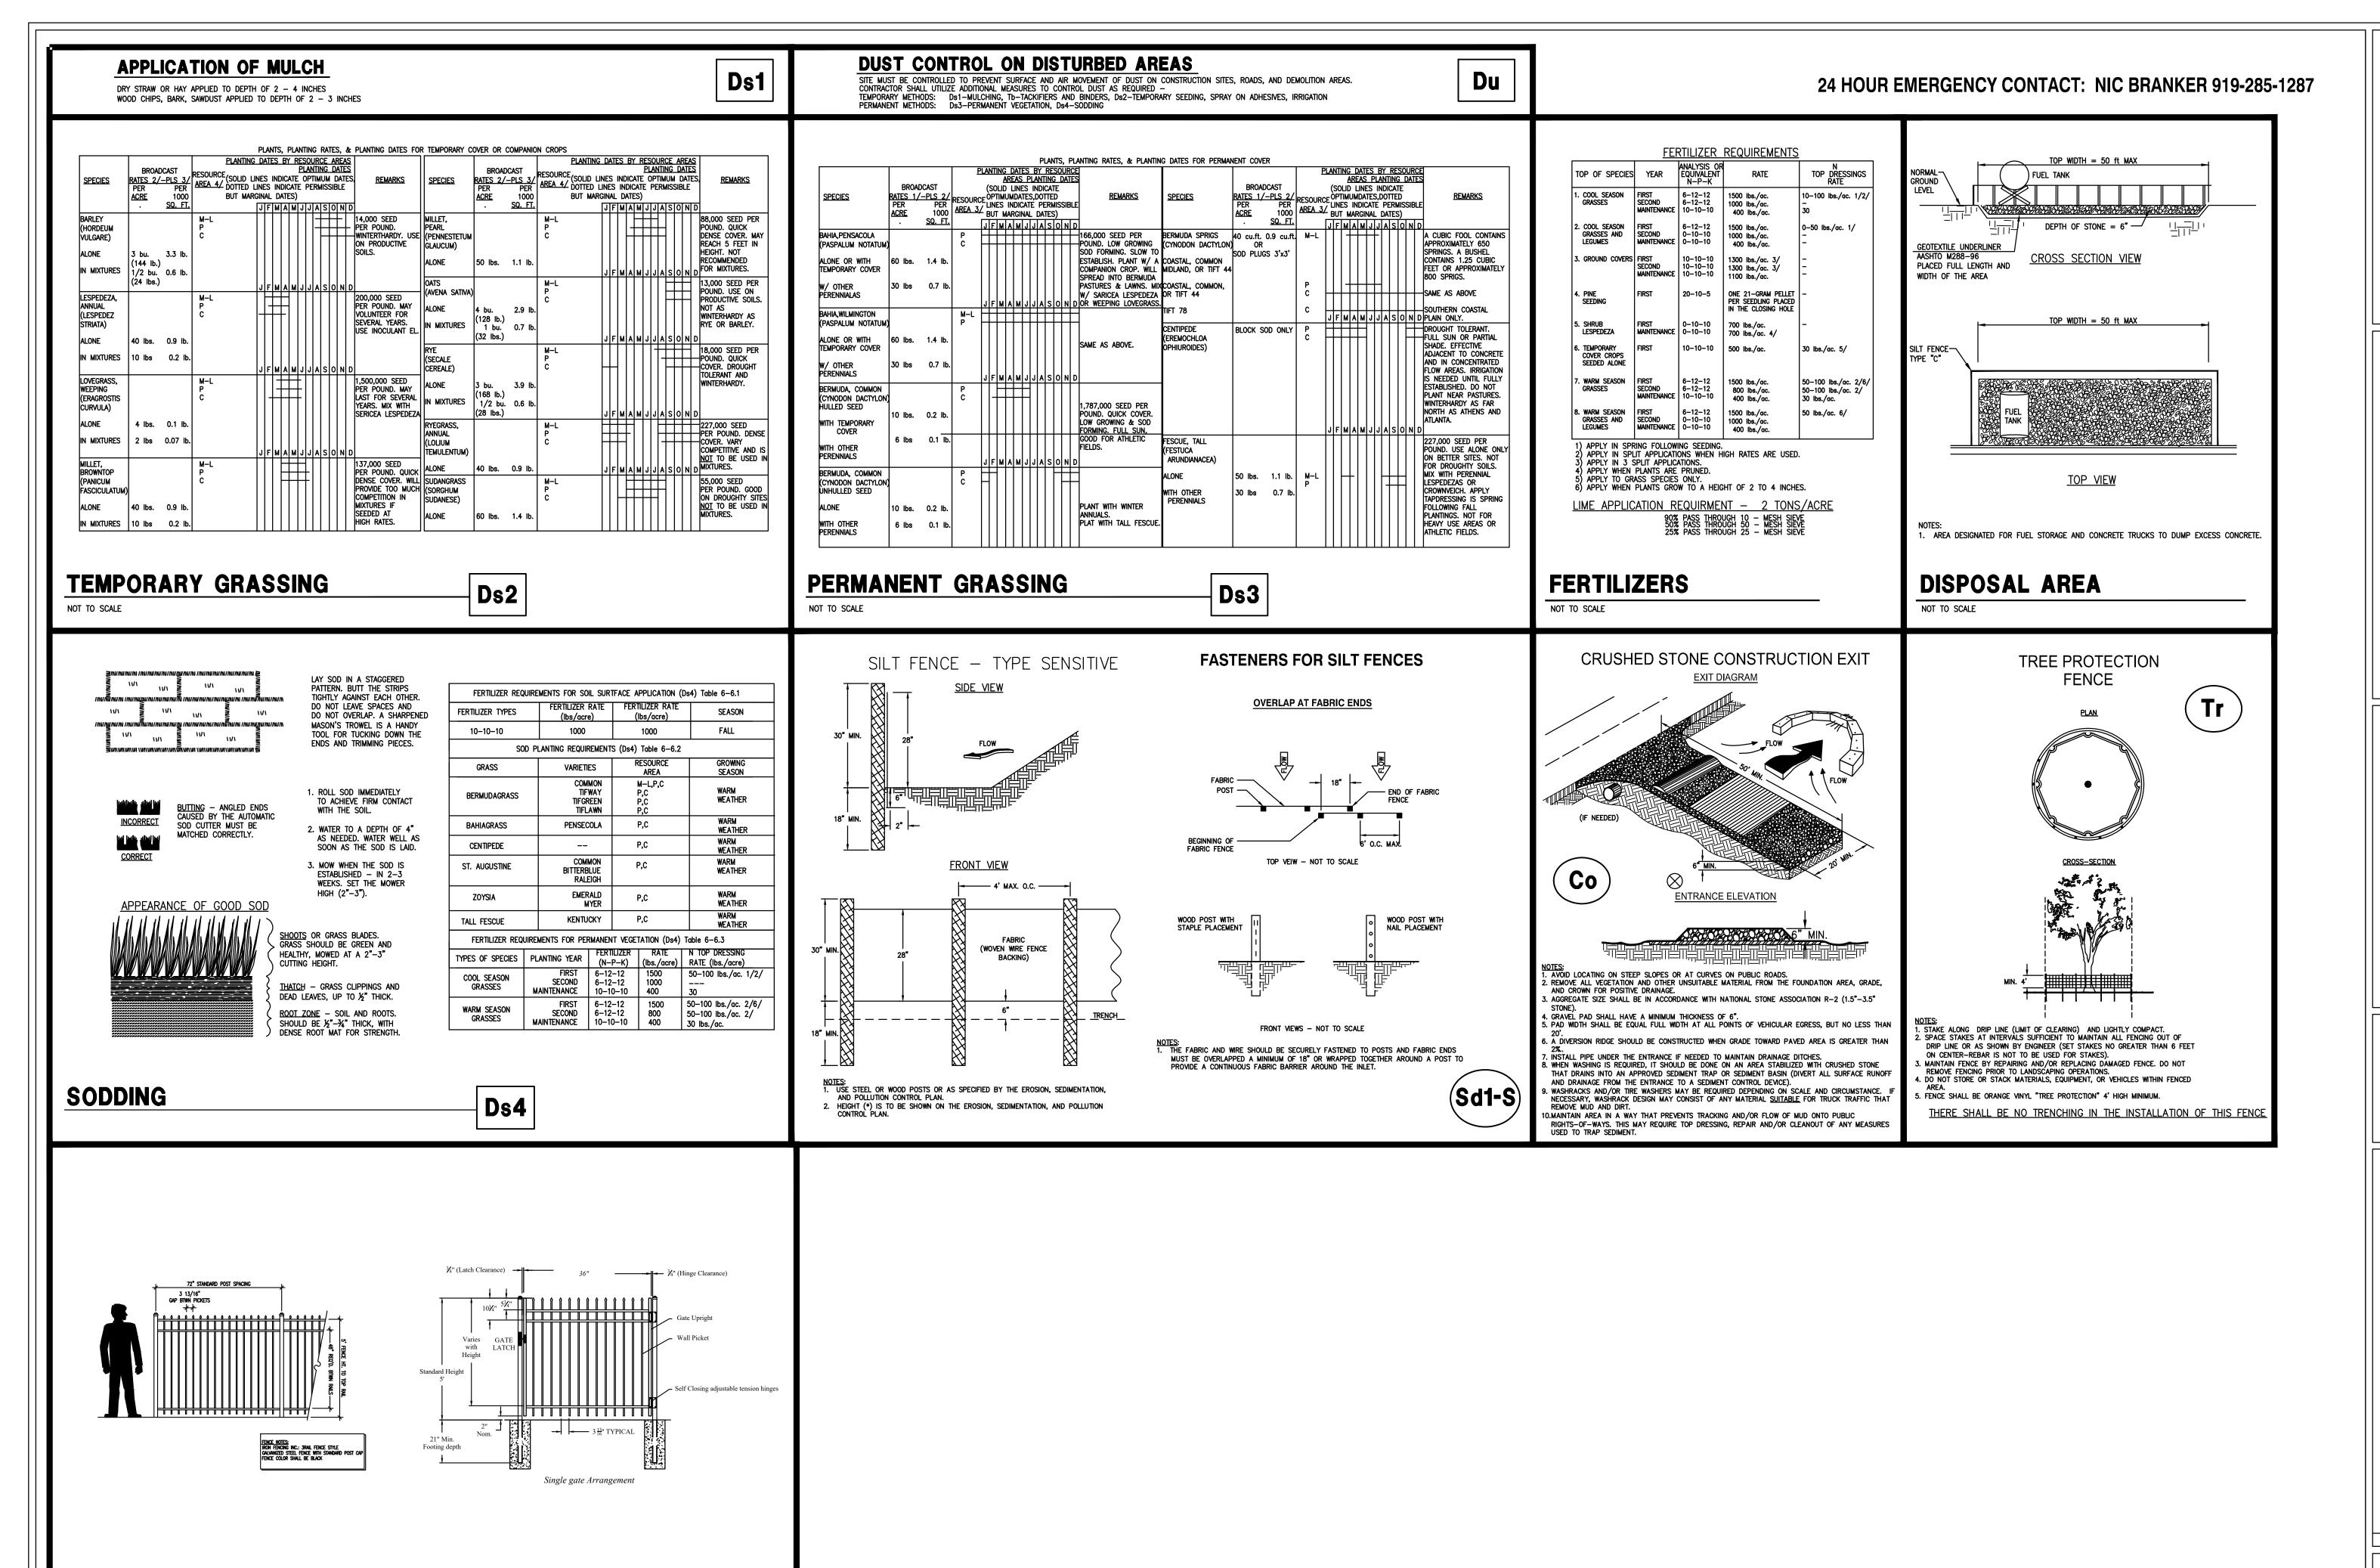
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