DeKalb County Historic Preservation Commission

Monday, March 18th, 2024- 6:00 P.M.

Staff Report

Consent Agenda

G. 449 Chelsea Circle, Lance Muller. Install driveway and parking pad, construct wall, and plant trees in front yard. **1246874.**

Built in 1936 (18 004 01 008)

This property is in the Chelsea Heights Character Area and is not in any National Register Historic Districts

- 11-22 449 Chelsea Circle, Robert Platt. Rear addition, modification of fenestration on front façade, front door replacement, window replacements, new deck(s). **Deferred.**
- 12-22 449 Chelsea Circle, Robert Platt. Replace the garage door with a wall and install retaining walls and a parking pad in the front yard. 1246162. **Deferred.**
- 01-23 449 Chelsea Circle, Robert Platt. Replace the garage door with a wall and install retaining walls and a parking pad in the front yard. 1246162. **Approved**
- 02-24 449 Chelsea Circle, Lance Muller. Install driveway and parking pad, construct wall, and plant trees in front yard. 1246874. **Partially Approved, Partially Deferred.**

Summary

March 2024

The applicant proposes an updated landscaping plan that including the planting of the following vegetation in the front yard, along the front and left property lines and the front façade of the main property:

- Red Bud (Cercis Canadensis)
- Dogwood (Cornius Florida)
- Sweet Bay Magnolia (Magnolia Virginiana)
- Oakleaf Hydrangea (Hydrangea Quercifolia)
- Wild Hydrangea (Hydrangea Arborescens)
- Inkberry (Ilex Glabra)
- Button Bush (Cephalanthus Occidentailis)
- Lead Plant (Amorpha Canescens)
- Canna Lilly (Canna Indica)
- Purple Cone Flower (Echinacea Purpurea)

Sod will be installed in the center portion of the front yard where the concrete roundabout walkway will be located. A $12'' \times 12''$ box drain will be installed in front the main property, near the front entrance and walkway.

February 2024

Applicant proposes a modified design for a previously approved retaining wall, parking pad, and landscaping in the front yard of property. The new design proposes installing a concrete driveway and square parking pad on the right-side of the front yard, parallel to the main house. A 3' poured-in-place concrete retaining wall will be installed to the left-side of the house to support the parking pad. A vehicle rail will be installed along the front of the parking pad.

The design also proposes installing a concrete pathway that leads from Chelsea Circle and connects to the parking pad, with a small roundabout connecting the pathway to the front entrance. Metal handrailing will be installed along the pathway leading from Chelsea Circle and the parking pad.

The proposed landscaping in the front yard will include the installation of steppingstones between the parking pad and home, leading from side yard to the front entrance, and the laying of mulch over jute mesh between the sidewalk and the pathway round-about. The new design proposed will retain sections of lawn in the front yard that were paved over by concrete in the previously approved design.

Recommendation

Approve. These proposed changes do not appear to have a substantial adverse effect on the district. This application appears to meet the guidelines and the staff recommends approval.

Relevant Guidelines

- 5.0 Design Review Objective (p45) When making a material change to a structure that is in view from a public right-ofway, a higher standard is required to ensure that design changes are compatible with the architectural style of the structure and retain character-defining features. When a proposed material change to a structure is not in view from the public-right-way, the Preservation Commission may review the project with a less strict standard so as to allow the owner more flexibility. Such changes, however, shall not have a substantial adverse effect on the overall architectural character of the structure.
- 8.1 Open Space and Parkland Preservation and Conservation (p77) <u>Guideline</u> The original layout of Druid Hills should be preserved through the conservation of major open spaces and the linear system of parks and green spaces that buffer the stream corridors. Retaining these spaces, both public and private, by limiting their uses to passive activities will perpetuate the park-like character in the district today. An exclusive palette of native vegetation is recommended for these spaces to protect and enhance the ecology.
- 9.3 Vegetation (p83) Recommendation The plant list is intended to assist in the selection of appropriate plant materials. Olmsted's list and the list from the Georgia Landscapes Project provide guidance in selecting materials appropriate for historic landscape projects. There are other sources that can be consulted to identify additional plants used by Olmsted in Druid Hills, such as historic planting plans and particularly the archival record at the Olmsted National Historic Site in Brookline, Massachusetts. The Olmsted list presented in this document should be considered a beginning. Residents of Druid Hills are encouraged to add to this list with historic plants that can be documented as having been used by Olmsted. The native list should be used for natural areas within the district, such as creek corridors and drainage ways. Places within the district where the retention of healthy ecological environments is critical are best landscaped with native varieties. Since native plants have been available since the colony of Georgia was established in 1733, native plants are also appropriate for historic landscapes.
- 9.4 Enclosures and Walls (p90) <u>Guideline</u> Fences and walls should not be built in front yard spaces and are strongly discouraged from corner lot side yard spaces. Retaining walls should only be used in situations where topography requires their use.
- *Parking* (p90) <u>Guideline</u> Parking should be addressed in a manner that does not distract from the overall character of the district. Parking to serve private residential lots should be accommodated on-site, when at all possible, using the pathway of original drives and parking. Front yard parking should not be allowed unless it is a public safety issue.

When front yard parking is necessary, it should be added in a manner that does not destroy the unbroken landscaped character of the front yard spaces in Druid Hills. Rear yard spaces should be considered for expansion of parking areas.

- 9.5 Parking (p90) Recommendation It is preferable to expand an existing driveway for parking rather than to add a separate parking pad, since the result is usually less paved surface. Plant materials can be added around parking spaces to visually buffer the parking from the street.
- *Parking* (p90) <u>Recommendation</u> In surfacing new parking areas, the use of impervious paving materials is discouraged. The intent is to limit the amount of run-off within the district's watershed. Consideration should be given to the use of porous materials that allow water penetration and preserve the open character of the landscape.



Development Services Center 178 Sams Street Decatur, GA 30030 www.dekalbcountyga.gov/planning 404-371-2155 (o); 404-371-4556 (f)

Chief Executive Officer
Michael Thurmond

DEPARTMENT OF PLANNING & SUSTAINABILITY

Interim Director Cedric Hudson

Application for Certificate of Appropriateness

Date submitted: 1-17-2024	_	Date Rece	ived:			
Address of Subject Property: 449	Chelsea Cir	cle Atl	anta, Georgia	30307		
Applicant: Lance Muller			E-Mail:	muller@c	ourtlandlandscape	e.com
Applicant Mailing Address: 407 V						
Applicant Phone: 770-402-808	36		-			
Applicant's relationship to the owner:	Owner Owner	Archit	ect Contract	or/Builder	Other	
Owner(s): Sophie Jacobso	**************************************	*******	******* <u>j</u> acobsons	sophie@	**************************************	
Owner(s): Lars Jacobson			_{Email:} jacobsonl	ars@gm	nail.com	
Owner(s) Mailing Address: 443						
Owner(s) Telephone Number: (310)) 986-5296				_	
Approximate date of construction of t	he primary structu	re on the p	property and any other	structures af	fected by this project:	nstructing
Nature of work (check all that apply):	New construction		New Accessory Building		Other Building Changes	
	Demolition		Landscaping	✓	Other Environmental Chan	ges
	Addition		Fence/Wall Sign Installation		Other	V
Description of Work:	Moving a Building	Ш	Sign installation	<u> </u>		
Redesigning the front driver house, to an updated desig house. A small wall under a driveway to support the 2 ca planted in the front yard.	n that will be _l 30", poured in	perpend place of	dicular to the hou concrete to matcl	se and in h the driv	front of the right s eway will be belov	side of the v the

This form must be completed in its entirety and be accompanied by supporting documents, such as plans, list of materials, color samples, photographs, etc. All documents should be in PDF format, except for photographs, which may be in JPEG format. Email the application and supporting material to plansustain@dekalbcountyga.gov and pjvennings@dekalbcountyga.gov. An incomplete application will not be accepted.

Signature of Applicant:



Authorization of a Second Party to Apply for a Certificate of Appropriateness

This form is required if the individual making the request is **not** the owner of the property.

I/We: Lars Jacobson	
being owner(s) of the property at: 444 Chelsea Cir NE	
hereby delegate authority to: Lance Maller	
to file an application for a certificate of appropriateness in my/our behalf.	
Signature of Owner(s):	7
Date: 11/24	

Please review the following information

Approval of this Certificate of Appropriateness does not release the recipient from compliance with all other pertinent county, state, and federal regulations.

Before making any changes to your approved plans, contact the preservation planner (404/371-2155). Some changes may fall within the scope of the existing approval, but others will require review by the preservation commission. If work is performed which is not in accordance with your certificate, a Stop Work Order may be issued.

If your project requires that the county issue a Certificate of Occupancy at the end of construction, an inspection may be made to verify that the work has been completed in accord with the Certificate of Appropriateness. If the work as completed is not the same as that approved in the Certificate of Appropriateness you will not receive a Certificate of Occupancy. You may also be subject to other penalties including fines and/or required demolition of the non-conforming work.

If you do not commence construction within twelve months of the date of approval, your Certificate of Appropriateness will become void and you will need to apply for a new certificate if you still intend to do the work.



How to Obtain a Certificate of Appropriateness

- 1. Contact the DeKalb County Department of Planning and Sustainability for an application form. You may make your request by email <u>plansustain@dekalbcountyga.gov</u> AND <u>rlbragg@dekalbcountyga.gov</u>. telephone (404) 371-2247, or fax (404) 371-2813, or visit the website at https://www.dekalbcountyga.gov/planning-and-sustainability/forms
- 2. Complete and submit the application. Please provide as much supporting material as possible,(plans, material, color samples, photos, etc.). All documents must be in PDF format except for photographs, which may be in JPEG format. Applications are accepted for a 10-day period each month. See page 3 (HPC Calendar). Email the application and supporting documents to plansustain@dekalbcountyga.gov AND rlbragg@dekalbcountyga.gov. If all documents are not provided the application will not be complete and will not be accepted.
- 3. The Preservation Planner will post a sign on the property at least ten days before the preservation commission meeting or coordinate sign posting with the applicant.
- 4. The Preservation Planner will visit the property as part of their review. The commission members may view the property from the right-of-way.
- 5. Applications will be reviewed by the DeKalb County Historic Preservation Commission at its monthly meeting. The Historic Preservation Commission meets on the third Monday at 6 p.m., via Zoom. In unusual circumstances meeting dates and location may be changed.
- 6. The Historic Preservation Commission may approve, approve with modifications or deny an application. The applicant or any affected person as defined by county code may appeal the decision to the DeKalb County Board of Commissioners. Please contact the Department of Planning and Sustainability if you wish to file an appeal. The Historic Preservation Commission is required to make a decision on an application within 45 days of the date of filing, although this time can be extended if the applicant agrees to a deferral.
- 7. Although not required, applicants are encouraged to attend the Historic Preservation Commission meetings. Applicants may make a presentation, but presentations are not required. The commissioners may have questions for the applicant.
- 8. Approval of a Certificate of Appropriateness does not release the recipient from compliance with all other county, state and federal regulations.



Design Checklist for a Certificate of Appropriateness

This checklist was created to help applicants prepare a complete application. Omissions and inaccurate information can lead to deferrals and/or denials of applications. Please review the checklist with the project's architect, designer, or builder. All items will not be applicable to all projects. New construction will involve all categories. One copy of drawings at scale (plus nine reduced sets) should be submitted.

Please address questions regarding applicability to your project to the DeKalb County Preservation Planner at 404-687-3945, e-mail pyjennings@dekalbountyga.gov and rlbragg@dekalbcountyga.gov.

Applicants are also referred to the DeKalb County website, http://www.dekalbcountyga.gov/planning-and-sustainability/planning-sustainability.

I have reviewed the "Design Manual for the Druid Hills Local Historic District".	Yes	
I have reviewed the DeKalb County Tree Ordinance.	Yes	
I have reviewed applicable zoning codes regarding lot coverage, garage sizes, stream buffers.	Yes	

1. General

- a. Label all drawings with the address of the site, owners' name, and contact phone number.
- b. Number all drawings.
- c. Include a graphic scale on reductions.
- d. Date all revisions.
- e. Indicate all unverified numbers with +/- signs
- f. Include photos of the existing condition of the property.

2. Site Plan (existing and proposed) to include:

- a. Topographical plan with significant trees sized and located;
- b. Setback compared to adjacent houses (ask surveyor to show corners of adjacent houses);
- c. Distance between houses;
- d. Façade width to finished face of material;
- e. Grading and elevations across site;
- f. Dirt removal or regrading if more than 18";
- g. Tree protection plan;
- h. Tree removal and replacement plan

3. Driveways and Walkways

- a. Location and relationship to house;
- b. Width;
- c. Material;
- d. Curb cut and apron width



4. Fences & Retaining Walls

- a. Placement on lot;
- b. Height of fence or wall. If retaining wall, height on both sides;
- c. Material;
- d. Railing if necessary

5. Elevations and Floor Plans: << Indicate all unverified numbers with +/- signs>>

- a. Plans for all floors (drawn to scale, ¼"=1' preferred);
- b. House orientation on site plan;
- c. Scalable elevations for front, rear, left, right;
- d. Height, grade to ridge;
- e. Streetscape comparison showing heights of two flanking houses on each side;
- f. Height from grade to first floor level at all four corners;
- g. Height from grade or finished floor line to eaves at all four corners;
- h. Ceiling heights of each floor, indicating if rough or finished;
- i. Height of space between the ceiling and finished floor above;
- j. Two people of 5'-6" and 6' height shown;
- k. Landscaping plan

6. Additions

- a. Placement shown on elevations and floor plan;
- b. Visibility from rights-of-way and paths;
- c. Photos of all facades;
- d. Design proportioned to main house;
- e. Landscaping plan;
- f. Materials and their combinations

7. Roof Plan

- a. Shape and pitch of roof;
- b. Roofing material;
- c. Overhang;
- d. Louvers and vents;
- e. Chimney height and material

8. Dormers

- a. Construction details provided;
- b. Shape and size of dormer (show dimensions on drawings);
- c. Overhang;
- d. Size of window(s), with nominal size of sash (show dimensions on drawings)

9. Skylights

- a. Profile;
- b. Visibility from right-of-way;
- c. Material (plastic lens or glass);
- d. Shown in plan and elevation to scale



10. Façade

- a. Consistency in style;
- b. Materials and their combinations

brick size and color

stone type and color

fiber-cement (e.g., Hardie-plank) or wood siding

shake or shingle

other

- c. Height of foundation at corners;
- d. Ceiling heights comparable to area of influence: basement, first floor, second floor;
- e. Detailing: soldier course, brackets, fascia board; water table;
- f. Height from grade to roof ridge;
- g. Dimensions, proportions and placement of windows, doors

11. Entrance

- a. Height and width of door;
- b. Design of door (e.g., 6-panel, craftsman);
- c. Material of door;
- d. Overhang;
- e. Portico height;
- f. Size and height of columns or posts;
- g. Railing

12. Windows

- a. Consistent with original as well as the area of influence;
- b. Size and proportion similar to original;
- c. Pane orientation and size similar to original;
- d. Type (e.g., double hung, casement);
- e. Fenestration on walls visible from right-of-way;
- f. Simulated divided light (SDL) or true divided light (TDL): location of muntins between the glass, behind the glass or permanently affixed on exterior;
- g. Material of window and any cladding;
- h. Width of muntins compared to original (show dimensions on drawings);
- i. Shutters or canopies
- i. Dimensions of windows and doors.

13. Materials

- a. Show all materials and label them on drawings;
- b. Provide samples of brick or stone;
- c. Provide samples if new or unusual materials



14. Garages / Accessory Buildings

- a. Visibility from street;
- b. Placement on site;
- c. Scale, style appropriate for house;
- d. Show dimensions on drawings;
- e. Materials;
- f. Square footage appropriate for lot size;
- g. Garage door size and design
- h. Show height from grade to eaves and to top of roof

15. Demolitions

- a. Provide documentation from engineer concerning feasibility of rehabilitation;
- b. Provide photographs of structure to be demolished;
- c. Provide plan for proposed redevelopment

Application Process Checklist


This checklist is to ensure that applicants understand the Certificate of Appropriateness (COA) application process from beginning to end. Please verify that you have read over the process shown below and understand the procedures and timeline that will be followed for all submitted COA applications.


- Applications may only be submitted during the period specified on the calendar for each month. Once the filing
 deadline has passed and that period has expired, no new applications will be accepted to be heard at that
 month's commission meeting. If an application has not been submitted before the filing deadline, it cannot be
 submitted again until the next period for applications has opened.
- Additional materials submitted after the staff's report have been finalized and posted to the public will not be
 taken into consideration for the staff report. Staff reports will not be edited once finalized and published any
 new materials may be submitted for the record for the commission but will not affect the staff's report for the
 application.
- Any additional materials submitted after the staff's report has been finalized and posted to the public may be added to the record for the historic preservation commission to review as supplemental materials for the submitted application. Supplemental materials includes:
 - Representative photos
 - Letters of support/opposition
 - Architectural drawings
 - Updated site plans

Supplemental materials **do not** include documents for new work to be added to the already submitted application. Any materials that propose new work that was not included in the original application, will not be added to the record. Any proposed new work that was not included in the original application will need to be included in a new application to be submitted for next month's commission meeting.

I have reviewed the information above and understand the Certificate of Appropriateness process.	Yes

I have reviewed the HPC calendar.

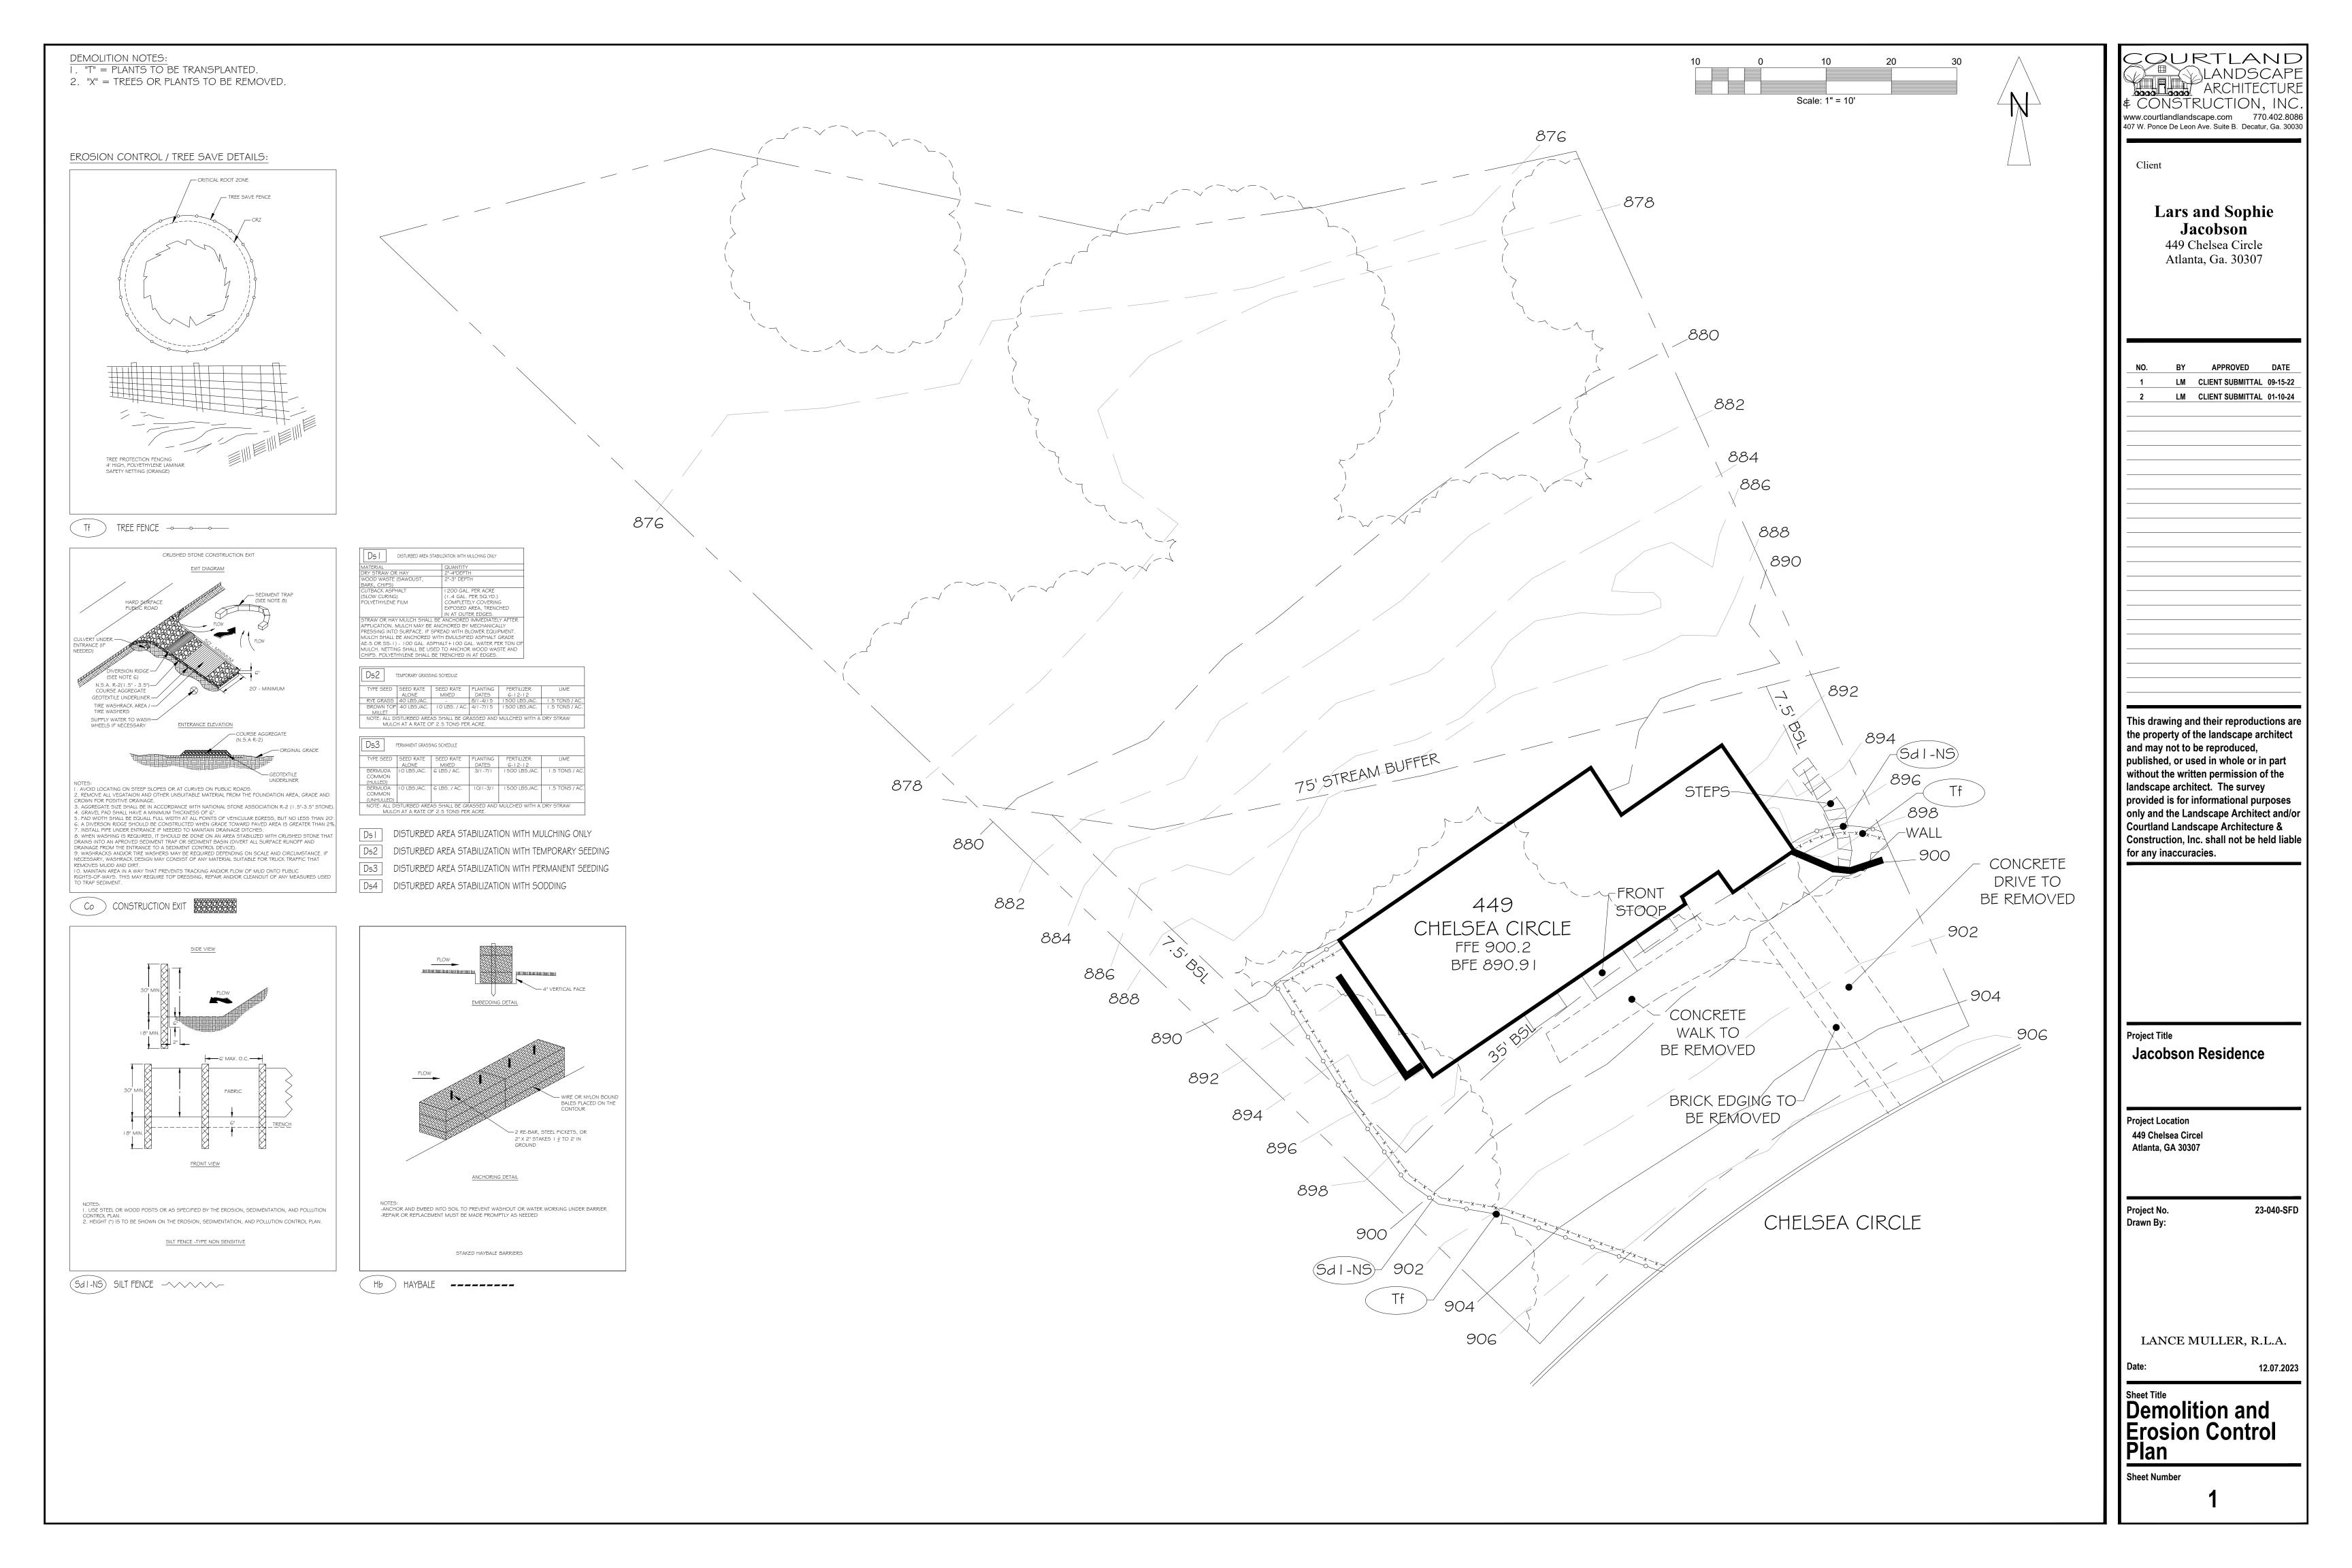

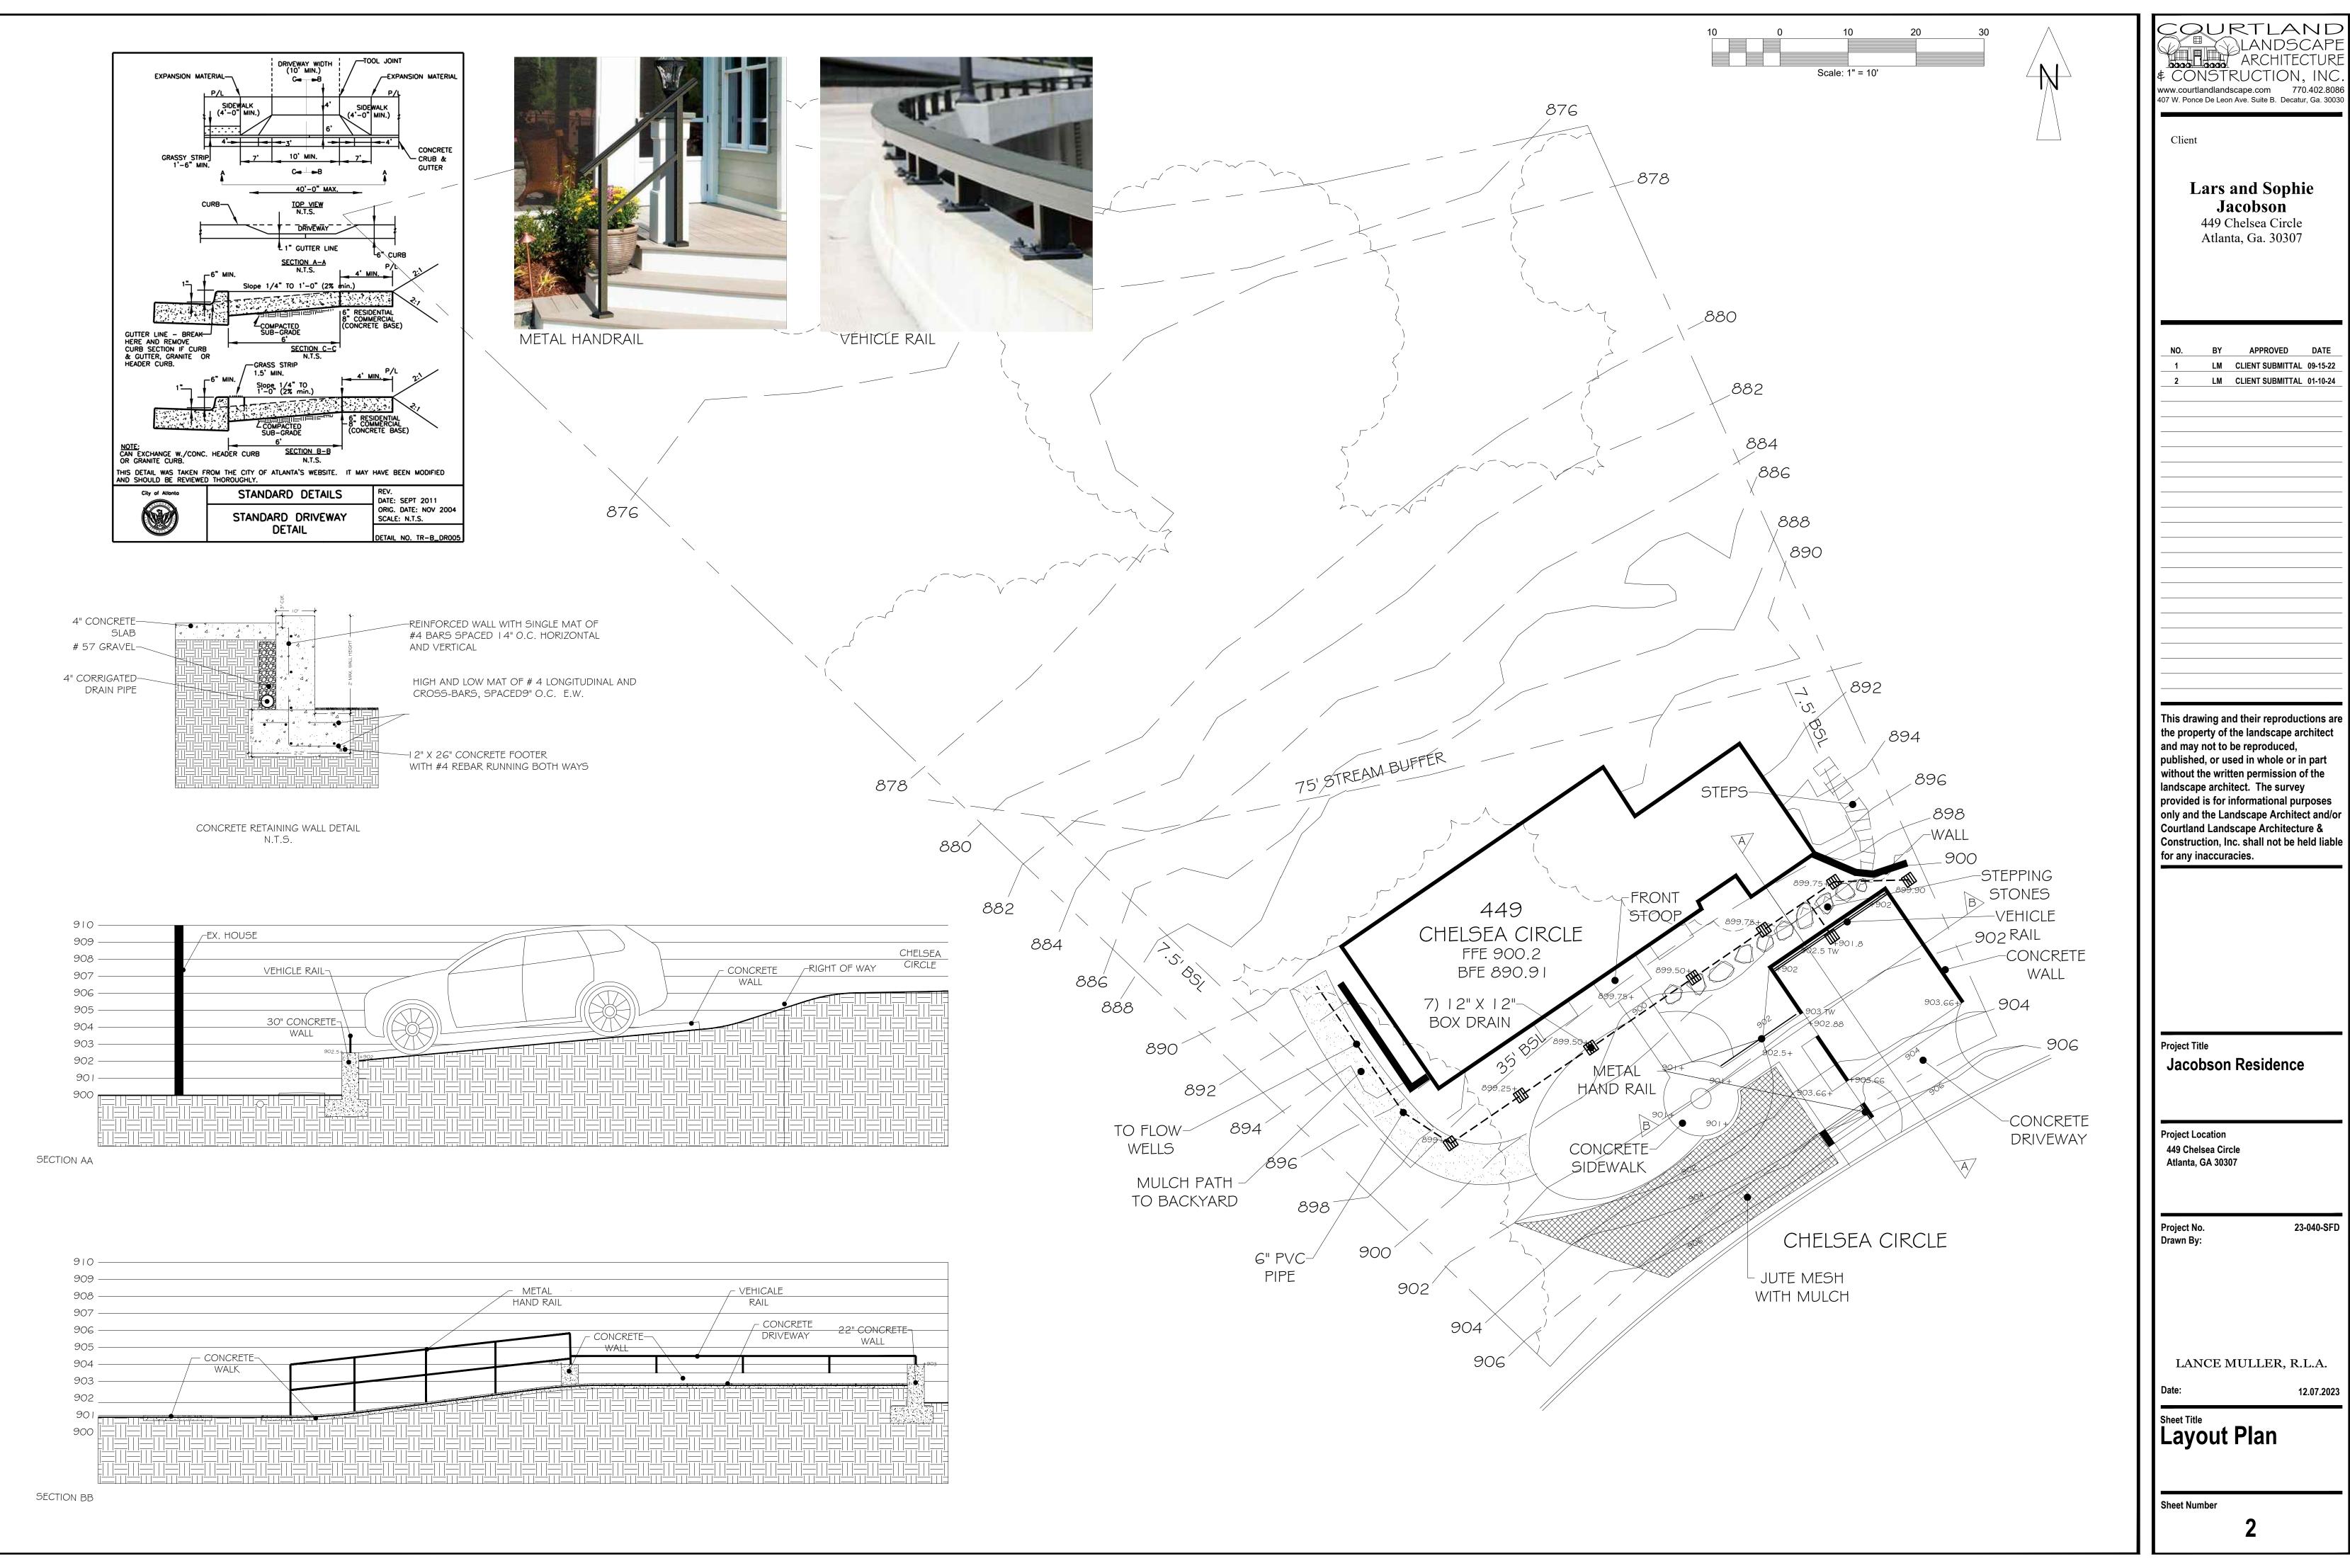



LM CLIENT SUBMITTAL 09-15-22

Project Description:

Demolition of an existing concrete driveway, brick edge and paver walk, followed by construction of new pervious paver driveway, retaining walls, ada ramps, stairs, walks and landings.

<u>Project Shall Comply with the Following</u> Codes:

(IBC)International Building Code, 2018 Edition, with Georgia Amendments (2020)

International Residential Code, 2018 Edition, with Georgia Amendments (2020)

International Fire Code, 2018 Edition, with Georgia Amendments (2020) International Plumbing Code, 2018 Edition, with Georgia Amendments

(2020)
International Mechanical Code, 2018
Edition, with Georgia Amendments
(2020)

International Fuel Gas Code, 2018 Edition, with Georgia Amendments (2020)

National Electrical Code, 2017 Edition, with NO Georgia Amendments International Energy Code, 2015 Edition, with Georgia Supplements and Amendments (2020)

2012 NFPA 101-Life Safety Code, 2018 Edition with State Amendments (2020) International Swimming Pool & Spa Code, 2018 Edition, with Georgia Amendments (2020)

Georgia Accessibilty Codes

Occupancy Classification: Residential



Project Name: Jacobson Residence

449 Chelsea Circle, NE Atlanta, Georgia 30307

Dekalb County, Georgia Land Lot 4, District 18 Zoning: R-75

Project Designer of Record:


Mary Kathryn Barnett, RLA Terramore Studios, LLC 1954 Airport Road, Suite 218 Atlanta, Georgia 30341 404.725.2216

> 24-Hour Contact: Lars Jacobson, Owner xxx.xxx.xxxx




F.I.R.M. MAP:

LOCATION MAP:

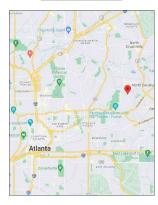

SHEET IND	EX:
COVER	COVER
S - 1.0	SURVEY
LH - 1.0	DEMOL ITI ON PLAN
LH - 1.1	EROSION CONTROL DETAILS
LH - 2.0	SITE PLAN
LH - 2.1	Stak i ng plan
LH - 2.2	DRAINAGE PLAN
LH - 2.2A	DRAINAGE DETAILS
LHD - 1.0	GENERAL DETAILS
LHD - 1.1	GENERAL DETAILS
TRP - 1.0	TREE PROTECTION PLAN
LL - 1.0	LIGHITNG PLAN

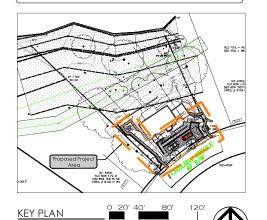

SCALE: 1" = 40'-0"

NORTH



Jacobson Residenc 449 Chelsea Circle, NE Atlanta, Georgia 30307

STAME

SELLE DATE:

22'12.08 DHHC Review Issue 23'02.07 Permit Set Review

DRAWING INFORMATION: PROJECT NO: 2210Jac SCALE: NTS DRAWN BY: mkb SHEET TITLE:

COVER

C-1.0

D FOR CONSTRUCTION IN NOTISSUED FOR CC

NOTE: SURVEY SHOWN FOR INFORMATION PURPOSES ONLY. TERRAMORE STUDIOS, LLC MAKES NO GUARANTEE AS TO THE ACCURACY OF THIS DOCUMENT.



Jacobson Residence 449 Chelsea Circle, NE Atlanta, Georgia 30307

SHEET NUMBER:

S-1.0



e F

Jacobson Residence 449 Chelsea Circle, NE Atlanta, Georgia 30307

STAMP

ISSUE DATE:

22'12.08 DHHC Review Issue 23'02.07 Permit Set Review

DRAWING INFORMATION:
PROJECT NO: 2210 Jac
SCALE: ""= 10"-0"
DRAWN BY: mkb
SHEET TITLE:

DEMOLITION PLAN

LH-1.0

ATLANTA, GEORGIA 30307 EMAIL: jacobsonlars@gmail.com

- 2. PROJECT CONSISTS OF DEMOLITION OF EXISTING CONCRETE DRIVEWAY, BRICK FDGE AND PAVER WALK. LOWED BY CONSTRUCTION OF NEW PERVIOUS PAVER DRIVEWAY, RETAINING WALLS, ADA RAMPS,
- 3. SOILS ON SITE CONSIST OF 52,4% "PuF" Pacolet-Urban land complex. 10 to 25 percent slopes: 47.6% "Tf" - Toccoa sandy loam, 0 to 2 percent slopes, frequently flooded.
- 4. THE RECEIVING WATERS FOR THE PROJECT IS PEAVINE CREEK, NO WETLANDS ARE KNOWN.
- 5. POST-CONSTRUCTION RUN-OFF SHALL NOT BE GREATER THAN PRE-CONSTRUCTION RUN-OFF. OVERFLOW FROM WATER QUALITY BMP'S SHALL NOT ADVERSELY AFFECT ADJACENT PROPERTIES.
- 6. SILT FENCE SHALL BE INSTALLED IN DOUBLE ROWS WITH MULCH BETWEEN.
- 7. I CERTIFY UNDER PENALTY OF LAW THAT THIS PLAN WAS PREPARED AFTER A SITE VISIT TO THE LOCATION DESCRIBED HEREIN BY MYSELF.

8 I CERTIEY THAT ITO THE BEST OF MY KNOWLEDGE THE EROSION SEDIMENTATION AND POLLUTION CONTROL PLAN PROVIDES FOR AN APPROPRIATE AND COMPREHENSIVE SYSTEM OF BEST MANAGEMENT PRACTICES REQUIRED BY THE GEORGIA WATER QUALITY CONTROL ACT AND THE DOCUMENT "MANUAL FOR FROSION AND SEDIMENT CONTROL IN GEORGIA (MANUAL), PUBLISHED BY THE STATE SOIL AND WATER EROSION AND SEMBLASION ROUNCE IN SECURITY (ADVIAL), PRESENTED IT HE STATE STEEL AND WATER CONSERVATION COMMISSION AS OF JANUARY (AT 19 THE YEAR IN WHICH THE CAND-DISTURDING ACTIVITY WAS PERMITTED AND THAT THE BIST MATAGEMENT PRACTICES ARE EXPECTED TO MEET THE REQUIREMENTS STATED IN PART IV, PAGE 19 OF THE PERMIT.



- P. THE DESIGN PROFESSIONAL WHO PREPARED THE ES&PC PLAN IS TO INSPECT THE INSTALLATION OF THE INITIAL SEDIMENT STORAGE REQUIREMENTS AND PERIMETER CONTROL BMP'S WITHIN 7 DAYS AFTER
- 10. NON-EXEMPT ACTIVITIES SHALL NOT BE CONDUCTED WITHIN THE 25 OR 50 FOOT UNDISTURBED STREAM 10. NON-SEASON A CHININES AND IT FOR TO SECURIOUS DE WITHIN THE 29 OF 80 FOR THE OND STORE SEASON SE
- 11. THERE ARE NO KNOWN BUFFER ENCROACHMENTS ON THE PLAN.
- 12. AMENDMENTS/REVISIONS TO THE ES&PC PLAN WHICH HAVE A SIGNIFICANT EFFECT ON BMPS WITH A HYDRAULIC COMPONENT MUST BE CERTIFIED BY THE DESIGN PROFESSIONAL.
- 13. WASTE MATERIALS SHALL NOT BE DISCHARGED TO WATERS OF THE STATE, EXCEPT AS AUTHORIZED BY A SECTION 404 PERMIT.
- 14. THE ESCAPE OF SEDIMENT FROM THE SITE SHALL BE PREVENTED BY THE INSTALLATION OF EROSION AND SEDIMENT CONTROL MEASURES AND PRACTICES PRIOR TO LAND DISTURBING ACTIVITIES.
- 15 FROSION CONTROL MEASURES WILL BE MAINTAINED AT ALL TIMES. IE FILL IMPLEMENTATION OF THE TO EXOCUTE CONTROL MEASURES WILL BE MAINTAINED AT ALL TIMES, IF TOLL WIFE EMENTATION OF THE APPROVED PLAN DOES NOT PROVIDE FOR EFFECTIVE EROSION CONTROL, ADDITIONAL EROSION AND SEDIMENT CONTROL MEASURES SHALL BE IMPLEMENTED TO CONTROL OF TREAT THE SEDIMENT SOURCE.
- 16. ANY DISTURBED AREA LEFT EXPOSED FOR A PERIOD OF TIME GREATER THAN 14 DAYS SHALL BE STABILIZED WITH MULCH OR TEMPORARY SEEDING.
- 17. ALL POLLUTANTS FROM WASTE DISPOSAL PRACTICES, SOIL ADDITIVES, REMEDIATION OF SPILLS AND LEAKS OF PETROLEUM PRODUCTS, CONCRETE TRUCK WASHOUT, ETC. SHOULD ANY OF THESE OCCUR, WILL BE IN COMPLIANCE WITH ALL APPLICABLE STATE AND LOCAL WASTE DISPOSAL, SANITARY SEWER OR SEPTIC SYSTEM REGULATIONS.

PRODUCT SPECIFIC PRACTICES:

PETROLEUM-BASED PRODUCTS - NO PETROLEUM-BASED PRODUCTS SHALL BE STORED ON SITE.

PAINTS/FINSHES/SOLVENTS – ALL PRODUCTS WILL BE STORED IN TIGHTLY SEALED ORIGINAL CONTAINERS WHEN NOT IN USE. EXCESS PRODUCT SWILL NOT BE DISCHARGED TO THE STORMWATER COLLECTION SYSTEM. EXCESS PRODUCT MERICALS USED WITH THESE PRODUCT SAND PRODUCT CONTAINERS WILL BE DISPOSED OF ACCORDING TO MANUFACTURERS' SPECIFICIATIONS AND RECOMMENDATIONS.

CONCRETE TRUCK WASHOUT - NO CONCRETE TRUCKS WILL BE ALLOWED TO WASH OR DISCHARGE SURPLUS CONCRETE OR DRUM WAS WATER ON SITE.

FERTILIZERS/HERBICIDES - THESE PRODUCTS WILL BE APPLIED AT RATES THAT DO NOT EXCEED THE MANUFACTURERS' SPECIFICATIONS OR ABOVE THE GUIDELINES SET FORTH IN THE CROP ESTABLISHMENT OR IN THE GSWCC MANUAL FOR EROSION AND SEDIMENT CONTROL IN GEORGIA. ANY STORAGE OF THESE MATERIALS WILL BE UNDER ROOF IN SEALED CONTAINERS.


BUILDING MATERIALS - NO BUILDING OR CONSTRUCTION MATERIALS WILL BE BURIED OR DISPOSED OF ONSITE, ALL SUCH MATERIAL WILL BE DISPOSED OF USING PROPER WASTE DISPOSAL PROCEDURES. ALL MATERIALS SHOULD BE COVERED WITH A WATERPROOF TARP, SECURED AROUND ITS BASE.

- 18. WASHOUT OF THE DRUM OF A CONCRETE TRUCK AT THE CONSTRUCTION SITE IS PROHIBITED CONCRETE WASHDOWN OF TOOLS, CONCRETE MIXER CHUTES, HOPPERS AND THE REAR OF VEHICLES WILL ONLY BE ALLOWED IN A DESIGNATED AREA PROVIDED FOR THIS PURPOSE, AS SHOWN ON THE DRAWINGS. THE FOLLOWING BEST MANAGEMENT PRACTICES WILL BE FOLLOWED:
- (1) CONTAIN ALL WASH WATER ON SOIL, IN A BOWL-SHAPED AREA CREATED IN THE DESIGNATED WASH AREA TO PREVENT THE WASH WATER FROM FLOWING FROM THE WASHOUT AREA:
- USE THE MINIMUM AMOUNT OF WATER TO WASH DOWN THE TOOLS, CONCRETE MIXER CHUTES, HOPPERS AND THE REAR OF VEHICLES:
- REMOVE ANY CONCRETE SEDIMENT FROM THE AREA SURROUNDING THE WASHOUT AREA BEFORE IT HARDENS; AND
- (4) REMOVE ALL CONCRETE RESIDUE FROM THE DESIGNATED AREA ONCE IT HAS HARDENED.
- LOCAL, STATE AND MANUFACTURERS' RECOMMENDED METHODS FOR SPILL CLEANUP WILL BE CLEARLY POSTED AND PROCEDURES WILL BE MADE AVAILABLE TO SITE PERSONNEL. MATERIAL AND EQUIPMENT NECESSARY FOR SPILL CLEANUP WILL BE KEPT IN THE MATERIAL STORAGE AREA. TYPICAL MATERIALS AND

19. (CONT'D) EQUIPMENT INCLUDES, BUT IS NOT LIMITED TO – BROOMS, DUSTPANS, MOPS, RAGS, GLOVES, GOGGLES, CAT LITTER, SAND, SAWDUST AND PROPERLY LABELED PLASTIC AND METAL WASTE GOOGLES, CAT IN ITEM, SAND, SAMPLOSS AND PROCEDURES WILL BE REVIEWED AND WRITE WASTE.


CONTAINERS SHILL PREVENTION PRACTICES AND PROCEDURES WILL BE REVIEWED AFTER A SPILL AND
ADJUSTED AS INCESSARY TO PREVENT FUTURE SPILLS. ALL SPILLS WILL BE CLEANUED UNMEDIATELY UPON
DISCOVERY. ALL SPILLS WILL BE REPORTED AS REQUIRED BY LOCAL, STATE AND EDERAL REQUIATIONS. FOR SPILLS THAT IMPACT SURFACE WATER (LEAVE A SHEEN ON SURFACE WATER), THE NATIONAL RESPONSE CENTER (NRC) WILL BE CONTACTED WITHIN 24 HOURSE AT 1-800-424-8802. FOR SPILLS OF AN UNKNOWN AMOUNT, THE NATIONAL RESPONSE CENTER (NRC) WILL BE CONTACTED WITHIN 24 HOURS AT 1-800-424-8802. FOR SPILLS GREATER THAN 25 GALLONS AND ON SURFACE WATER MYACTS, THE GEORGIA DEP WILL BE CONTACTED WITHIN 24 HOURS. FOR SPILLS LESS THAN 25 CALLONS AND NO SURFACE WATER IMPACTS. HE SPILL WILL BE CLEANED UP AND LOCAL ACENCES WILL BE CONTACTED AS REQUIRED. THE CONTRACTOR SHALL NOTIFY THE LICENSED PROCESSIONAL WHO PEPPARED THIS PLAN IF ANY ONE PIECE OF EQUIPMENT HAS A CAPACITY GREATER THAN 660 GALLONS. THE CONTRACTOR WILL NEED A SPILL PREVENTION CONTAINMENT AND CONTERMEASURES PLAN PREPARED BY THAT LICENSED PROFESSIONAL

20. CONSTRUCTION SCHEDULE/SEQUENCE: CONSTRUCTION IS EXPECTED TO TAKE LESS THAN (3) CALENDAR MONTHS TO COMPLETE. THE FOLLOWING EVENTS WILL OCCUR IN THAT TIME:

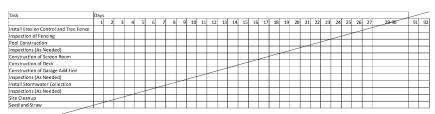



** Silt Fence To Be Removed Once Grass Is Fully Established. ** **Schedule Is Only An Estimate. Timeline Could Increase, Based Upon Inspections, Weather, Etc.**



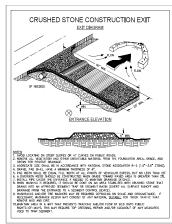



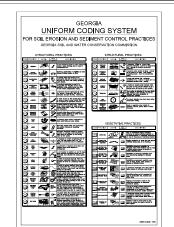

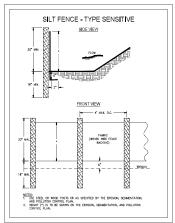







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SSUE DATE

22'12.08 DHHC Review Issue 23'02.07 Permit Set Review

DRAWING INFORMATION: PROJECT NO: 2210Jac SCALE: NTS DRAWN BY: mkb

EROSION CONTROL DETAILS SHEET NUMBER

LH-1.1



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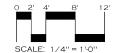
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SITE PLAN

SHEET NUMBER:

LH-2.0

All dimensions angles are 90 Deg unless otherwise specified on plan.
 2. Do not measure from plan. Dimension shows are for reference.
 Contractor shall welfly all dimensions and grades prior to beginning construction activities.
 3. Wolk installed along all property lines shall be constructed with a finished side roward the neighboring property
 4. Proposed slopes shall not exceed 2:1.
 5. Cantractor shall be responsible for locating all underground utilities prior to commencement of any demolition or construction activities.







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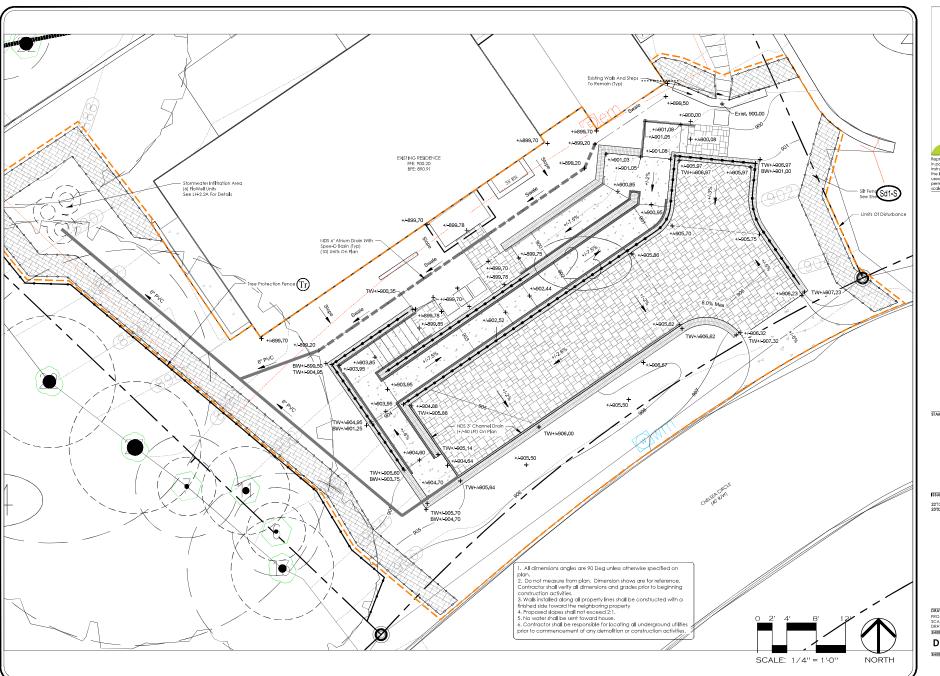
SSUE DATE:

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STAKING PLAN

LH-2.1





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SCALE: 1/4" = 1"-0"
DRAWIN BY: mkb
SHEET TITLE:

DRAINAGE PLAN

LH-2.2



6" Atrium Grate Part No. 90 (10) Units On Plan



Three-4"Outlet Basin Part No. 300 (10) Units On Plan



Spee-D Basin Riser
Part No. 101R
(As Needed)

Drainage Details



Gray Mini Channel Drain Part No. 500 (+/- 50 LFt) On Plan

*	Part No.	Description	Oder	Flig. On.	Wt fa. (bs.)	Product Class	Specifications
Mark	846	Stainless Steel Screws, RH #4 x 1*	Steel	43/Eag	0.10	2589	3 ft. Structural Fours Polyolefin
The state of the s	5543	3' Botanical Channel Grate	Sand	16	0.00	2589	betanical polition Channel Grate with IV inhibitor. Open-surface
	5545Y	3' Estanical Channel Grate	Gray	16	0.89	25PF	area 5.68 square lecture per faut, 16.64 GPM per faut,
	554	3' Botanical Channel Grate	Black	16	0.89	2589	
-	55401	1' Betanical Cast Iron Channel Grate	Elack*	1	1.82	20PF	1 ff. Mirsi Channel bobsvical Cast Ion Channel Grate, Open
2 %	-	First 850 Mini Channel. One page 79. NOL Compliant. "Trainted for shipping & display only; grate will form inon-mide patins					outlace area 5.29 square inches per toot, 1 E.40 GMB per fact, Class E lead rated.

Botanical Cast Iron Channel Grate Part No. 554Cl (+/-50 LFt) On Plan



windspro.com



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DRAINAGE DETAILS

SHEET NUMBER:

LH-2.2A

Belgard Eco Urbana Pervious Paver Color: Belgian Stone (+/-757 SqFt) On Plan

www.belaard.com

Driveway Pavers



Dimensions Antiqued Paver Color: Carriage House (+/-80 SqFt) On Plan

Walkway Pavers



2' X 2' Stone Steppers Full Range Bluestone (4) Units On Plan 2' X 2' Stone Steppers




Ameristar Montage Plus Majestic Steel Fence Color: Black (+/-136 LP1) On Plan Fall Protection Railing




Simple Fabricated Metal Handrail Color: Black (+/-175 LFt) On Plan *Character Image Only*



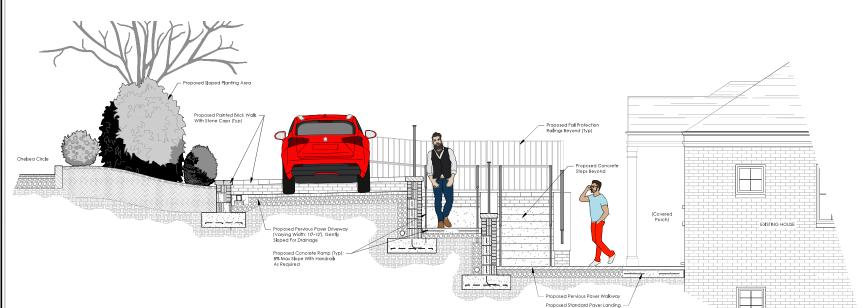

Entry Drive And Walkways - Explanatory Section



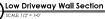

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GENERAL DETAILS

HEET NUMBER:

LHD-1.0


LE FOR CONSPICTION MOTISSUED FOR CONSPICTION

FAIL POSTETION BROWN TWO

FAIL POSTETION BROWN

FAIL POSTETION B


Driveway & Ramp Section

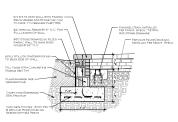

- (3 LHD-

3 Low Driveway Wall Section

Driveway & Ramp Section

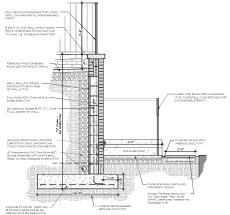

Driveway & Ramp Section

CHO-1.1 SCALE: 1/2"= 11-0"

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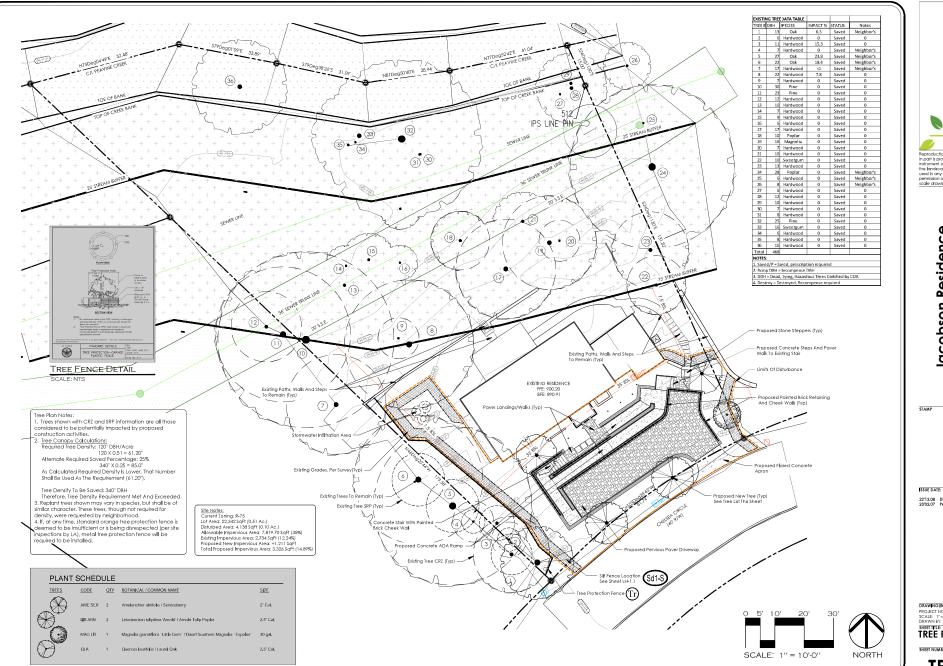
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DRAWING INFORMATION: PROJECT NO: 2210Jac SCALE: Varies DRAWN BY: mkb SHEET TITLE:

GENERAL DETAILS

LHD-1.1







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SHEET TITLE:
TREE PROTECTION PLAN SHEET NUMBER

TRP-1.0



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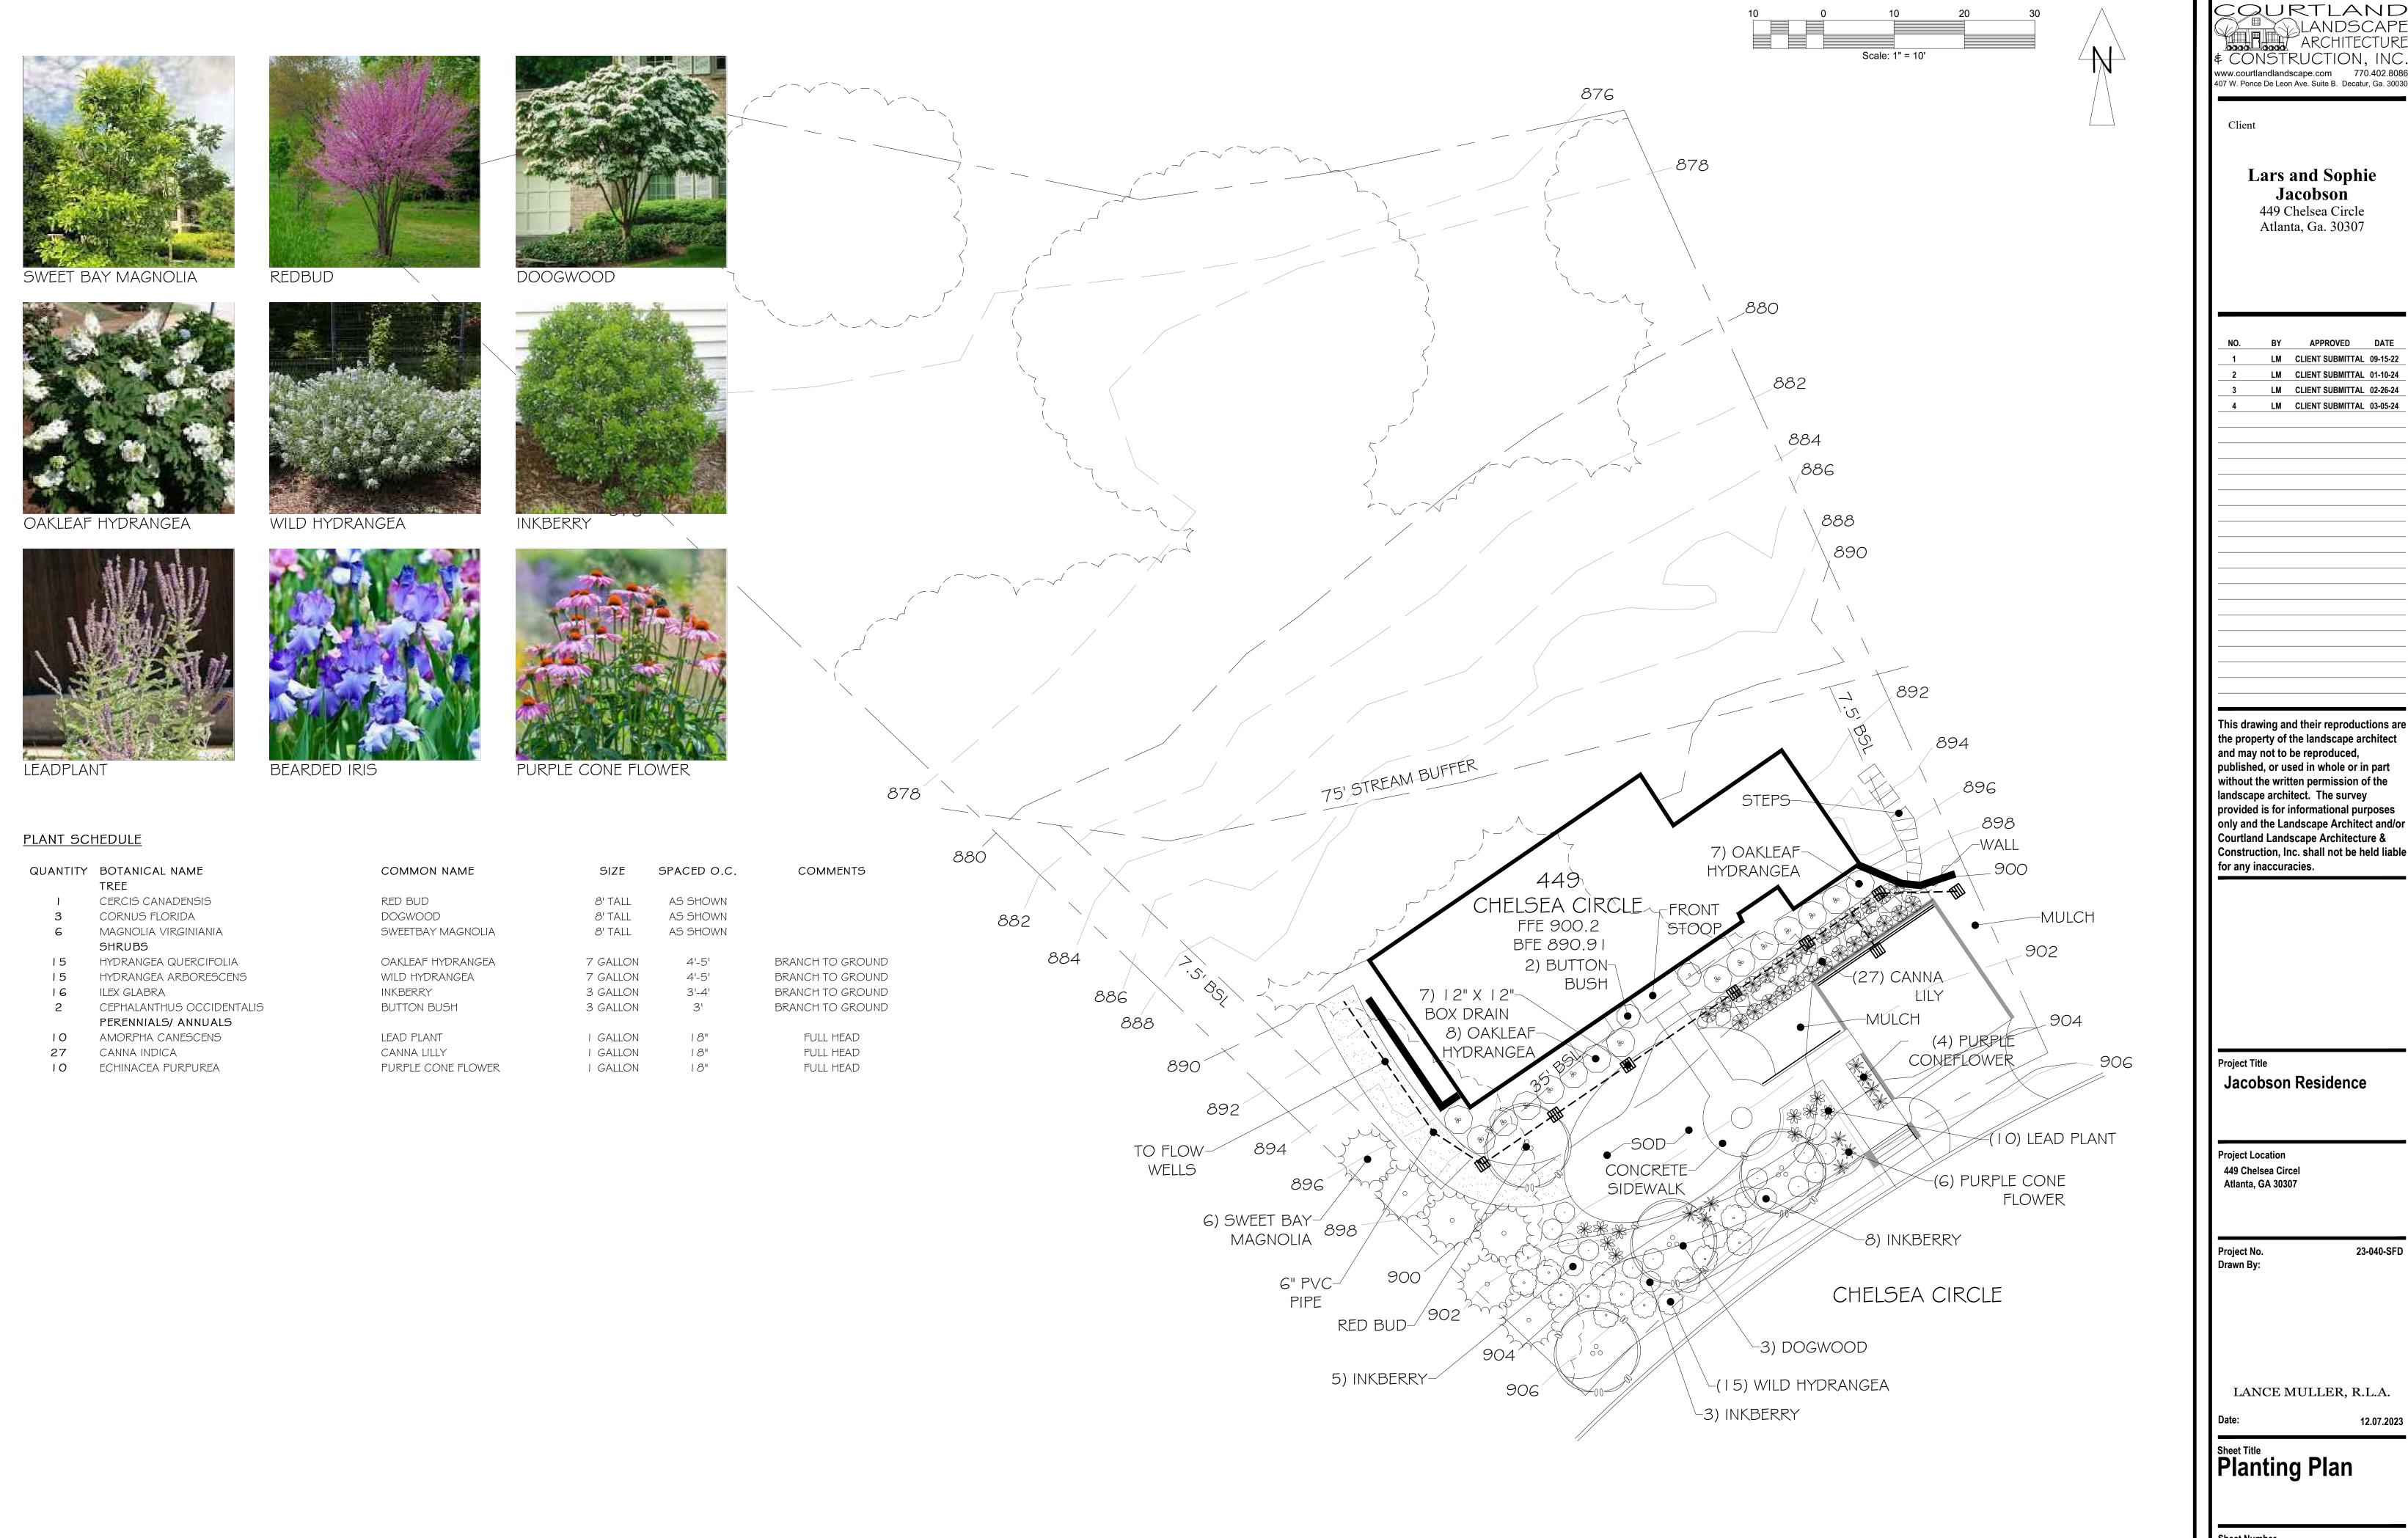
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LIGHTING PLAN

SHEET NUMBER:

LL-1.0



CONSTRUCTION, INC www.courtlandlandscape.com 770.402.8086 407 W. Ponce De Leon Ave. Suite B. Decatur, Ga. 30030

Lars and Sophie

NO.	BY	APPROVED	DATE
1	LM	CLIENT SUBMITTAL	09-15-22
2	LM	CLIENT SUBMITTAL	01-10-24
3	LM	CLIENT SUBMITTAL	02-26-24
4	I M	CLIENT SLIDMITTAL	02 05 24

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23-040-SFD

LANCE MULLER, R.L.A.

Sheet Number