DeKalb County Historic Preservation Commission

Monday, October 20, 2025- 6:00 P.M.

Staff Report

Consent Agenda

F. 1686 East Clifton Road, Ian Porter. Demolish an existing deck and construct a new deck on the rear of a nonhistoric house. **1247802**.

Built in 1950 - Nonhistoric (18 003 03 019)

This property is in the Druid Hills Character Area #2 and the Druid Hills National Register Historic District.

Summary

The applicant proposes demolishing and constructing a deck on a nonhistoric house. The existing deck on the rear of the house will be demolished and a larger, enclosed porch with exterior stairs will be constructed in its place. The proposed enclosed porch will measure 14′ 6.5″ by 26′ 4″ and will be constructed with an asphalt shingle, gable roof, supported by 6x6 columns on brick column bases, and enclosed with screen mesh. In addition to the enclosed porch, a window on the lower-level of the rear façade will be replaced with a set of sliding doors that will lead to the basement interior.

Recommendation

Approve. These proposed changes do not appear to have a substantial adverse effect on the district. This application appears to meet the guidelines and the staff recommends approval.

Relevant Guidelines

- 5.0 Design Review Objective (p45) When making a material change to a structure that is in view from a public right-of-way, a higher standard is required to ensure that design changes are compatible with the architectural style of the structure and retain character-defining features. When a proposed material change to a structure is not in view from the public-right-way, the Preservation Commission may review the project with a less strict standard so as to allow the owner more flexibility. Such changes, however, shall not have a substantial adverse effect on the overall architectural character of the structure.
- 11.0 Nonhistoric Properties (p93) <u>Guideline</u> In reviewing an application for a Certificate of Appropriateness for a material change to a nonhistoric building, the Preservation Commission should evaluate the change for its potential impacts to any historic development (architecture and natural and cultural landscapes) in the area of influence of the nonhistoric property. Guidelines presented in Section 7.0: Additions and new Construction are relevant to such evaluations.

Department of Planning & Sustainability

Current Planning Zoning Division 178 Sams Street Decatur, GA 30030

Chief Executive Officer

DEI

DEPARTMENT OF PLANNING & SUSTAINABILITY

Interim Director

Lorraine Cochran-Johnson

Cedric W. Hudson, MCRP

Application for Certificate of Appropriateness

Date submitted: 09/19/2025	_	Date Rece	ived:		_	
Address of Subject Property: 1686	E Clifton F	Rd NE	, Atlanta, GA	30307		
					ructiongroup@gmail.	com
Applicant Mailing Address: 11 La						
Applicant Phone: (229) 407-0)400		-			
Applicant's relationship to the owner:	Owner	Archite	ect Contract	or/Builder	Other	
**********	*******	******	********	******	********	
Owner(s): David Lassiter			Email: davelass	iter1982	2@gmail.com	
Owner(s): Anne Lassiter			_{Email:} annepark	ker1302	@gmail.com	
Owner(s) Mailing Address: 1686						
Owner(s) Telephone Number:					_	
Approximate date of construction of the	he primary structu	re on the p	property and any other s	structures af	fected by this project: 11	/1/25
Nature of work (check all that apply):	New construction		New Accessory Building		Other Building Changes	✓
	Demolition	$\overline{\mathbf{V}}$	Landscaping		Other Environmental Change	es 🔲
	Addition		Fence/Wall		Other	
Description of Work:	Moving a Building		Sign Installation	Ш		
The project involves the der porch with a new roof struct main-level window with slidi plumbing, and electrical. All public right-of-way.	ture and exter ing doors and	ior stair finishin	to grade. The wo	ork also i interior w	ncludes replacing on the city of the city	ne Ills,

This form must be completed in its entirety and be accompanied by supporting documents, such as plans, list of materials, color samples, photographs, etc. All documents should be in PDF format, except for photographs, which may be in JPEG format. Email the application and supporting material to plansustain@dekalbcountyga.gov and pvjennings@dekalbcountyga.gov. An incomplete application will not be accepted.

	DocuSigned by:	
Signature of Applicant:	lan Porter 82721392B80A433	



Authorization of a Second Party to Apply for a Certificate of Appropriateness

This form is required if the individual making the request is **not** the owner of the property.

I/ We: David Lassiter
being owner(s) of the property at: 1686 E Clifton Rd NE, Atlanta, GA 30307
hereby delegate authority to: Ian Porter
to file an application for a certificate of appropriateness in my/our behalf.
Signature of Owner(s): Signature of Owner(s): Signed by: David B Lassiter 756E1F9AB4D9446
Date:

Please review the following information

Approval of this Certificate of Appropriateness does not release the recipient from compliance with all other pertinent county, state, and federal regulations.

Before making any changes to your approved plans, contact the preservation planner via email. Some changes may fall within the scope of the existing approval, but others will require review by the preservation commission. If work is performed which is not in accordance with your certificate, a Stop Work Order may be issued.

If your project requires that the county issue a Certificate of Occupancy at the end of construction, an inspection may be made to verify that the work has been completed in accord with the Certificate of Appropriateness. If the work as completed is not the same as that approved in the Certificate of Appropriateness you will not receive a Certificate of Occupancy. You may also be subject to other penalties including fines and/or required demolition of the non-conforming work.

If you do not commence construction within twelve months of the date of approval, your Certificate of Appropriateness will become void and you will need to apply for a new certificate if you still intend to do the work.



How to Obtain a Certificate of Appropriateness

- 1. Contact the DeKalb County Department of Planning and Sustainability for an application form. You may make your request by emailing plansustain@dekalbcountyga.gov AND pvjennings@dekalbcountyga.gov.
- 2. Complete and submit the application via email. Please provide as much supporting material as possible, (plans, material, color samples, photos, etc.). All documents must be in PDF format except for photographs, which may be in JPEG format. Applications are accepted for a 10-day period each month. See page 3(HPC Calendar). Email the application and supporting documents to plansustain@dekalbcountyga.gov AND pvjennings@dekalbcountyga.gov. If all documents are not provided the application will not be complete and will not be accepted.
- 3. Once the application has been received, the Administrative Specialist for the Department of Planning and Sustainability will provide a sign template and instructions on how to post the required signage on the property at least ten days before the preservation commission meeting. If the applicant does not post the required signage and provide evidence of posting within ten days before the preservation commission meeting, their application may be deferred or denied due to improper public notification.
- 4. The Preservation Planner may visit the property as part of their review. The commission members may view the property from the right-of-way.
- 5. Applications will be reviewed by the DeKalb County Historic Preservation Commission at its monthly meeting. The Historic Preservation Commission meets on the third Monday at 6 p.m., via Zoom. In unusual circumstances meeting dates and location may be changed.
- 6. The Historic Preservation Commission may approve, approve with modifications or deny an application. The applicant or any affected person as defined by county code may appeal the decision to the DeKalb County Board of Commissioners. Please contact the Department of Planning and Sustainability if you wish to file an appeal. The Historic Preservation Commission is required to make a decision on an application within 45 days of the date of filing, although this time can be extended if the applicant agrees to a deferral.
- 7. Although not required, applicants are encouraged to attend the Historic Preservation Commission meetings. Applicants may make a presentation, but presentations are not required. The commissioners may have questions for the applicant.
- 8. Approval of a Certificate of Appropriateness does not release the recipient from compliance with all other county, state and federal regulations.



Design Checklist for a Certificate of Appropriateness

This checklist was created to help applicants prepare a complete application. Omissions and inaccurate information can lead to deferrals and/or denials of applications. Please review the checklist with the project's architect, designer, or builder. All items will not be applicable to all projects. New construction will involve all categories. One copy of drawings at scale (plus nine reduced sets) should be submitted.

Please address questions regarding applicability to your project to the DeKalb County Preservation Planner at 404-687-3945 or via e-mail at pyjennings@dekalbountyga.gov.

Applicants are also referred to the DeKalb County website, http://www.dekalbcountyga.gov/planning-and-sustainability/planning-sustainability.

I have reviewed the "Design Manual for the Druid Hills Local Historic District".	Yes
I have reviewed the DeKalb County Tree Ordinance.	Yes
I have reviewed applicable zoning codes regarding lot coverage, garage sizes, stream buffers.	Yes

1. General

- a. Label all drawings with the address of the site, owners' name, and contact phone number.
- b. Number all drawings.
- c. Include a graphic scale on reductions.
- d. Date all revisions.
- e. Indicate all unverified numbers with +/- signs
- f. Include photos of the existing condition of the property.

2. Site Plan (existing and proposed) to include:

- a. Topographical plan with significant trees sized and located;
- b. Setback compared to adjacent houses (ask surveyor to show corners of adjacent houses);
- c. Distance between houses;
- d. Façade width to finished face of material;
- e. Grading and elevations across site;
- f. Dirt removal or regrading if more than 18";
- g. Tree protection plan;
- h. Tree removal and replacement plan

3. Driveways and Walkways

- a. Location and relationship to house;
- b. Width;
- c. Material;
- d. Curb cut and apron width



4. Fences & Retaining Walls

- a. Placement on lot;
- b. Height of fence or wall. If retaining wall, height on both sides;
- c. Material;
- d. Railing if necessary

5. Elevations and Floor Plans: << Indicate all unverified numbers with +/- signs>>

- a. Plans for all floors (drawn to scale, ¼"=1' preferred);
- b. House orientation on site plan;
- c. Scalable elevations for front, rear, left, right;
- d. Height, grade to ridge;
- e. Streetscape comparison showing heights of two flanking houses on each side;
- f. Height from grade to first floor level at all four corners;
- g. Height from grade or finished floor line to eaves at all four corners;
- h. Ceiling heights of each floor, indicating if rough or finished;
- i. Height of space between the ceiling and finished floor above;
- j. Two people of 5'-6" and 6' height shown;
- k. Landscaping plan

6. Additions

- a. Placement shown on elevations and floor plan;
- b. Visibility from rights-of-way and paths;
- c. Photos of all facades;
- d. Design proportioned to main house;
- e. Landscaping plan;
- f. Materials and their combinations

7. Roof Plan

- a. Shape and pitch of roof;
- b. Roofing material;
- c. Overhang;
- d. Louvers and vents;
- e. Chimney height and material

8. Dormers

- a. Construction details provided;
- b. Shape and size of dormer (show dimensions on drawings);
- c. Overhang;
- d. Size of window(s), with nominal size of sash (show dimensions on drawings)

9. Skylights

- a. Profile;
- b. Visibility from right-of-way;
- c. Material (plastic lens or glass);
- d. Shown in plan and elevation to scale



10. Façade

- a. Consistency in style;
- b. Materials and their combinations

brick size and color

stone type and color

fiber-cement (e.g., Hardie-plank) or wood siding

shake or shingle

other

- c. Height of foundation at corners;
- d. Ceiling heights comparable to area of influence: basement, first floor, second floor;
- e. Detailing: soldier course, brackets, fascia board; water table;
- f. Height from grade to roof ridge;
- g. Dimensions, proportions and placement of windows, doors

11. Entrance

- a. Height and width of door;
- b. Design of door (e.g., 6-panel, craftsman);
- c. Material of door;
- d. Overhang;
- e. Portico height;
- f. Size and height of columns or posts;
- g. Railing

12. Windows

- a. Consistent with original as well as the area of influence;
- b. Size and proportion similar to original;
- c. Pane orientation and size similar to original;
- d. Type (e.g., double hung, casement);
- e. Fenestration on walls visible from right-of-way;
- f. Simulated divided light (SDL) or true divided light (TDL): location of muntins between the glass, behind the glass or permanently affixed on exterior;
- g. Material of window and any cladding;
- h. Width of muntins compared to original (show dimensions on drawings);
- i. Shutters or canopies
- i. Dimensions of windows and doors.

13. Materials

- a. Show all materials and label them on drawings;
- b. Provide samples of brick or stone;
- c. Provide samples if new or unusual materials



14. Garages / Accessory Buildings

- a. Visibility from street;
- b. Placement on site;
- c. Scale, style appropriate for house;
- d. Show dimensions on drawings;
- e. Materials;
- f. Square footage appropriate for lot size;
- g. Garage door size and design
- h. Show height from grade to eaves and to top of roof

15. Demolitions

- a. Provide documentation from engineer concerning feasibility of rehabilitation;
- b. Provide photographs of structure to be demolished;
- c. Provide plan for proposed redevelopment

Application Process Checklist

This checklist is to ensure that applicants understand the Certificate of Appropriateness (COA) application process from beginning to end. Please verify that you have read over the process shown below and understand the procedures and timeline that will be followed for all submitted COA applications.

- Applications may only be submitted during the period specified on the calendar for each month. Once the filing
 deadline has passed and that period has expired, no new applications will be accepted to be heard at that
 month's commission meeting. If an application has not been submitted before the filing deadline, it cannot be
 submitted again until the next period for applications has opened.
- Additional materials submitted after the staff's report have been finalized and posted to the public will not be
 taken into consideration for the staff report. Staff reports will not be edited once finalized and published any
 new materials may be submitted for the record for the commission but will not affect the staff's report for the
 application.
- Any additional materials submitted after the staff's report has been finalized and posted to the public may be added to the record for the historic preservation commission to review as supplemental materials for the submitted application. Supplemental materials includes:
 - o Representative photos
 - Letters of support/opposition
 - o Architectural drawings
 - Updated site plans

Supplemental materials **do not** include documents for new work to be added to the already submitted application. Any materials that propose new work that was not included in the original application, will not be added to the record. Any proposed new work that was not included in the original application will need to be included in a new application to be submitted for next month's commission meeting.

I have reviewed	l the information	ahowa and	undarctand	the Cortificate	of Annropriator	occ prococc
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Y	es
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I have reviewed the HPC calendar.

Y	es		

International Building Code, 2018 Edition, with Georgia Amendments (2024) International Residential Code, 2018 Edition, with Georgia Amendments (2024) International Fire Code, 2018 Edition International Plumbing Code, 2018 Edition, with Georgia Amendments (2024) International Mechanical Code, 2018 Edition, with Georgia Amendments (2024)

International Fuel Gas Code, 2018 Edition, with Georgia Amendments (2022)

National Electrical Code, 2020 Edition, with Georgia Amendments (2021)

International Energy Conservation Code, 2015 Edition, with Georgia Supplements and Amendments (2023)

International Swimming Pool and Spa Code, 2018 Edition, with Georgia Amendments (2023)

SCOPE OF WORK: INTERIOR RENOVATION & NEW COVERED, SCREENED DECK

<u>DESCRIPTION OF WORK:</u> Partition walls demoed in basement and new walls built. New double exterior doors in basement. On main level 10' wide window replaced with 10' slider doors. Some new plumbing and electrical in basement. Old deck in back to be demoed and new larger deck built with stairs to grade.

Number of Stories in Existing Building: 2 Number of Stories in Proposed Building: 2 Existing Total Heated Square Footage: 1573 Proposed Total Heated Square Footage: 2412

SHEET LIST						
SHEET NUMBER SHEET NAME						
A001 COVER SHEET						
A100 EXISTING FLOOR PLANS						
A101 EXISTING FLOOR PLANS						
A102 PROPOSED FLOOR PLANS						
A103	PROPOSED FLOOR PLANS					
A202 PROPOSED ELEVATIONS						
A203	PROPOSED ELEVATIONS					

1. ALL WORK SHALL BE PERFORMED IN ACCORDANCE WITH ALL APPLICABLE NATIONAL, STATE, AND LOCAL CODES, REGULATIONS, AND FHA/VA MPS.

2. CONTRACTOR SHALL VERIFY ALL CONDITIONS AND DIMENSIONS AT SITE BEFORE BEGINNING CONSTRUCTION. ANY DISCREPANCIES SHALL BE REPORTED TO TAYLOR WORKSHOP LLC. FOR JUSTIFICATION AND/OR CORRECTION BEFORE PROCEEDING WITH WORK. CONTRACTORS SHALL ASSUME RESPONSIBILITY FOR ERRORS THAT ARE NOT REPORTED. 3. ALL DIMENSIONS SHOULD BE READ OR CALCULATED AND NEVER SCALED.

4. ALL FOOTINGS TO BE BELOW FROST LINE (SEE LOCAL CODE) AND MUST REST ON UNDISTURBED SOIL CAPABLE OF HANDLING THE BUILDING. CONSULT LOCAL ENGINEER FOR PROPER FOOTING AND REINFORCING SIZES. 5. CONTRACTOR SHALL INSURE COMPATABILITY OF THE BUILDING WITH ALL SITE REQUIREMENTS.

6. IF BACKFILL EXCEEDS 4' AGAINST ANY FOUNDATION WALL, REINFORCE AS PER CODE. 7. ALL FOUNDATION AND STRUCTURAL MEMBERS SHOULD BE VERIFIED AND STAMPED BY AN ENGINEER IN THE STATE WHERE CONSTRUCTION IS OCCURING DUE TO A WIDE VARIANCE IN LOCAL CODES, SOIL BEARING CONDITIONS, FROST LINE DEPTH. GEOLOGICAL AND WEATHER CONDITIONS. ETC. THE CONTRACTOR IS RESPONSIBLE FOR ADJUSTING AND VERIFYING ALL STRUCTURAL DETAILS AND CONDITIONS TO MEET ALL LOCAL CODES AND TO INSURE A QUALITY AND SAFE STRUCTURE. 8. ALL WOOD, CONCRETE, AND STEEL STRUCTURAL MEMBERS SHALL BE OF A GOOD GRADE AND QUALITY AND MEET ALL NATIONAL, STATE, AND LOCAL BUILDING CODES WHERE APPLICABLE.

9. ALL COLUMNS OR SOLID FRAMING SHOULD BE DESIGNED TO CARRY LOADS AND SHOULD EXTEND DOWN THRU THE LEVELS BELOW AND TERMINATE AT THE BASEMENT FLOOR OR AT OTHER BEARING POINTS DESIGNED TO CARRY THE LOAD.

ALL STRUCTURE TO BE REVIEWED BY PROFESSIONAL ENGINEER

			ABBREVIAT	IONS			
A		F		М		S	
ACS ALUM ASP ADJ ARCH @ AT B BLK BLK'G BOT BTWN BRG	ABOVE CONCRETE SLAB ALUMINUM ASPHALT ADJACENT ARCHITECTURAL AT ACOUSTICAL TILE BLOCK BLOCKING BOTTOM BETWEEN BEARING	FP FIN FL FLUOR FD FDN FIXT FLR FT FT FE G	FIREPROOF FINISH(ED) FLOOR FLUORESCENT FLOOR DRAIN FOUNDATION FIXTURE FLOOR FRAME FEET FIRE EXTINGUISHER	MAX MECH MTL MIN MISC MAS MATL MAX MHO N NTS NIC NO	MAXIMUM MECHANICAL METAL MINIMUM MISCELLANEOUS MASONRY MATERIAL MAXIMUM MAGNETIC HOLD OPEN NOT TO SCALE NOT IN CONTRACT NUMBER	SD SDISPEN SCHED SF SF ST SUSP CLG STRUCT STOR SECT SHT SM SPA SPEC SPKR SQ	SMOKE DETECTOR SOAP DISPENSER SCHEDULE SQUARE FOOT/FEET SPLIT FACE STEEL SUSPENDED CEILING STRUCTURE STORAGE SECTION SHEET SIMILAR SPACE SPECIFICATION SPEAKER SQUARE
BLDG C	BUILDING	GC GALV GL GWB	GENERAL CONTRACTOR GALVANIZED GLASS GYPSUM WALL BOARD	0	NOWBER	SQ FT SST STD	SQUARE SQUARE FOOT/FEET STAINLESS STEEL STANDARD
CJ CLG CMU	CONTROL JOINT CEILING CONCRETE MASONRY UNIT	GB GR GYP GYP BD	GRAB BAR GRADE GYPSUM GYPSUM BOARD	OC OPN'G	ON CENTER OPENING	T	TOP OF MASONRY
CONC CONT CLO CLR COL COOR CP CER CT CTR	CONCRETE CONTINUOUS CLOSET CLEAR COLUMN COORDINATE CARPET CERAMIC CERAMIC CERAMIC TILE CENTER	H HM HP H HC HDW HT HVAC	HOLLOW METAL HIGH POINT HANDRAIL HOLLOW CORE HARDWARE HEIGHT HEATING, VENTILATION AIR CONDITIONING HOT WATER	P PLAS PL PLYW'D PREFIN PR PROJ PROP PTD PTN	PLASTIC PLATE PLYWOOD PREFINISHED PAIR PROJECT PROPERTY PAINTED PARTITION	TOS TYP T T/B T/S TER THK THRES TLT	TOP OF STEEL TYPICAL THREAD TOP OF BEAM TOP OF STEEL TERRAZZO THICK THRESHOLD TOILET
DP DN DIA DS	DAMPROOFING DOWN DIAMETER DOWNSPOUT	I IDC INT	INSIDE DIMENSION CLEAR	Q QT QTY	QUARRY TILE QUANTITY	U.O.N.	UNLESS OTHERWISE NOTED
DET DWG DEPT DF	DETAIL DRAWING DEPARTMENT DRINKING FOUNTAIN	JAN JST	JANITOR JOIST	RAD REQ'D REF	RADIUS REQUIRED REINFORCED	VCT VIF VB VBS VERT VNR	VINYL COMPOSITION TILE VERIFY IN FIELD VAPOR BARRIER VINYL BASE VERTICAL VENEER
EXP EF EJ EW EWC	EXPOSED EACH FACE EXPANSION JOINT EACH WAY ELECTRICAL DRINKING FOUNTAIN	JT L	JOINT	REL REV RO R	RELOCATE REVISE or REVISION ROUGH OPENING RISER	VP VWC	VAPOR PROOF VINYL WALL COVERING
EL ELC ELECT EXIST EXPAN EA ELEV ENCL ENG EQ EQUIP	ELEVATION ELECTRICAL CONTRACTOR ELECTRICAL EXISTING EXPANSION EACH ELEVATOR ENCLOSE ENGINEER EQUIAL EQUIPMENT	LVR LAM LAV LP	LOUVER LAMINATE LAVATORY LOW POINT			WP W/O WC WD WDW W/ W/	WATER PROOFING WITHOUT WATER CLOSET WOOD WINDOW WITH WEIGHT

RO	ROOM SCHEDULE			
NUMBER	NAME	AREA		

01	PLAYROOM	429 SF
03	BEDROOM/OFFICE	272 SF
03 04	BATHROOM	50 SF
05	W.I.C.	45 SF
06	STORAGE	525 SF
08	MUDROOM	40 SF
09	PANTRY STORAGE	102 SF
MAIN LE	VEL	'
07	DECK	370 SF

DOOR NOTES:

- CONTRACTOR SHALL FIELD VERIFY DIMENSIONS FOR ALL EXISTING DOORS
- SCHEDULED FOR REPLACEMENT PRIOR TO ORDERING. CONTRACTOR SHALL FIELD VERIFY DIMENSIONS FOR ALL NEW DOORS
- SCHEDULED TO MATCH EXISITNG DOORS PRIOR TO OPENING.
- SCHEDULED DOOR OPENINGS NOT LOCATED BY A DIMENSION SHALL BE LOCATED 4" MIN FROM ADJACENT WALL FACE OF FINISH.

DOOR SCHEDULE								
DOOR NUMBER WIDTH		PHASE CREATED		PHASE DEMOLISHED				
BASEMENT								
1	3' - 0"	6' - 8"	Existing	New Construction				
2	3' - 0"	6' - 8"	Existing	New Construction				
3	3' - 0"	6' - 8"	Existing	New Construction				
4	3' - 0"	6' - 8"	Existing	None				
5	2' - 6"	6' - 8"	New Construction	None				
6	3' - 0"	6' - 8"	New Construction	None				
7	2' - 8"	6' - 8"	New Construction	None				
10	6' - 0"	6' - 8"	New Construction	None				
11	2' - 8"	6' - 8"	New Construction	None				
12	2' - 8"	6' - 8"	New Construction	None				
13	2' - 8"	6' - 8"	New Construction	None				
14	2' - 6"	6' - 8"	New Construction	None				
18	2' - 6"	6' - 8"	New Construction	None				
19	3' - 0"	6' - 8"	New Construction	None				
MAIN LEVEL	•	1						
15	5' - 0"	6' - 8"	Existing	None				
16	2' - 8"	6' - 8"	Existing	None				
17	2' - 8"	6' - 8"	Existing	None				
	•	•	•					


- CONTRACTOR SHALL FIELD VERIFY DIMENSIONS, HEAD HEIGHTS & SILL HEIGHTS FOR ALL EXISTING WINDOWS SCHEDULED FOR REPLACEMENT PRIOR TO ORDERING.
- CONTRACTOR SHALL FIELD VERIFY DIMENSIONS, HEAD HEIGHTS & SILL HEIGHTS FOR ALL NEW WINDOWS SCHEDULED TO MATCH EXISITNG DOORS PRIOR TO OPENING.

TYPE MARK	WIDTH	HEIGHT	HEAD HEIGHT	PHASE CREATED	PHASE DEMOLISHED
44	2' - 6"	3' - 8"	6' - 8"	Existing	None
44	2' - 6"	3' - 8"	6' - 8"	Existing	None
44	2' - 6"	3' - 8"	6' - 8"	Existing	None
41	2' - 6"	4' - 2"	6' - 8"	Existing	None
40	4' - 10"	0" 4' - 2" 6' - 8" Existing	0" 4' - 2" 6' - 8" Existing	None	
41	2' - 6"	4' - 2"	6' - 8"	Existing	None
40	4' - 10"	4' - 2"	6' - 8"	Existing	New Construction
41	2' - 6"	4' - 2"	6' - 8"	Existing	None
	44 44 44 41 40 41	MARK WIDTH 44 2' - 6" 44 2' - 6" 44 2' - 6" 41 2' - 6" 40 4' - 10" 40 4' - 10"	MARK WIDTH HEIGHT 44 2' - 6" 3' - 8" 44 2' - 6" 3' - 8" 44 2' - 6" 3' - 8" 41 2' - 6" 4' - 2" 40 4' - 10" 4' - 2" 41 2' - 6" 4' - 2" 41 2' - 6" 4' - 2"	MARK WIDTH HEIGHT HEIGHT 44 2' - 6" 3' - 8" 6' - 8" 44 2' - 6" 3' - 8" 6' - 8" 44 2' - 6" 3' - 8" 6' - 8" 41 2' - 6" 4' - 2" 6' - 8" 40 4' - 10" 4' - 2" 6' - 8" 41 2' - 6" 4' - 2" 6' - 8" 40 4' - 10" 4' - 2" 6' - 8"	MARK WIDTH HEIGHT HEIGHT CREATED 44 2' - 6" 3' - 8" 6' - 8" Existing 44 2' - 6" 3' - 8" 6' - 8" Existing 44 2' - 6" 3' - 8" 6' - 8" Existing 41 2' - 6" 4' - 2" 6' - 8" Existing 40 4' - 10" 4' - 2" 6' - 8" Existing 41 2' - 6" 4' - 2" 6' - 8" Existing 40 4' - 10" 4' - 2" 6' - 8" Existing 40 4' - 10" 4' - 2" 6' - 8" Existing


WINDOW SCHEDULE

		(A)	
	ROOM NAME ROOM NUMBER	①———	COLUMN LINE
X	DOOR NUMBER TAG	Ę.	CENTERLINE
(X)	WINDOW NUMBER TAG	•	BEARING OR FLOOR ELEVATION
	ELEVATION NUMBER ON SHEET SHEET NUMBER	\otimes	DEMOLITION TAG
	SECTION NUMBER ON SHEET SHEET NUMBER		REVISION CLOUD
	DETAIL NUMBER ON SHEET SHEET NUMBER		

REFERENCE IMAGES:

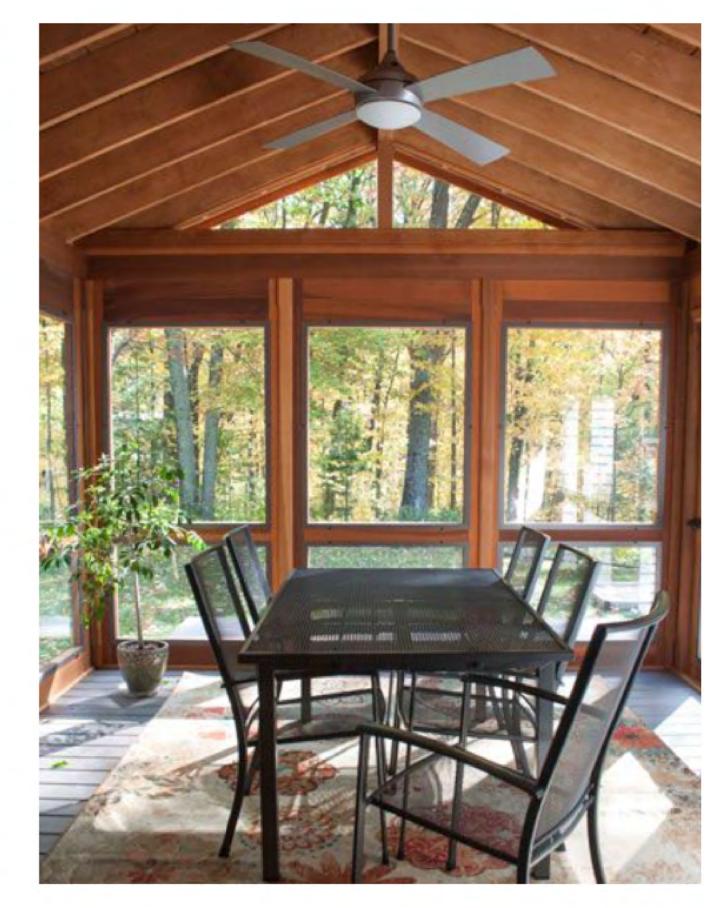

LOCATION:

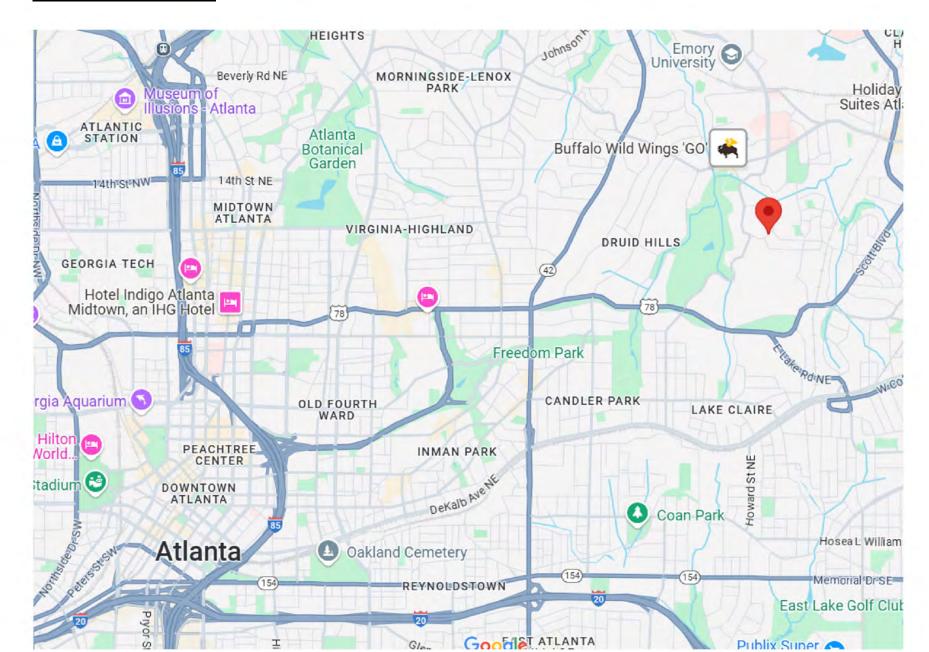


ISSUED FOR CONSTRUCTION




RESERVED FOR REGISTRATION/STAMP Revisions DATE ISSUE

COVER SHEET

Sheet Information A001

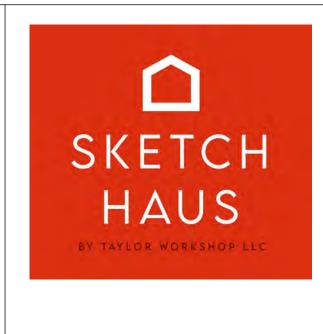


1686 E CLIFTON ROAD NE

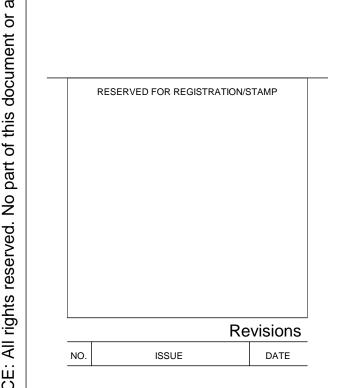

EXISTING FLOOR PLANS

Date 04/09/25
Drawn Author
Checked Checker
Approved Approver

ISSUED FOR CONSTRUCTION

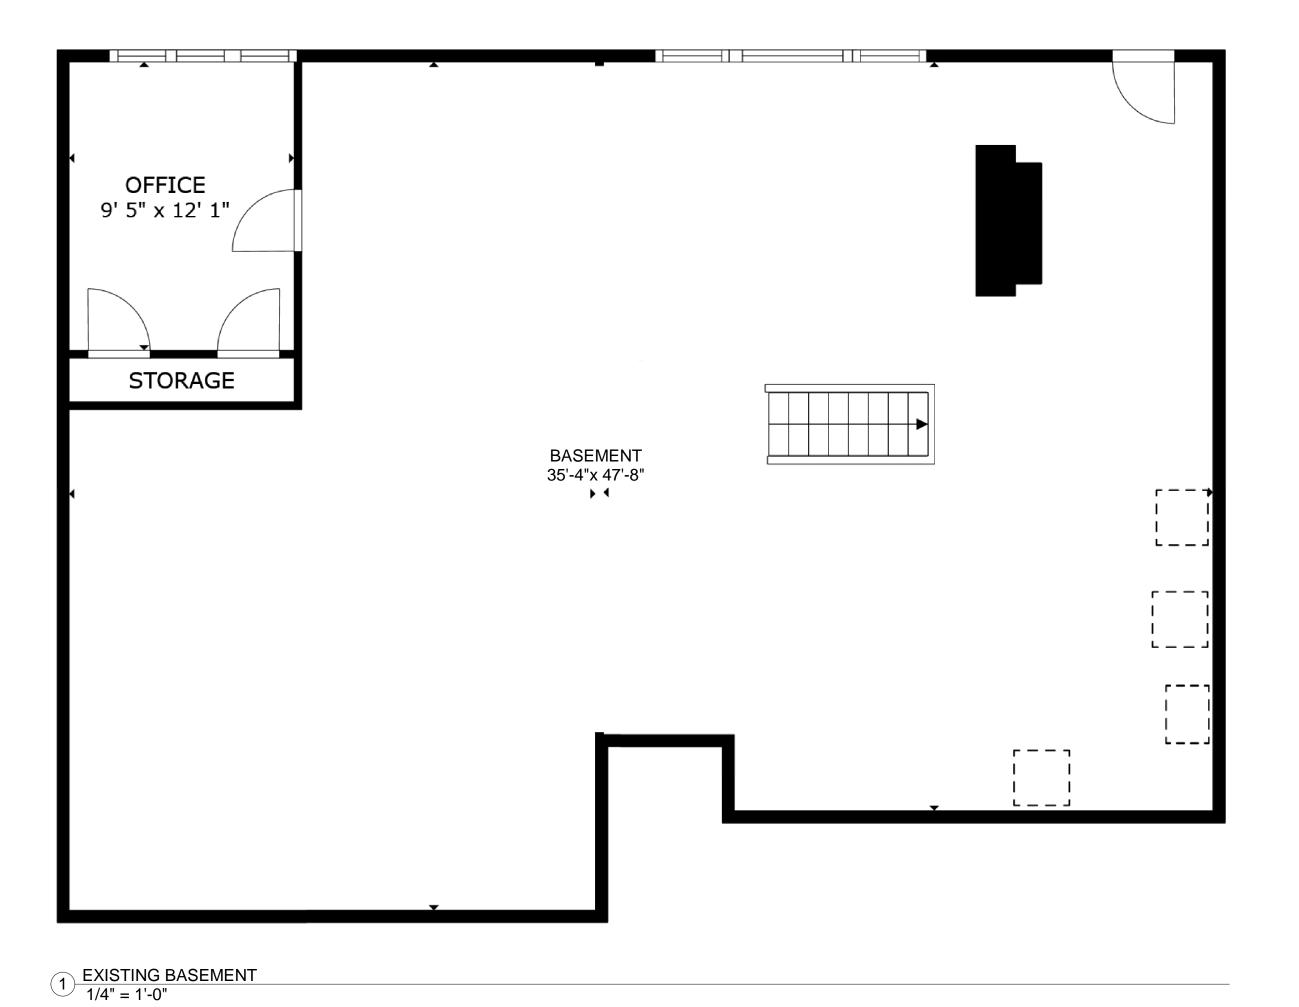





1686 E CLIFTON ROAD NE

RESERVED FOR REGISTRATION/STAMP

Revisions

NO. ISSUE DATE

EXISTING FLOOR PLANS

 Date
 04/09/25

 Drawn
 Author

 Checked
 Checker

 Approved
 Approver

Sheet Information

FLOOR PLAN NOTES

THE GC SHALL ABIDE BY AND BE RESPONSIBLE FOR ALL REQUIREMENTS STATED IN THE AIA DOCUMENT A201-GENERAL CONDITIONS (CURRENT ISSUE). UNLESS NOTED OTHERWISE.

THE CONTRACTOR SHALL TAKE FIELD MEASUREMENTS AND VERIFY FIELD CONDITIONS AND SHALL CAREFULLY COMPARE SUCH FIELD MEASUREMENTS, CONDITIONS, AND OTHER INFORMATION KNOWN TO THE CONTRACTOR WITH THE CONTRACT DOCUMENTS BEFORE COMMENCING ACTIVITIES. ERRORS, INCONSISTENCIES, OR OMISSIONS DISCOVERED SHALL BE REPORTED TO THE ARCHITECT AT ONCE. NO ALLOWANCE WILL BE MADE ON BEHALF OF THE CONTRACTOR OR SUBCONTRACTORS FOR FAILURE TO VISIT THE SITE

THE CONTRACTOR SHALL PROVIDE PROTECTIVE COVERING FOR CARPET, FURNISHINGS, AND FINISHES IN EXISTING AREAS NOT DESIGNATED FOR DEMOLITION OR NEW CONSTRUCTION. THE CONTRACTOR SHALL BE RESPONSIBLE FOR THE REPAIR OF ANY DAMAGE CAUSED BY HIS WORK OR ANY SUBCONTRACTOR. IN PARTICULAR, THE CONTRACTOR SHALL MAINTAIN A DUSTFREE ENVIRONMENT WITHIN THE MAGNET VAULT

HE CONTRACTOR SHALL VERIFY THAT NEW CEILINGS CAN BE INSTALLED IN EXISTING SPACES TO CLEAR DUCTWORK AND OTHER CONSTRUCTED ITEMS AND MAINTAIN FLOOR TO CEILING HEIGHTS INDICATED ON DRAWINGS. IF DISCREPANCIES OCCUR DUE TO EXISTING CONDITIONS, CONSULT WITH THE ARCHITECT BEFORE PROCEEDING.


THE CONTRACTOR SHALL VERIFY DIMENSIONS OF AS-BUILT CONDITIONS, AND NOTIFY THE ARCHITECT IN WRITING OF ANY DISCREPANCIES. ALL INFORMATION SHOWN ON THE CONSTRUCTION DOCUMENTS IS BASED ON FIELD OBSERVATIONS AND/OR THE ORIGINAL CONSTRUCTION DOCUMENTS OF THE FACILITY.

THE CONTRACTOR SHALL BE RESPONSIBLE FOR CORRECTING DEFECTIVE WORK IN EXISTING CONSTRUCTION WITHIN THE LIMITS OF THE CONSTRUCTION AREA. THIS INCLUDES, BUT IS NOT LIMITED TO, UNEVEN SURFACES AND FINISHES AT PLASTER OR GYPSUM BOARD. THE CONTRACTOR SHALL PATCH AND REPAIR SURFACES TO MATCH NEW ADJACENT SURFACES

ROOM SCHEDULE NUMBER NAME AREA

BASEMENT

DASLIVILIVI								
01	PLAYROOM	429 SF						
03	BEDROOM/OFFICE	272 SF						
04	BATHROOM	50 SF						
05	W.I.C.	45 SF						
06	STORAGE	525 SF						
08	MUDROOM	40 SF						
09	PANTRY STORAGE	102 SF						
MAIN LEVEL	MAIN LEVEL							
07	DECK	370 SF						

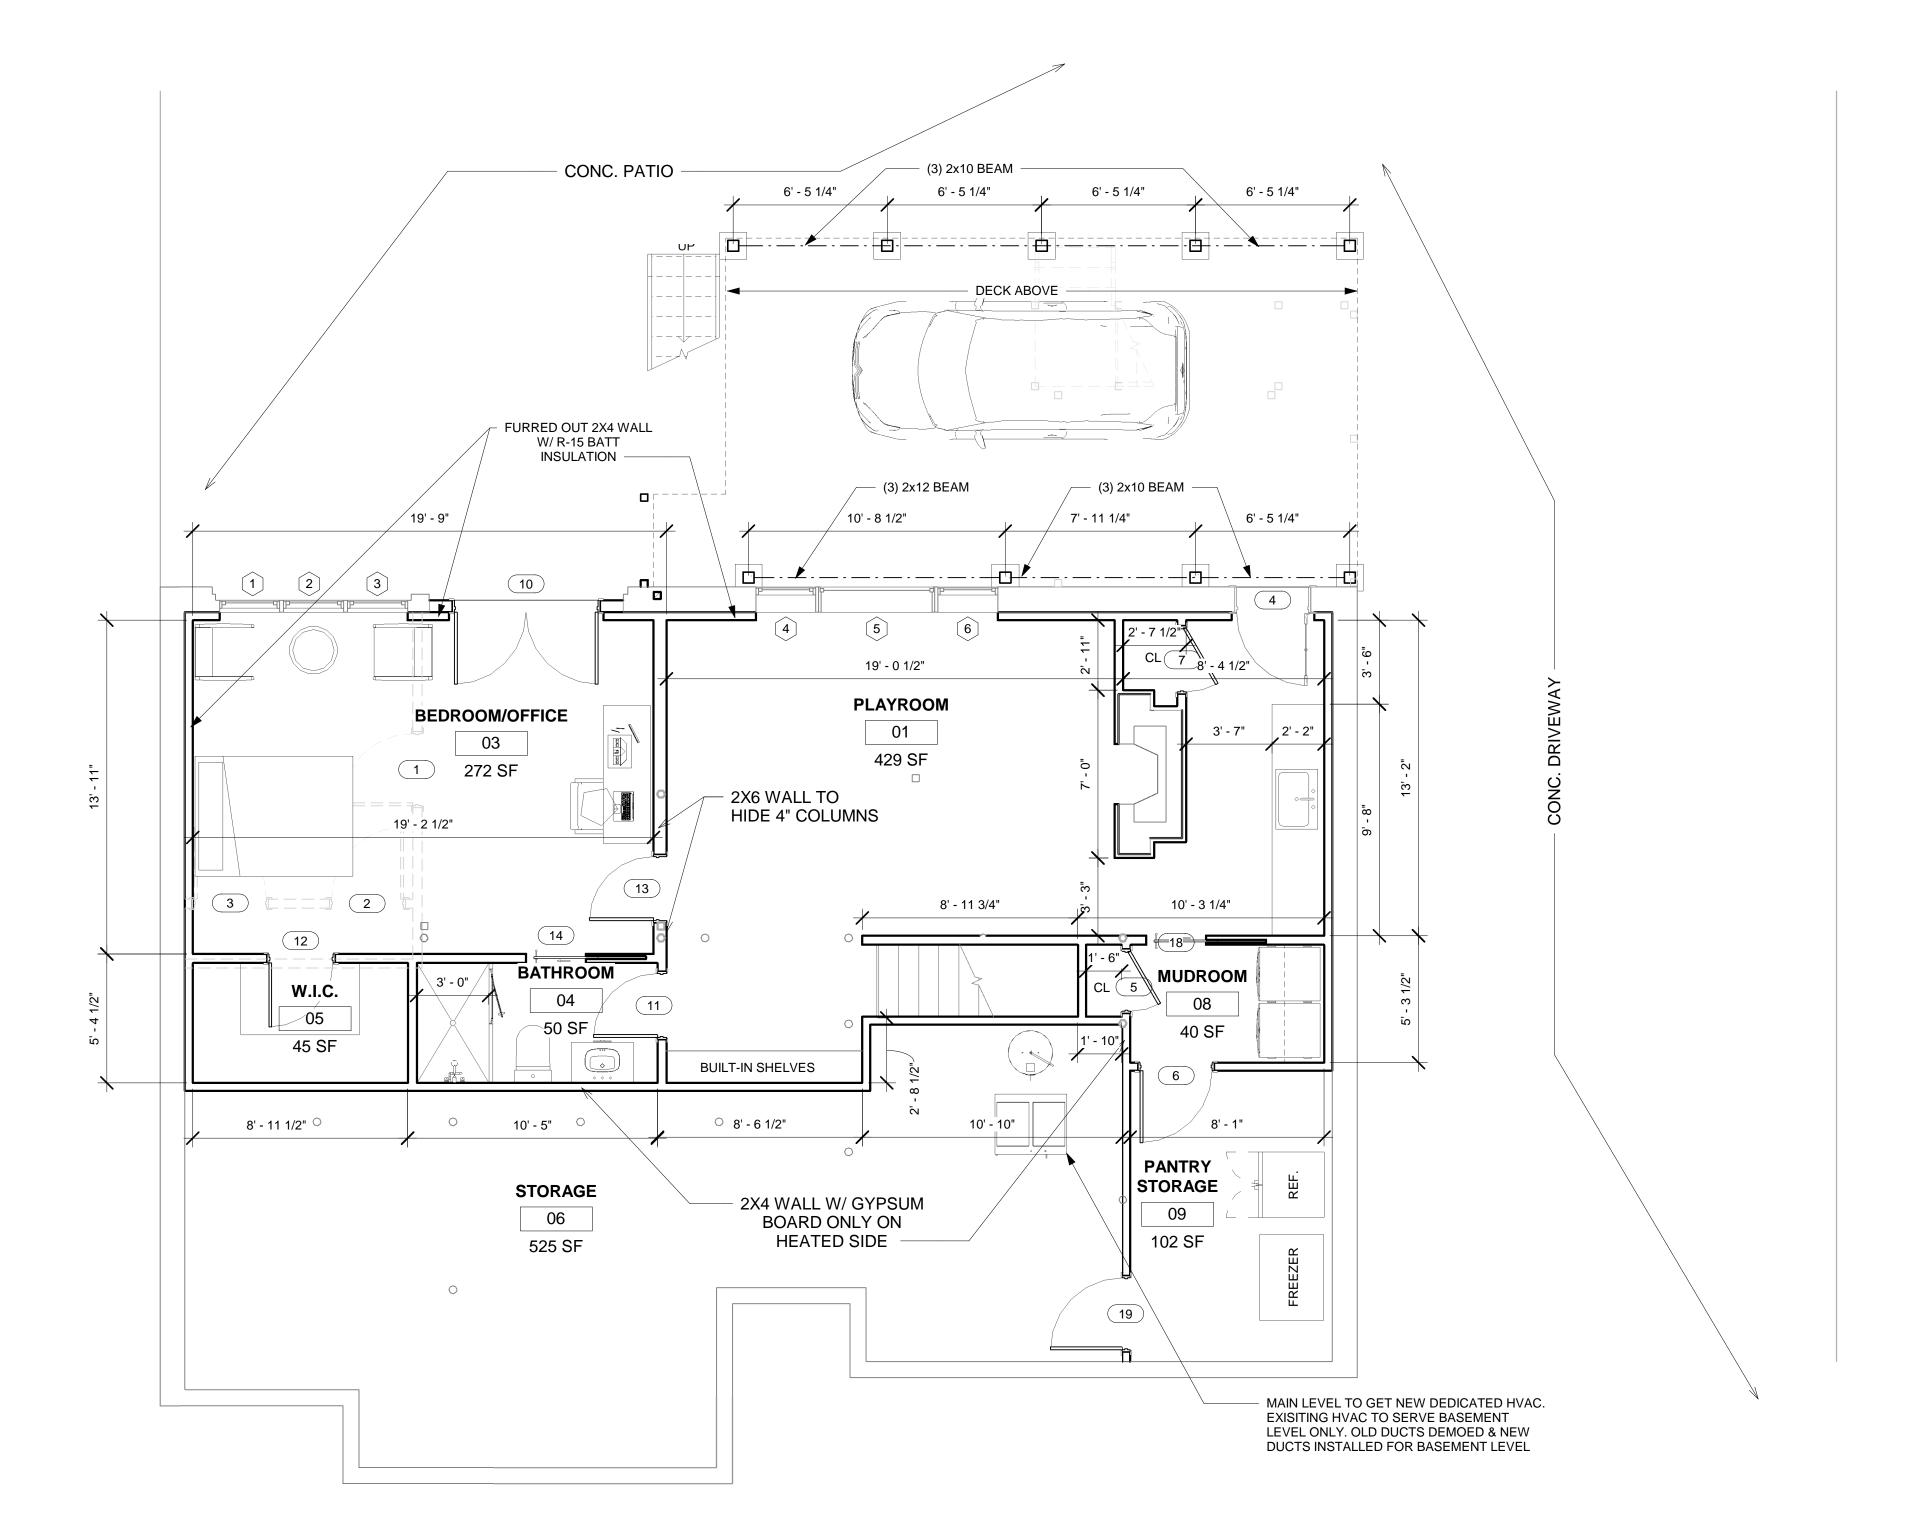

1 BASEMENT 1/4" = 1'-0"



1686 E CLIFTON ROAD NE

RESERVED FOR REGISTRATION/STAMP

Revisions

NO. ISSUE DATE

PROPOSED FLOOR PLANS

Sheet Information She

Date 04/09/25

Drawn Author
Checked Checker
Approved Approver

Approved Approver

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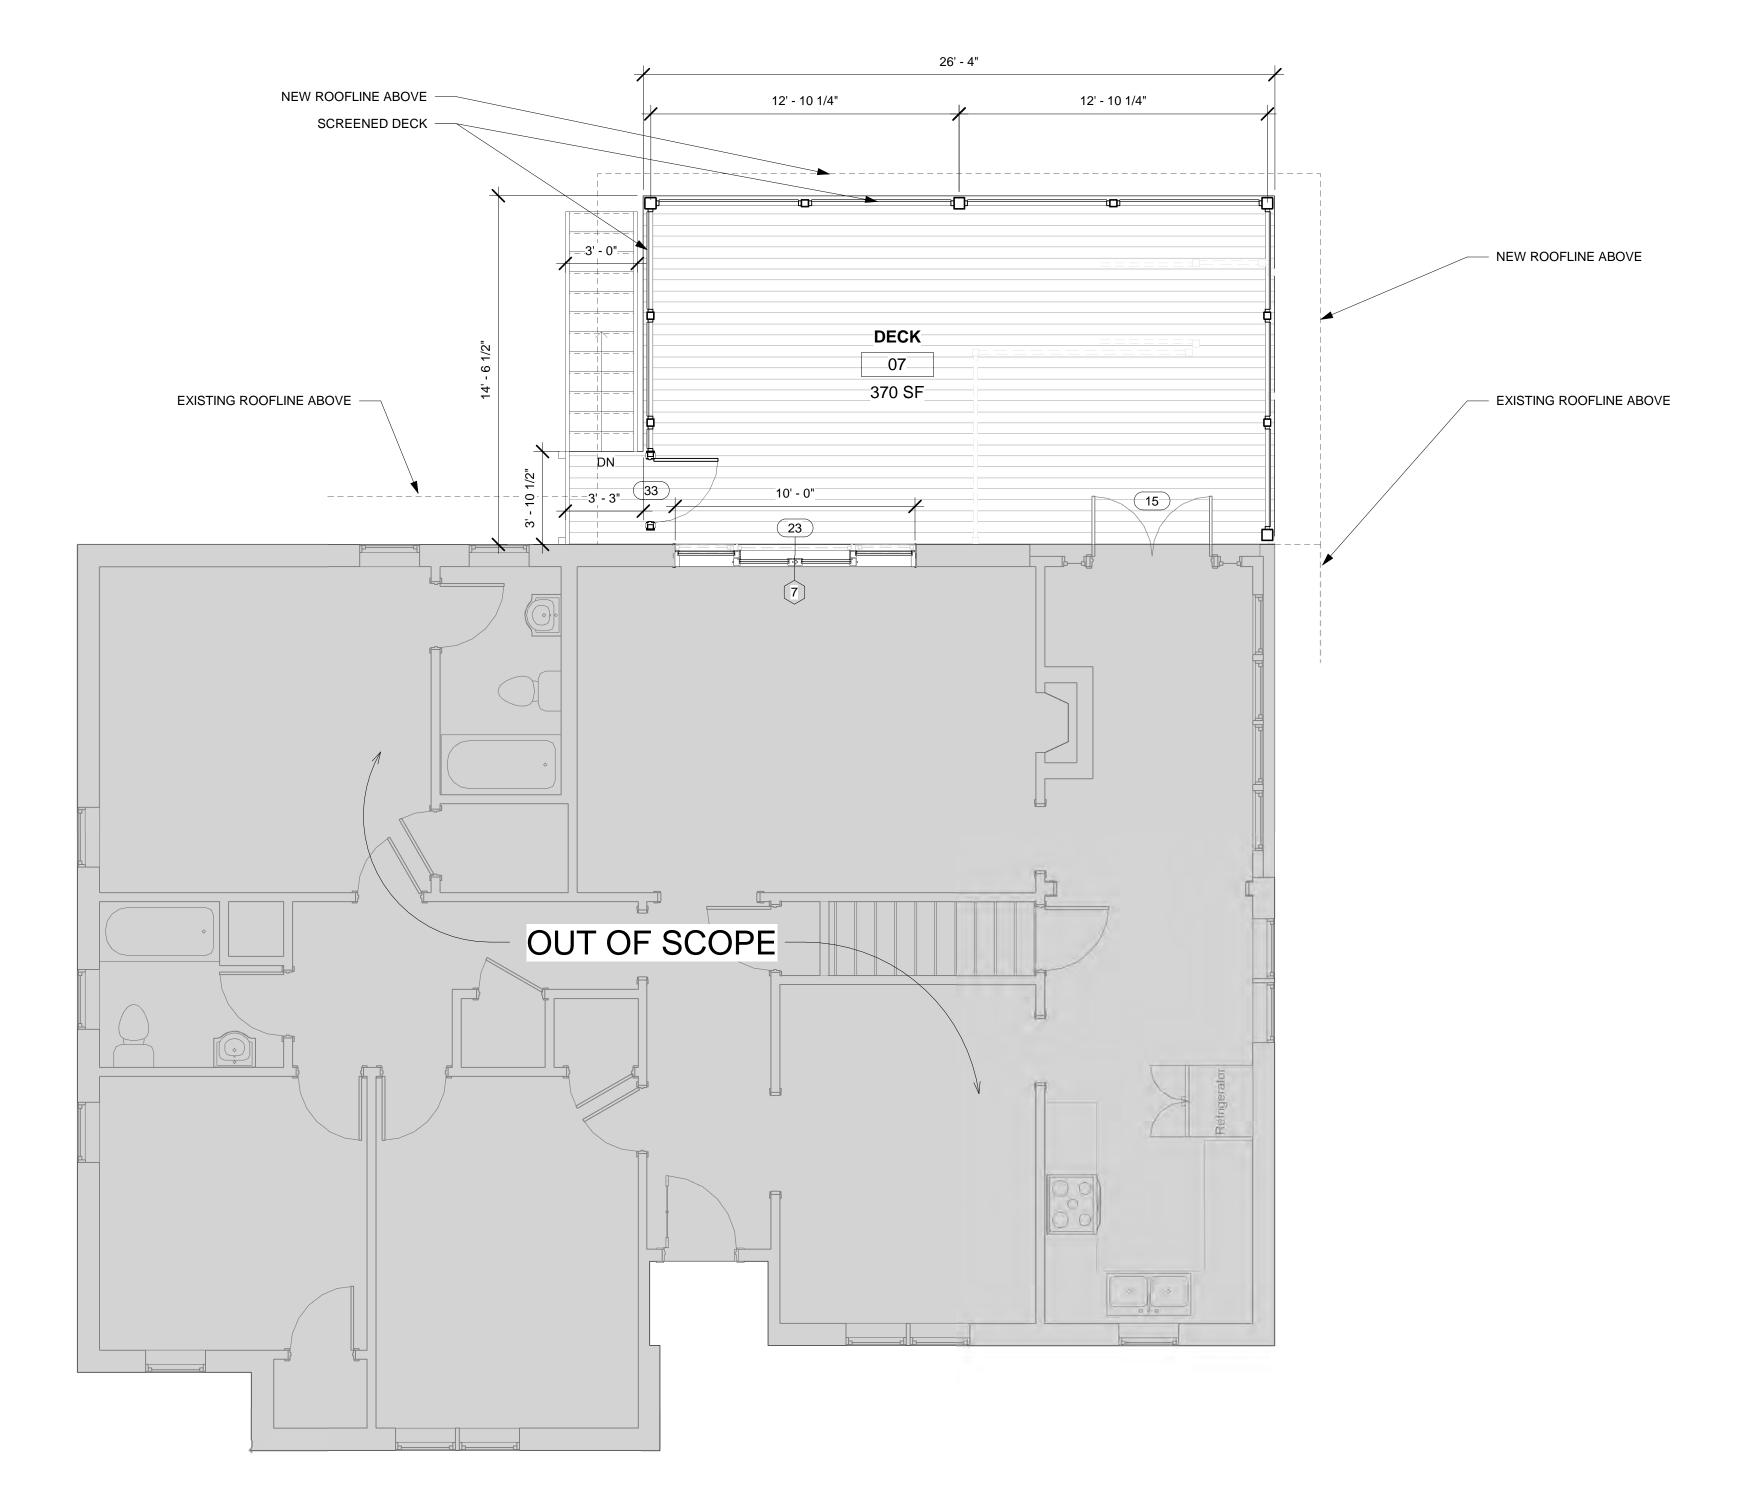
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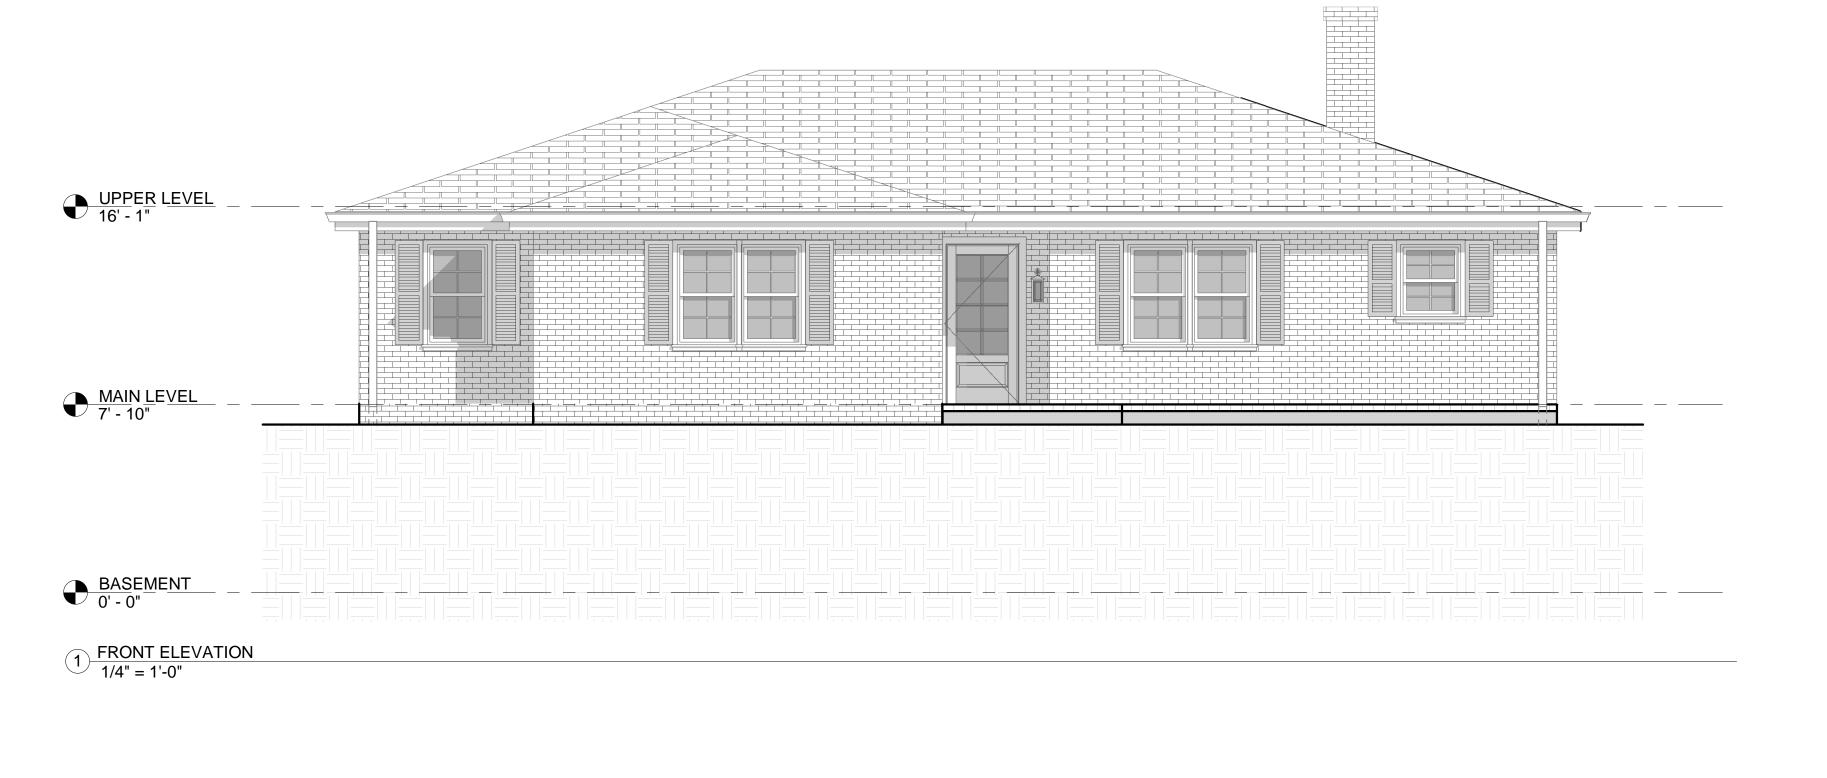
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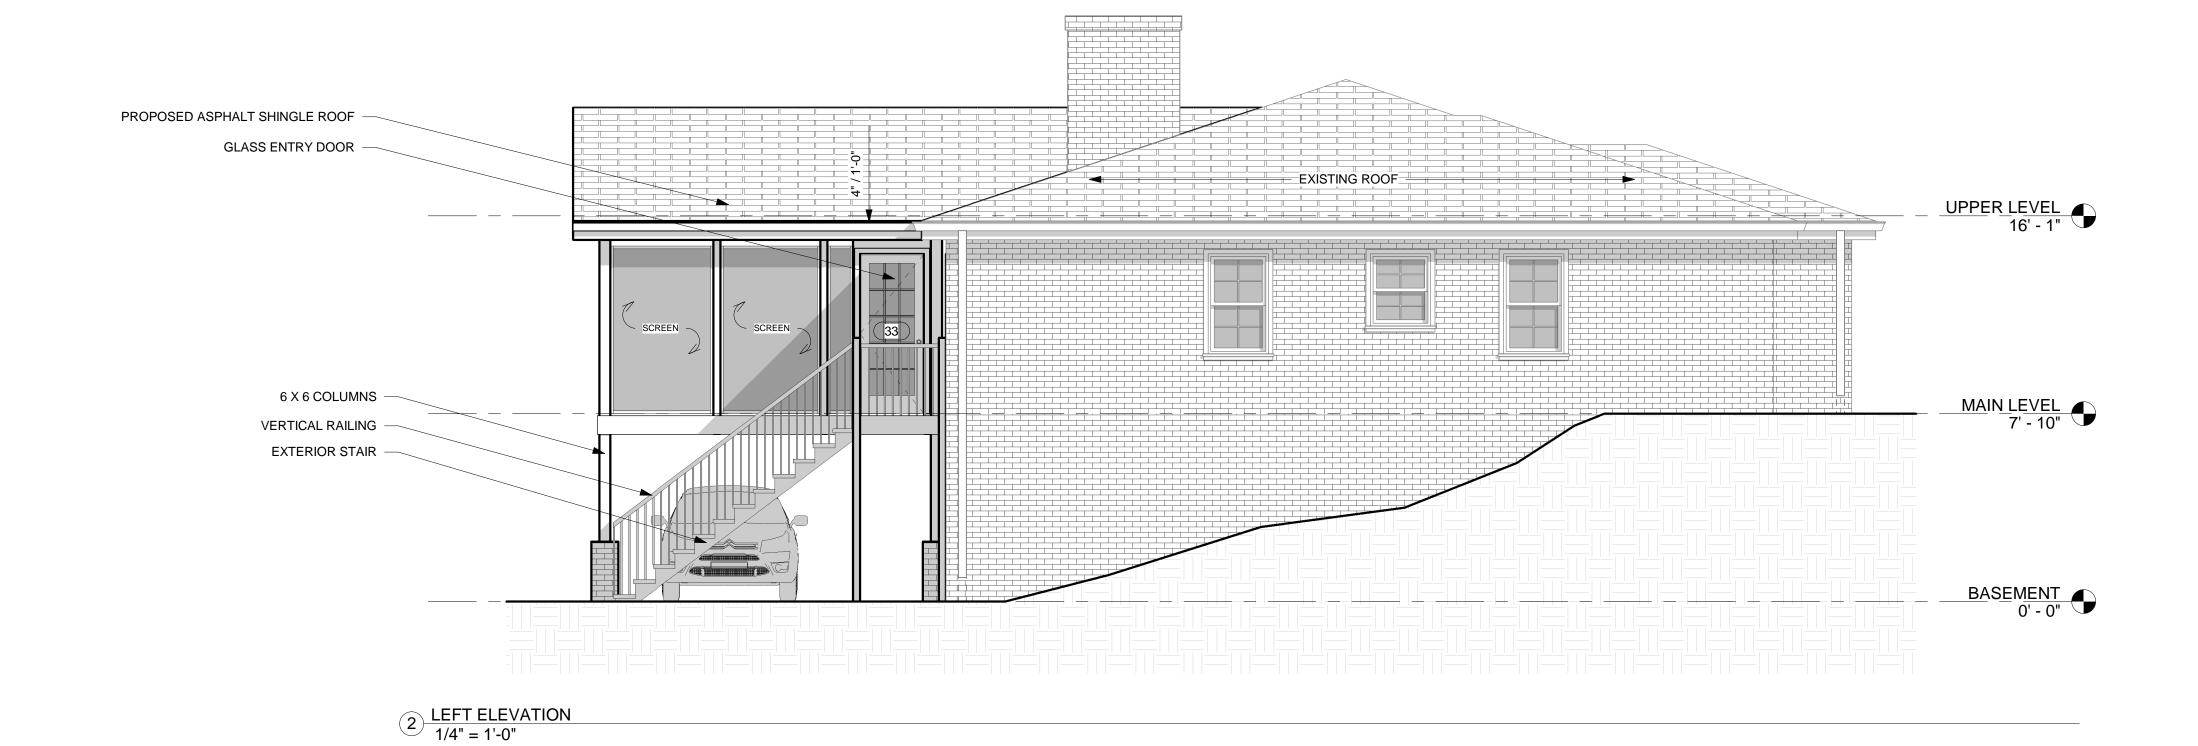
PROPOSED FLOOR PLANS


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Additional Approver

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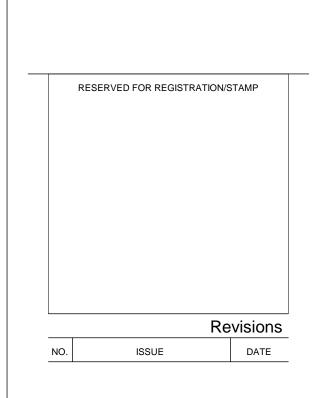
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PROPOSED **ELEVATIONS**

Sheet Information **A202**


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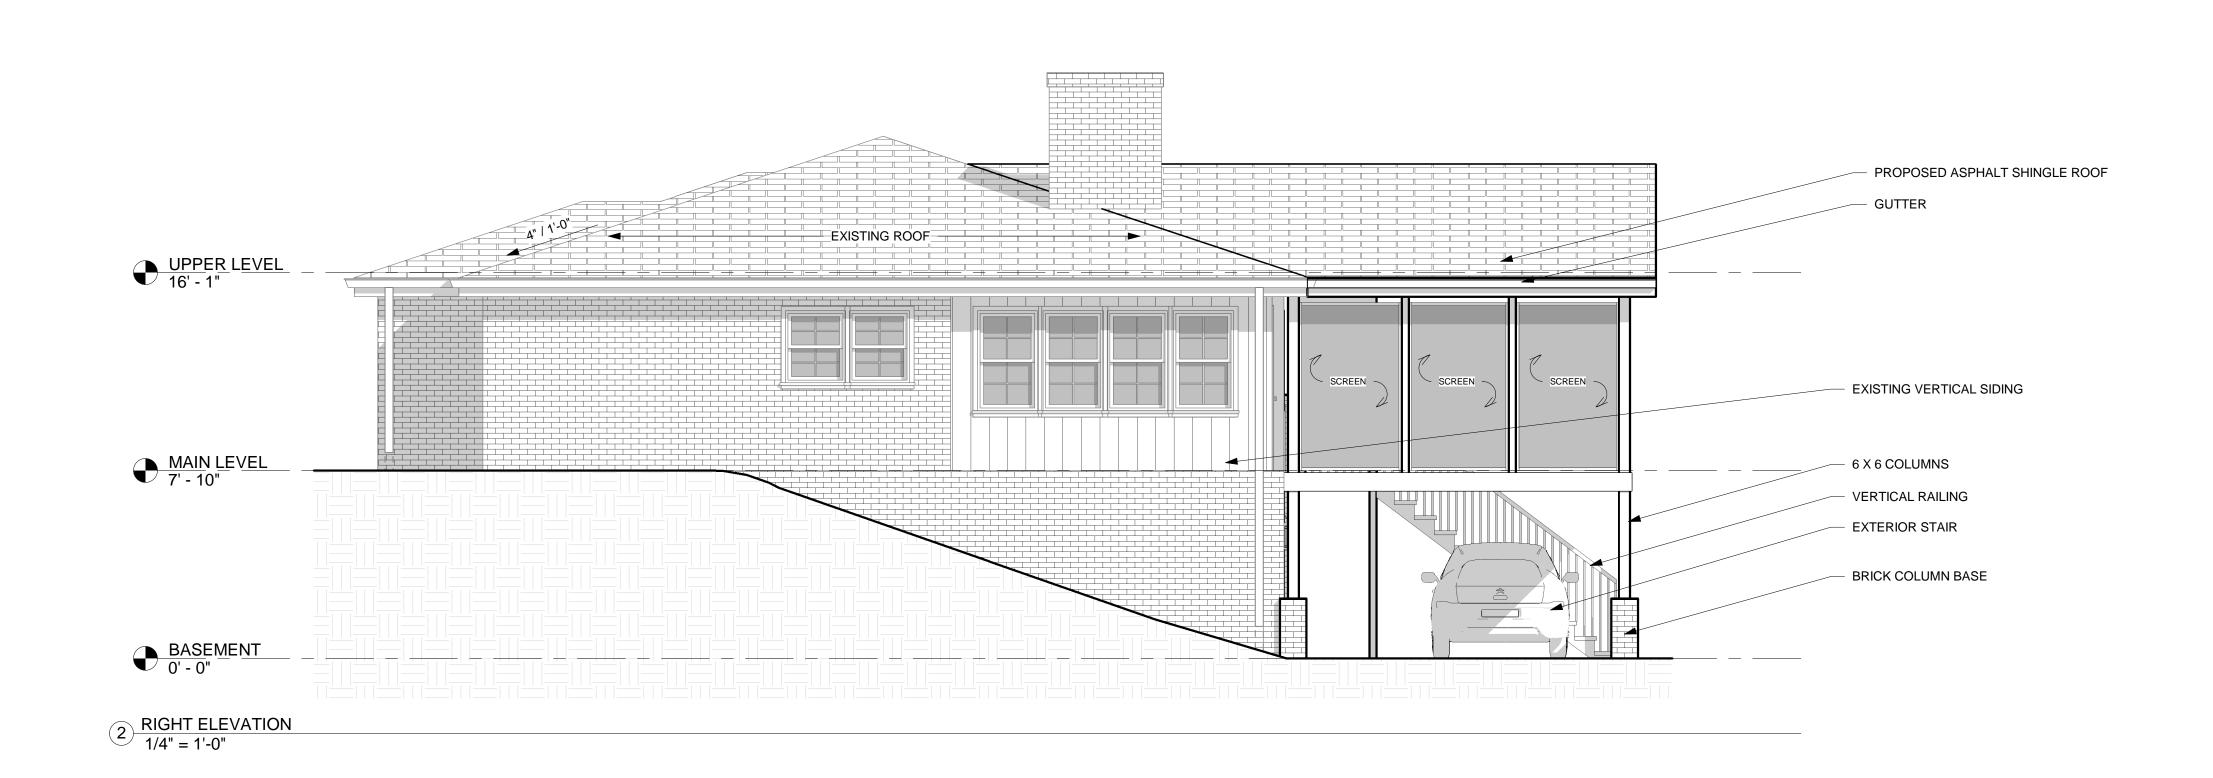
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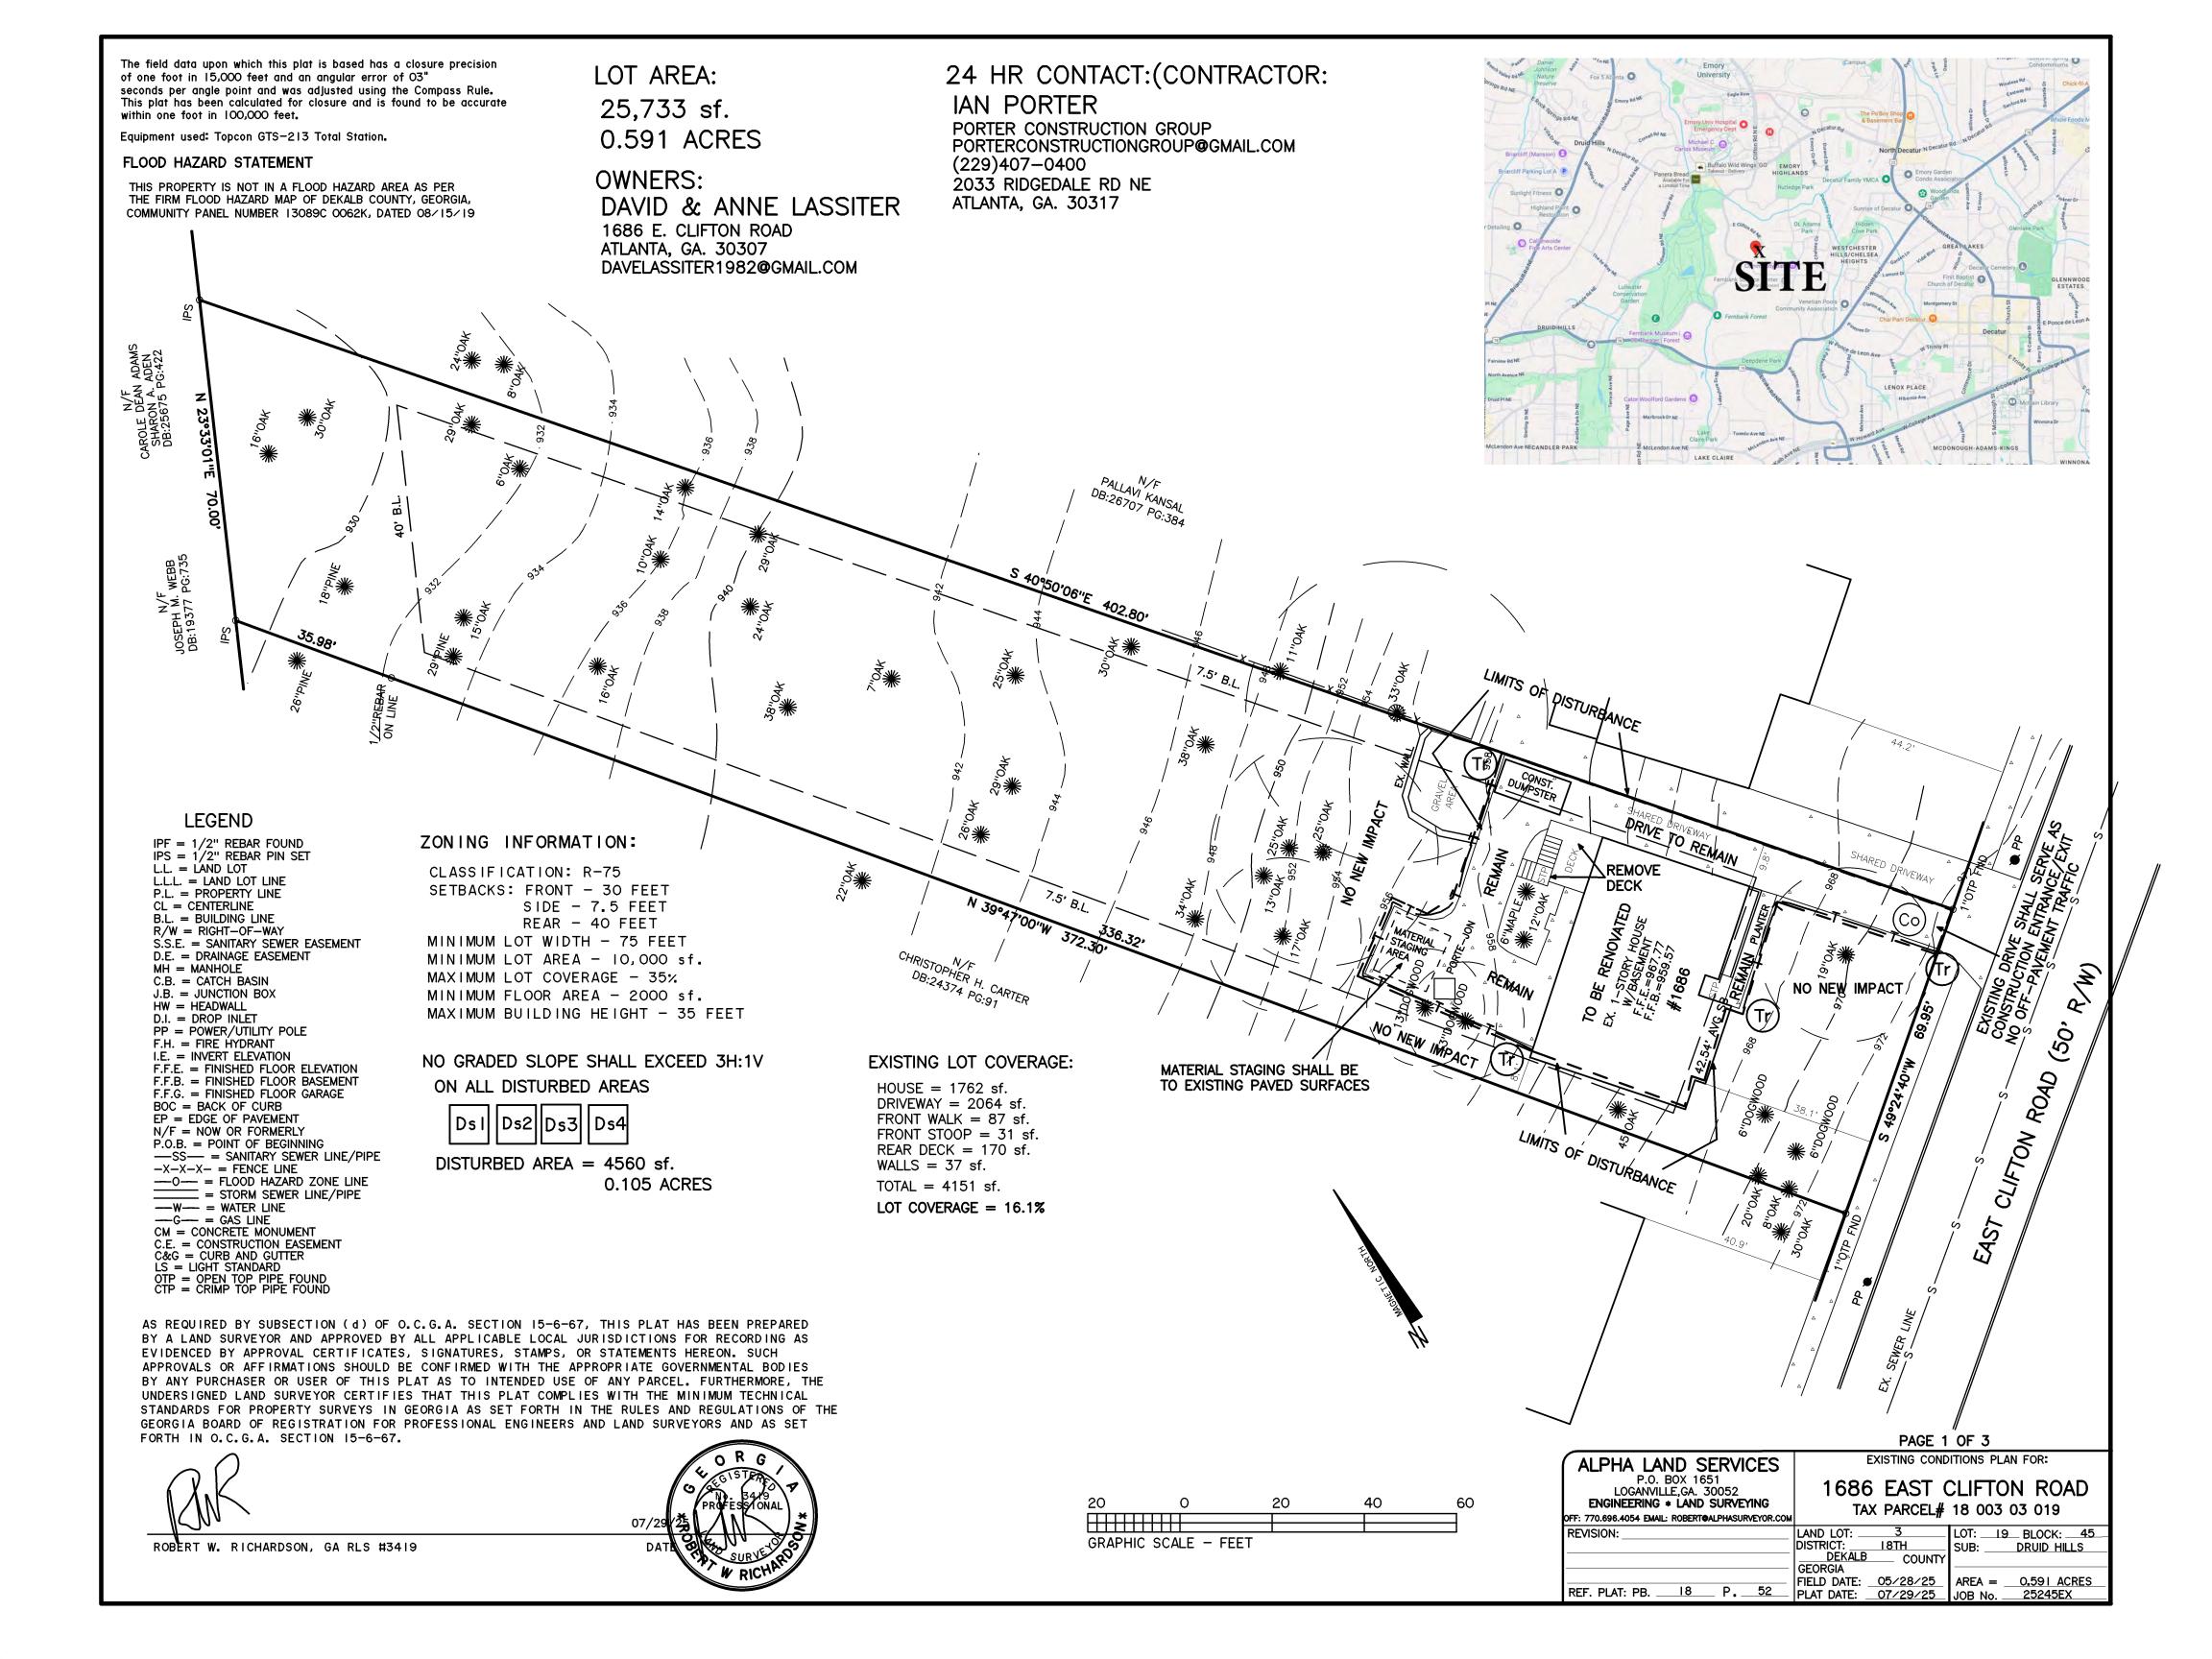



PROPOSED **ELEVATIONS** Sheet Information

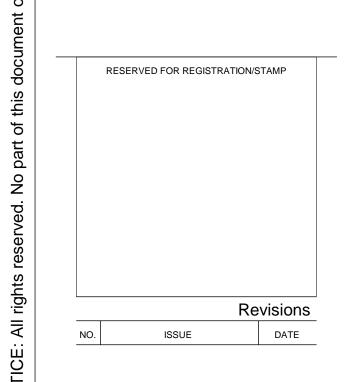A203





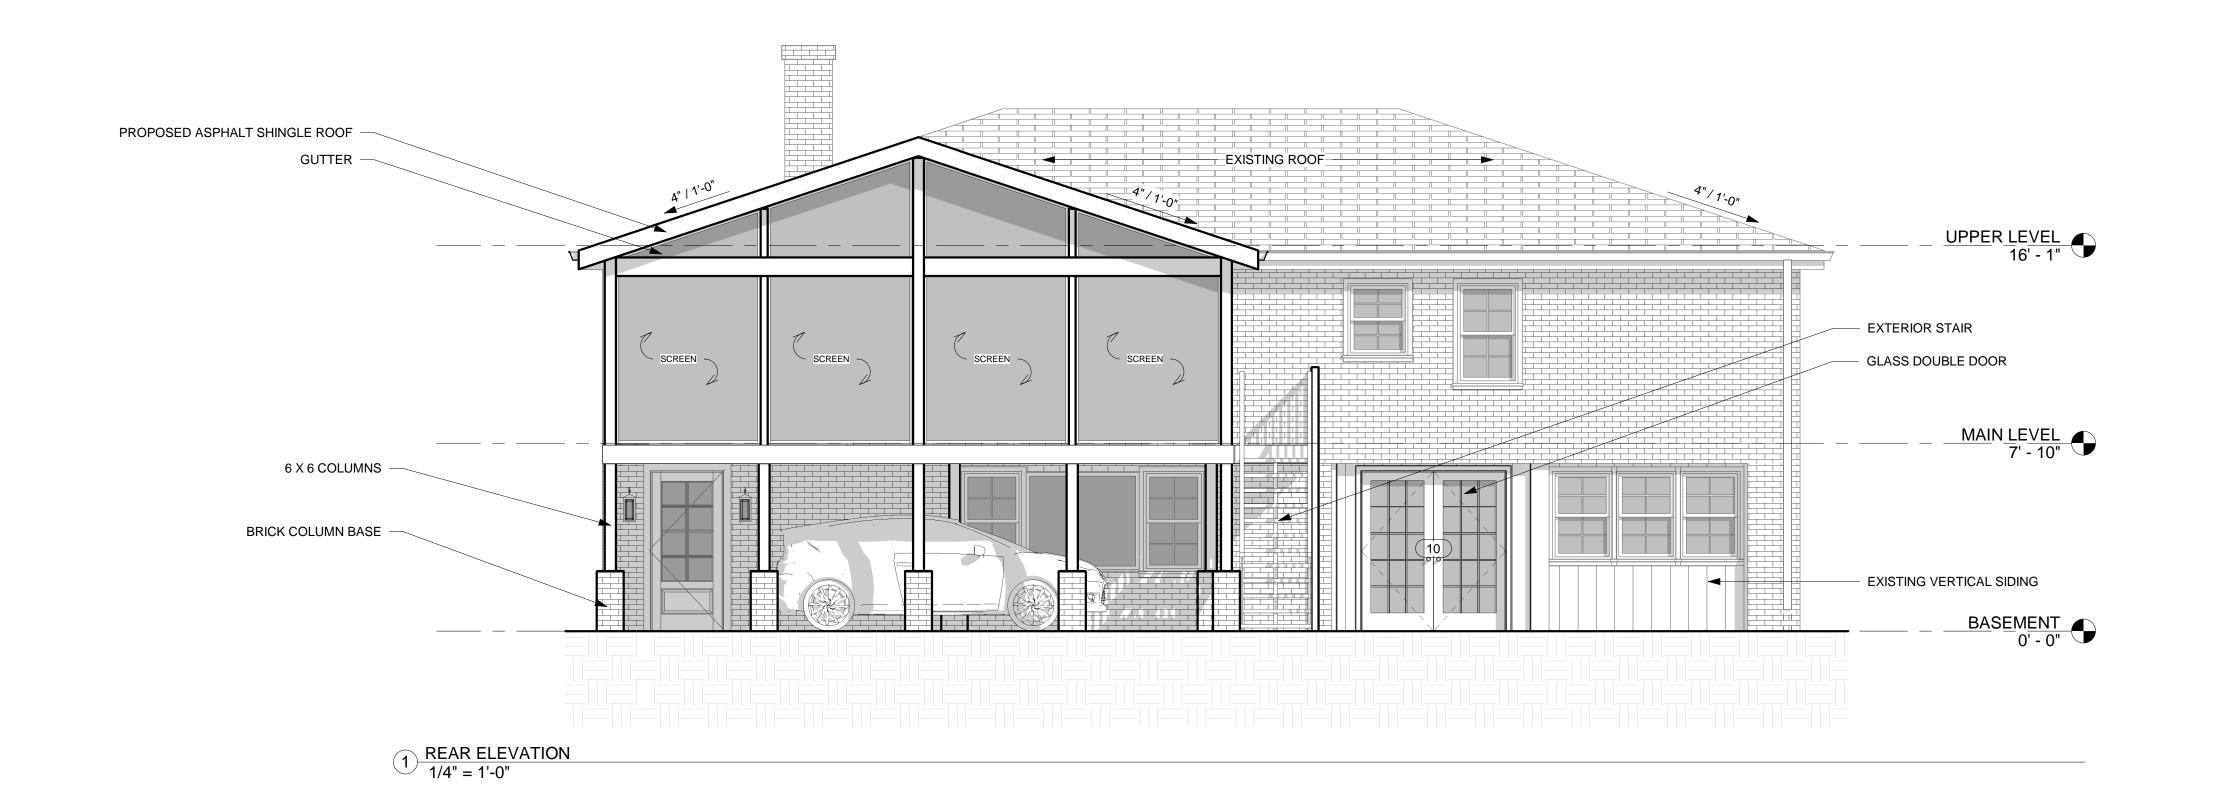

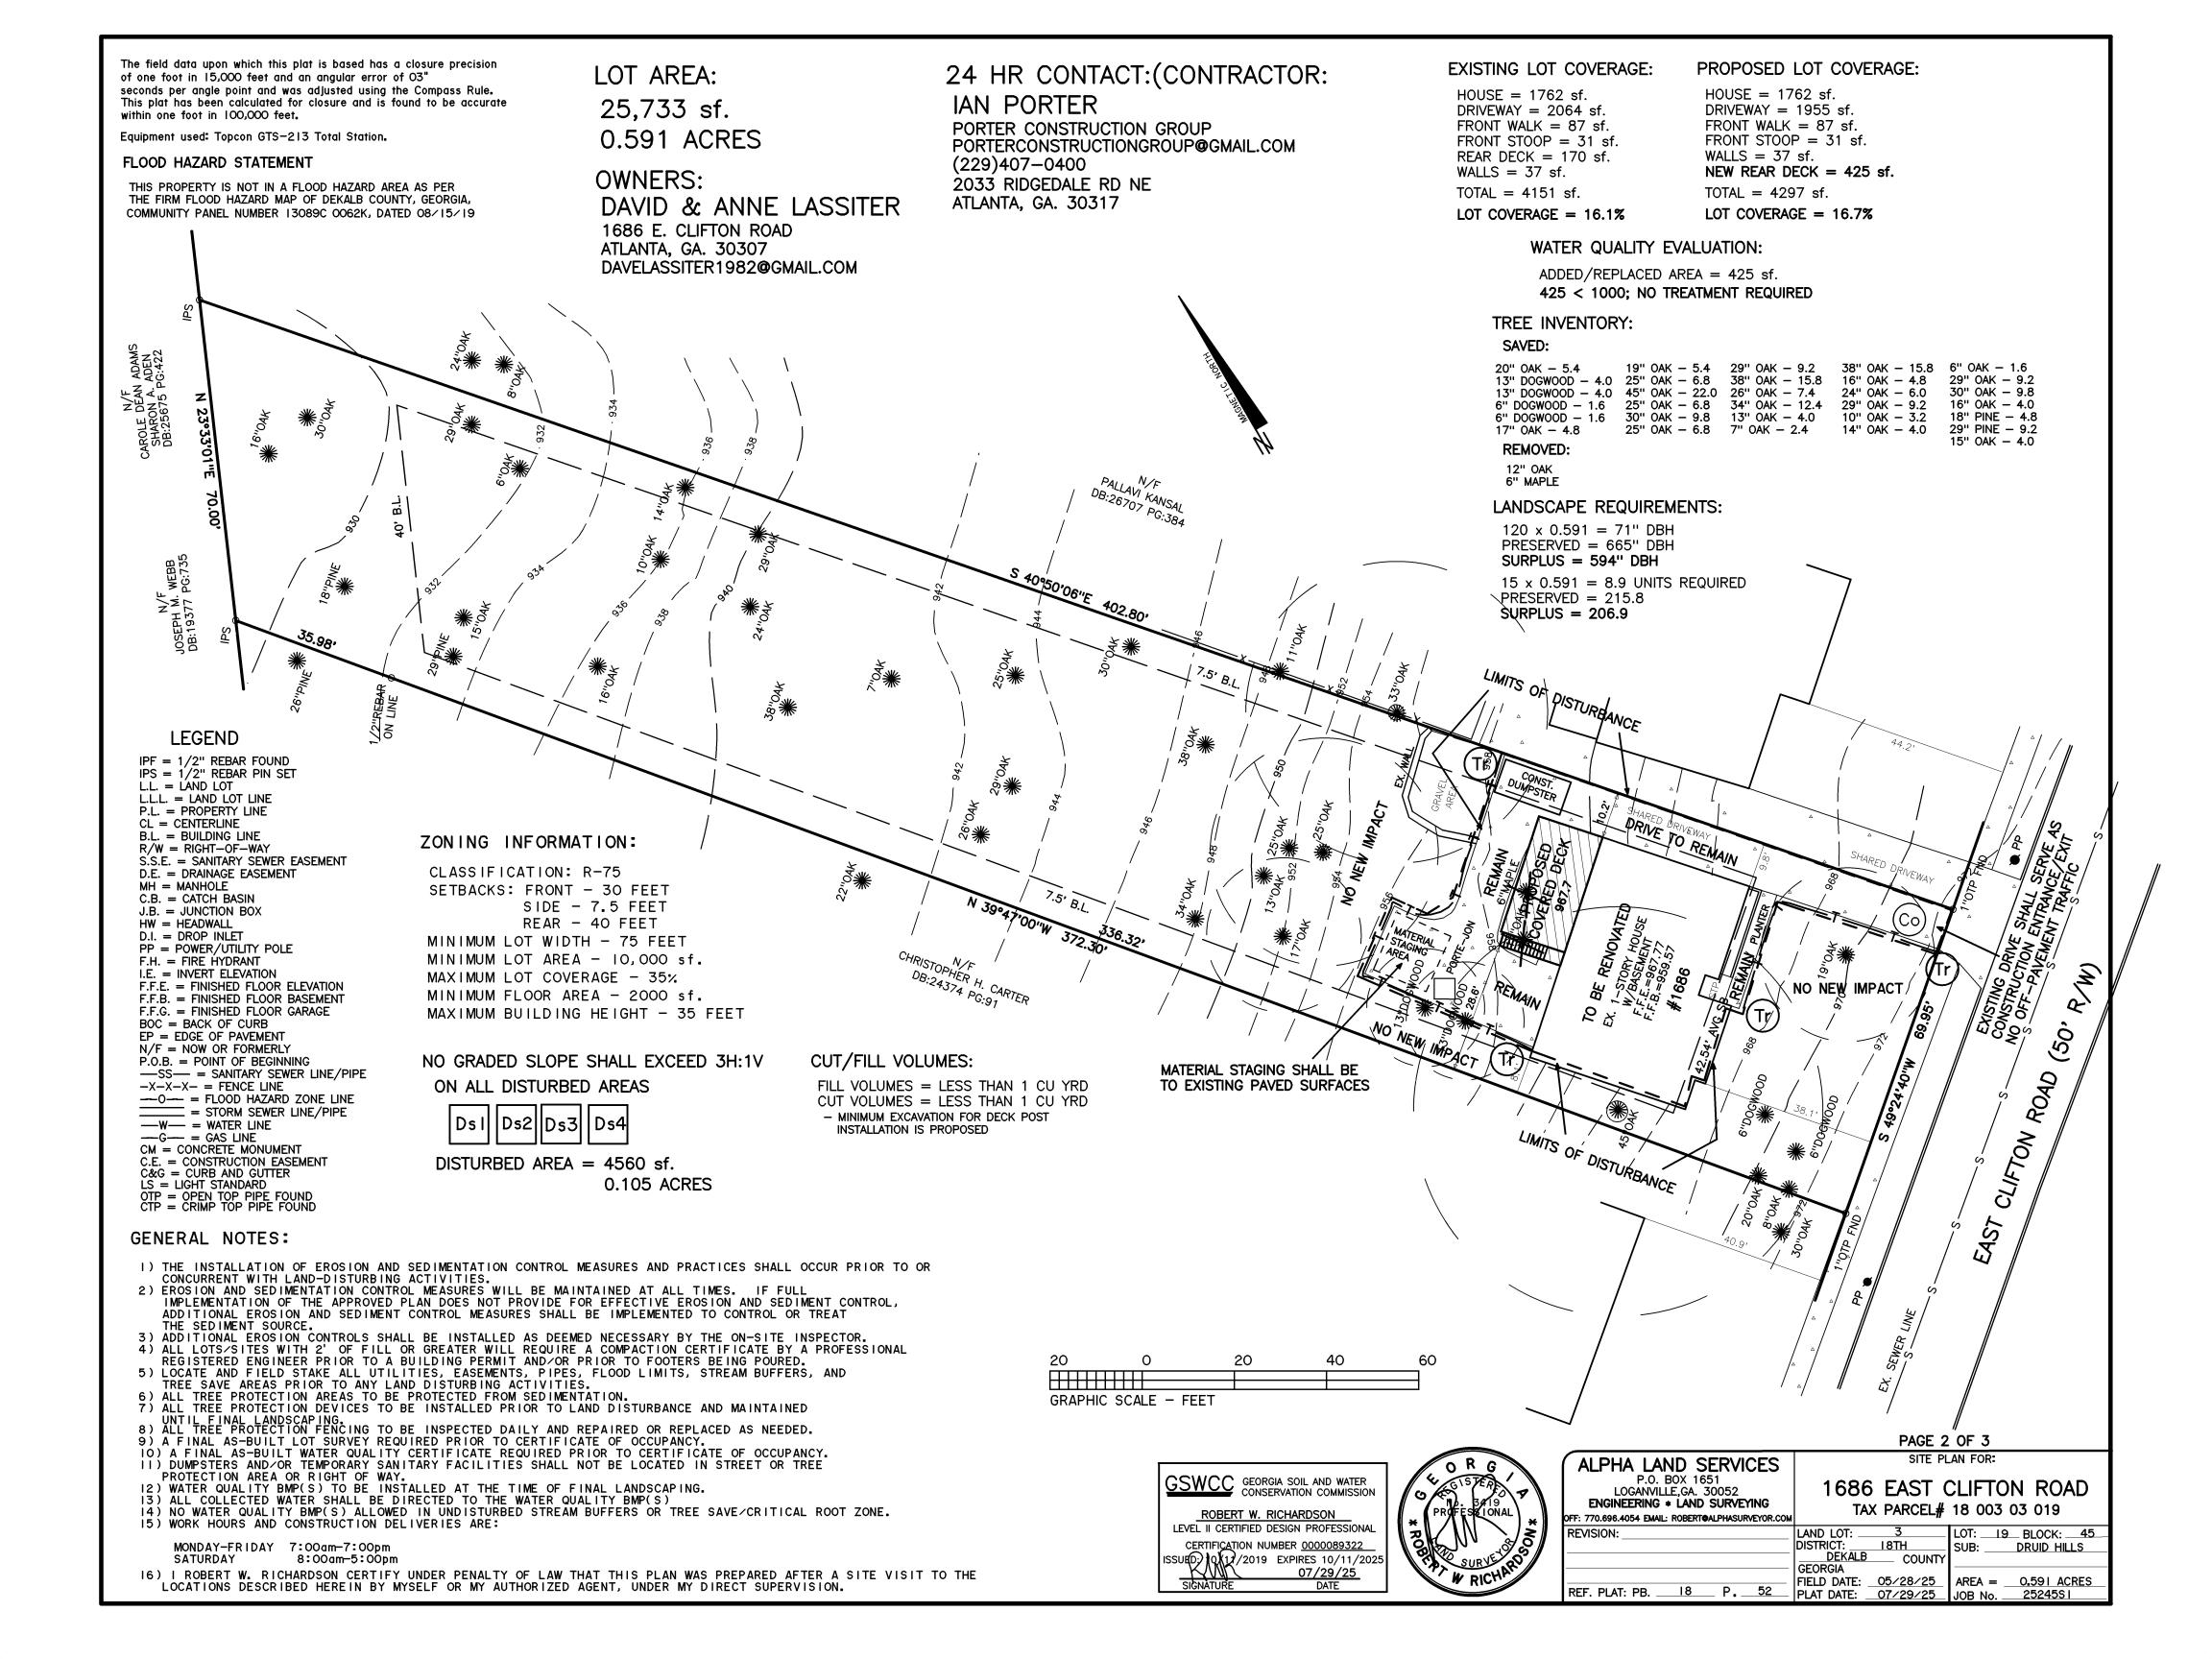

- INSTALLATION SPECIFICATIONS:
- INSTALLATION, PRODUCT SELECTION, AND MAINTENANCE SHALL BE IN ACCORDANCE WITH THE GSWCC MANUAL FOR EROSION AND SEDIMENT CONTROL IN GEORGIA.
- LOOSEN COMPACTED SOIL TO A MINIMUM DEPTH OF THREE (3) INCHES PRIOR TO APPLICATION.
- DRY STRAW OR HAY SHALL BE IN CLEAN CONDITION AND APPLIED BY
- HAND OR MACHINE TO A THICKNESS OF TWO (2) TO FOUR (2) INCHES. STRAW OR HAY MULCH SHALL BE ANCHORED IMMEDIATELY AFTER
- APPLICATION.

 MULCH ON SLOPES GREATER THAN 3% SHOULD BE ANCHORED WITH EMULSIFIED ASPHALT OR OTHER SUITABLE TACKIFIER.

 ADDITIONAL MULCHING IS REQUIRED IF THE MINIMUM THICKNESS IS NOT ACHIEVED OR IF SOIL COVERAGE IS LESS THAN 90%.

Ds1

DISTURBED AREA STABILIZATION WITH MULCHING

- INSTALLATION SPECIFICATIONS:

 1. INSTALLATION, SEED SELECTION, AND MAINTENANCE SHALL BE IN ACCORDANCE WITH THE GSWCC MANUAL FOR EROSION AND SEDIMENT
- ADDITIONAL EROSION CONTROL MEASURES MAY BE NECESSARY TO
- ADDITIONAL EROSION CONTROL MEASURES MAY BE NECESSARY TO ALLOW PROPER GERMINATION AND STABILIZATION.

 SOIL SURFACES MAY NEED TO BE TILLED, PITTED, OR OTHERWISE SCARIFIED TO ALLOW FOR PROPER SEED LODGING AND GERMINATION. APPLY LIME AT A RATE OF ONE TON PER ACRE AS NEEDED. APPLY 10-10-10 FERTILIZER TO SOILS WITH LOW FERTILITY AT A RATE OF 500 TO 700 POUNDS PER ACRE.

 SEEDS SHALL BE PLANTED AT A DEPTH OF TEN TIMES THE SEED DIAMETER.
- DIAMETER.

 ACCEPTABLE PLANTING METHODS INCLUDE HYDRO—SEEDING, DRILLING, AND BROADCAST SPREADING BY MACHINE OR HAND.

	PLANTING RA	a TEC		TY	PIC	ДL	FL	,4М	TIA	ŀĢ	МО	WT	HS	
	PER ACRE		J.	F	М	А	М	Ĵ	Ú	A	23	0	N	D
BARLEY	144	LBS								Ж	ж	Х	х	Х
ANNUAL LESPEDEZA	40	LØS	ж	ж	×	×								
WEEPING LOVEGRASS	4	LØS		ж	Ж	ж	Ж	Ж						
BROWNTOP MILLET	40	LBS				ж	Ж,	ж,	ж					
OATS .	128	LBS									ж	Х	ж	
RYE	168	LØ5								Ж	ж	Х	х	Х
ANNUAL RYEGRASS	40	LBS	æ	ж	ж					Ж	ж	х	х	х
SUDANGRASS	60	LBS			Ж	ж	ж	Ж	ж	Ж				
WHEAT	180	LBS									ж	х	х	х

* PLANTING RATES SHOWN ARE FOR BROADCAST APPLICATIONS. REDUCE

Ds2

DISTURBED AREA STABILIZATION WITH TEMPORARY SEEDING

MATERIALS

- Sod selected should be certified. Sod grown in the general area of the project is desirable. Sod should be machine cut and contain 3/4" (+ or - 1/4") of soil, not including shoots or
- ±5%. Torn or uneven pads should be rejected. Sod should be cut and installed within 36 hours
- Avoid planting when subject to frost heave or hot weather, if irrigation is not available.
- The sod type should be shown on the plans or installed according to Table 2. See page 60 for your Resource Area.

Table 2. Sod Planting Requirements								
Grass	Varieties	Resource Area	Growing Season					
Bermudagrass	Common Tifway Tifgreen Tiflawn	M-L, P,C P,C P,C P,C	Warm weather					
Bahiagrass	Pensacola	P,C	Warm weather					
Centipede	:11311000144411	P,C	Warm weather					
St. Augustine	Common Bitterblue Raleigh	^c	Warm weather					
Zoysia	Emerald Myer	P,C	Warm weather					
Tall Fescue	Kentucky 31	M-L, P	Cool weather					

MAINTENANCE

- Re-sod areas where an adequate stand of sod is not obtained.
- New sod should be mowed sparingly. Grass height should not be cut less than 2"-3" or as
- Apply one ton of agricultural lime as indicated

of trash, woody debris, stones and clods larger than 1". Apply sod to soil surfaces only and not frozen surfaces, or gravel type soils.

Topsoil properly applied will help guarantee a stand. Don't use topsoil recently treated with herbicides or soil sterilants.

Bring soil surface to final grade. Clear surface

- Mix fertilizer into soil surface. Fertilize based on soil tests or Table 1. For fall planting of warm season species, half the fertilizer should be applied at planting and the other half in the
- Sod should be cut to the desired size within . Agricultural lime should be applied based on soil tests or at a rate of 1-2 tons/acre.
 - · Lay sod with tight joints and in straight lines. Don't overlap joints. Stagger joints and do not

Table	1,	Fertilizer	Requirements	for	Soil
		Surface	Application		

Fertilizer Type (lbs./acre)	Fertilizer Rate (lbs./sq.ft.)	Fertilizer Rate	Season
10-10-10	1000	.025	Fall


- · On slopes steeper than 3:1, sod should be anchored with pins or other approved methods.
- · Installed sod should be rolled or tamped to provide good contact between sod and soil.
- · Irrigate sod and soil to a depth of 4" immediately after installation.
- · Sod should not be cut or spread in extremely wet or dry weather.


· Irrigation should be used to supplement rainfall

for a minimum of 2-3 weeks. · Fertilize grasses in accordance with soil tests

Tab	Table 3. Fertilizer Requirements for Sod											
Types of Species	Plainting Year	Fortilizer (N-P-K)	Rate (lbs./acre)	Nitrogen Top Oressing Rate (lbs./acre)								
Cool season grasses	First Second Maintenance	6-12-12 6-12-12 10-10-10	1500 1000 400	50-100 30								
Warrn	First	6-12-12	1500	50-100 50-100								

SILT FENCE Sd1-NS (TYPE A and B)

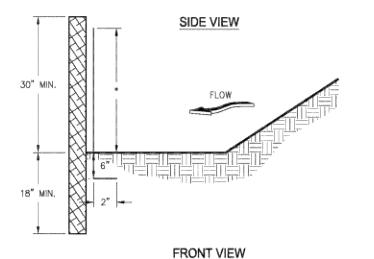

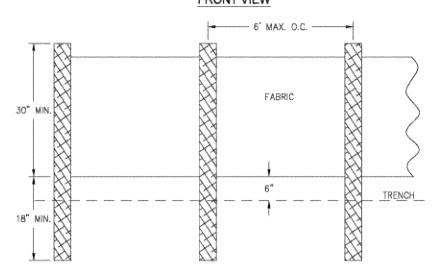

NOTES:
1. USE STEEL OR WOOD POSTS OR AS SPECIFIED BY THE EROSION, SEDIMENTATION,

HEIGHT (*) IS TO BE SHOWN ON THE EROSION, SEDIMENTATION, AND POLLUTION CONTROL PLAN.


Figure 6-27.1 GSWCC 2016 Edition

MAINTENANCE

The exit shall be maintained in a condition which will prevent tracking or flow of mud onto public rights-of-way. This may require periodic top dressing with 1.5-3.5 inch stone, as conditions demand, and repair and/or cleanout of any structures to trap sediment. All materials spilled,

dropped, washed, or tracked from vehicles or site onto roadways or into storm drains must be removed immediately.

CRUSHED STONE CONSTRUCTION EXIT

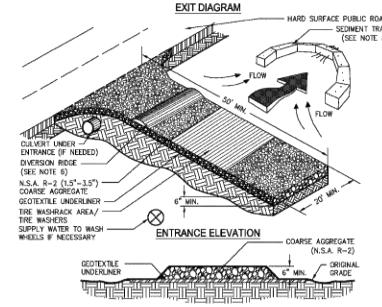

6-141

- NOTES:

 1. AVOID LOCATING ON STEEP SLOPES OR AT CURVES ON PUBLIC ROADS.

 2. REMOVE ALL, VEGETATION AND OTHER UNSUITABLE MATERIAL, FROM THE FOUNDATION AREA, GRADE, AND CROWN FOR POSITIVE DRAINAGE.

 3. AGGREGATE SIZE SHALL BE IN ACCORDANCE WITH NATIONAL STONE ASSOCIATION R-2 (1.5"-3.5" STONE).
- 5. AGENERATE SEZE SHALL BE IN ADJUNDANCE WITH NATIONAL STONE ASSOCIATION N=2 (1.5 = 5.5 STONE).
 4. GRAVEL PAD SHALL HAVE A MINIMUM THICKNESS OF 6".
 5. PAD WIDTH SHALL BE EQUAL FULL WIDTH AT ALL POINTS OF VEHICULAR EGRESS, BUT NO LESS THAN 20".
 6. A DIVERSION RIDGE SHOULD BE CONSTRUCTED WHEN GRADE TOWARD PAVED AREA IS GREATER THAN 2%.
 7. INSTALL PIPE UNDER THE ENTRANCE IF NEEDED TO MAINTAIN DRAINAGE DITCHES.
 8. WHEN WASHING IS REQUIRED, IT SHOULD BE DONE ON AN AREA STABILIZED WITH CRUSHED STONE THAT DRAINS INTO AN APPROVED SEDIMENT TRAP OR SEDIMENT BASIN (DIVERT ALL SURFACE RUNOFF AND DRAINAGE FROM THE ENTRANCE TO A SEDIMENT CONTROL DEVICE).

 9. WASHBACKS AND 70 THE WASHESSES MAY BE DROWNED OF DEPENDING ON SCALE AND CRECIMENTANCE IF
- WASHRACKS AND/OR TIRE WASHERS MAY BE REQUIRED DEPENDING ON SCALE AND CIRCUMSTANCE. IF NECESSARY, WASHRACK DESIGN MAY CONSIST OF ANY MATERIAL <u>SUITABLE</u> FOR TRUCK TRAFFIC THAT
- 10. MAINTAIN AREA IN A WAY THAT PREVENTS TRACKING AND/OR FLOW OF MUD ONTO PUBLIC RIGHTS-OF-WAYS. THIS MAY REQUIRE TOP DRESSING, REPAIR AND/OR CLEANOUT OF ANY MEASURES USED TO TRAP SEDIMENT.

Figure 6-14.1

6-142 GSWCC (Amended - 2013)

- INSTALLATION, SEED SELECTION, AND MAINTENANCE SHALL BE IN ACCORDANCE WITH THE GSWCC MANUAL FOR EROSION AND SEDIMENT CONTROL IN GEORGIA.
- PERMANENT VEGETATION SHALL INCLUDE GROUND PREPARATION, LIMING, FERTILIZING, SEEDING, AND MULCHING.
- INTERIM EROSION CONTROL MEASURES SHALL REMAIN IN PLACE UNTIL
- AT LEAST 70% OF THE EXPOSED SURFACE IS SUFFICIENTLY STABILIZED. PREPARE THE LAND FOR SEEDING BY APPLYING LIME AND FERTILIZER AND DISKING THE SURFACE TO A MAXIMUM DEPTH OF FOUR (4) INCHES. FINISHED SURFACE SHALL BE SMOOTH, UNIFORM, AND FREE OF DEBRIS
- SUCH AS TRASH, ROCKS, ROOTS, AND WEEDS. MULCH SHALL BE APPLIED UNIFORMLY WITHIN 24 HOURS OF SEEDING. REFER TO THE MANUAL FOR EROSION AND SEDIMENT CONTROL IN GEORGIA FOR ADDITIONAL PLANTING SPECIFICATIONS AND ALTERNATIVE VEGETATIVE COVER SUCH AS TREES AND SHRUBS.

	PLANTING RATES		TY	PIC	AL	PL	.Ah	TIM	lG.	MC	WT	H5	
SPECIES	PER ACRE*	J.	F	М	А	М	J	"J	Д	123	O	Ν	Ľ
BAHIA	60 LBS	ж	ж	ж	х	х	ж	х	ж	х	ж	ж)
BERMUDA (HULLED)	10 <i>LB</i> S		ж	ж	ж	х	Ж,						
BERMUDA (UNHULLED)	10 LBS	х	ж								X	ж	
TALL FESCUE	50 <i>LB</i> S			х	х				×	х	×	ж	
WEEPING LOVEGRASS	4 <i>LB</i> S			ж	Х	х	ж						
SERICEA LESPEDEZA	60 LBS		ж	Х	Х	X	Х						

* PLANTING RATES SHOWN ARE FOR BROADCAST APPLICATIONS. REDUCE THESE RATES BY 50% FOR SEED DRILLING.


LIME AND FERTILIZER APPLICATION:

- GRADED AREAS REQUIRE LIME APPLICATION.
- AGRICULTURAL LIME SHALL BE APPLIED AT A RATE OF ONE (1) TO TWO (2) TONS PER ACRE UNLESS SOIL TESTS SUGGEST OTHERWISE. REPEAT APPLICATION EVERY FIVE (5) YEARS OR AS NEEDED.

TYPE OF SPECIES	PLANTING YEAR	RECOMMENDED N-P-K	FERTILIZER RATE PER ACRE
	*	6-12-12	1500 LBS
COOL SEASON GRASSES	2	6-12-12	1000 LBS
	MAINTENANCE	10-10-10	400 LBS
COOL SEASON	**	6-12-12	1500 LBS
GRASSES AND	2	0-12-12	1000 LBS
LEGUMES	MAINTENANCE	0-10-10	400 LBS
	1	6-12-12	1500 LBS
WARM SEASON GRASSES	2	6-12-12	800 LBS
SWEET TOO SET WELL THAT	MAINTENANCE	10-10-10	400 LBS
WARM SEASON	į	6-12-12	1500 LBS
GRASSES AND	2	0-10-10	1000 LBS
LEGUMES	MAINTENANCE	0-10-10	400 LBS

* PERMANENT SEEDING MAY BE SUBSTITUTED WITH SODDING (Ds4) AT THE DISCRETION OF THE PROPERTY OWNER AND LOCAL INSPECTOR.

DISTURBED AREA STABILIZATION Ds3WITH PERMANENT SEEDING

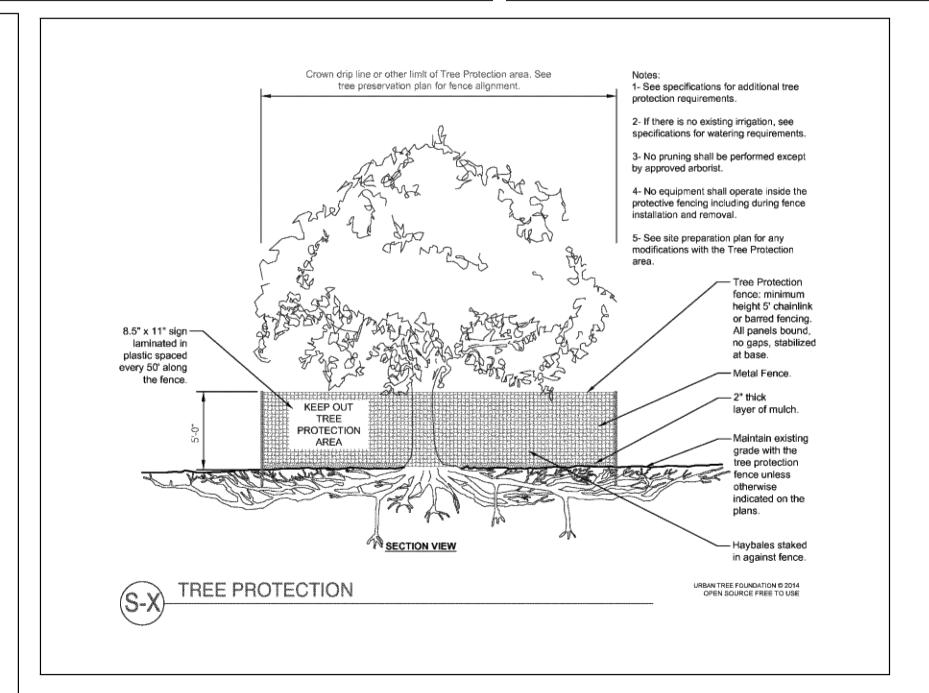

GSWCC GEORGIA SOIL AND WATE CONSERVATION COMMISSI ROBERT W. RICHARDSON LEVEL II CERTIFIED DESIGN PROFESS CERTIFICATION NUMBER 00000893

SSUED: 10/11/2019 EXPIRES 10/11

07/29/25 DATE

ALPHA LAND SERVICES P.O. BOX 1651 LOGANVILLE, GA. 30052 ENGINEERING * LAND SURVEYING FF: 770.696.4054 EMAIL: ROBERT@ALPHASURVEYOR.CO

NOTES & DETAILS FOR:

1686 EAST CLIFTON ROAD TAX PARCEL# 18 003 03 019

PAGE 3 OF 3

REVISION: LAND LOT: LOT: 19 BLOCK: 45 DISTRICT: 18TH SUB: DRUID HILLS DEKALB COUNTY GEORGIA AREA = 0.591 ACRESFIELD DATE: 05/28/25 REF. PLAT: PB. 18 P. 52 PLAT DATE: 07/29/25 JOB No. 25245S2